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LIST OF DISTRICT 1 STANDARD DETAILS

- 17.) BE-301 LIGHT POLE FOUNDATION 40' (12.192m) TO 47 1/2' (14.478m) M.H. 15" (381mm) BOLT CIRCLE
- 18.) BE-310 LIGHT POLE FOUNDATION OFFSET 40' (12.192m) TO 47 1/2' (14.478m) M.H. 15" (381mm) BOLT CIRCLE
- 19.) BE-702 MISC. ELECTRICAL DETAILS, SHEET A
- 20.) TC-10 TRAFFIC CONTROL & PROTECTION FOR SIDE ROADS, INTERSECTIONS & DRIVEWAYS
- 21.) TC-22 ARTERIAL ROAD INFORMATION SIGN

LIST	OFI
000001-08	STANDAR
701101-05	OFF-RD
701427-05	LANE CLOS
701601-09	URBAN L
701606-10	URBAN S
701701-10	URBAN L
701801-06	SIDEWALK
701901-10	TRAFFIC

836001-05

GENERAL CONSTRUCTION NOTES ROADWAY STREET LIGHTING

SPECIFICATIONS

THE JANUARY 1, 2022 EDITION OF THE "STANDARD SPECIFICATIONS FOR ROAD AND BRIDGE CONSTRUCTION", THE JANUARY 1, 2025 EDITION OF THE "SUPPLEMENTAL SPECIFICATIONS AND RECURRING SPECIAL PROVISIONS", PREPARED BY THE ILLINOIS DEPARTMENT OF TRANSPORTATION AND THE 11TH EDITION DATED DECEMBER 2023 OF THE "MANUAL OF UNIFORM TRAFFIC CONTROL DEVICES" SHALL GOVERN ALL WORK ASSOCIATED WITH THIS PROJECT.

NOTIFICATION OF PUBLIC UTILITIES

PRIOR TO STARTING CONSTRUCTION, THE CONTRACTOR SHALL NOTIFY THE OFFICIALS OF THE PUBLIC WORKS DEPARTMENT OF THE LOCAL MUNICIPALITY, J.U.L.I.E. AT 1-800-892-0123 OR 811, AND OTHER PUBLIC AND PRIVATE UTILITIES SO THAT ARRANGEMENTS CAN BE MADE TO LOCATE THEIR VARIOUS FACILITIES WITHIN THE LIMITS OF CONSTRUCTION UNDER THIS CONTRACT, AS WELL AS TO PROVIDE ADEQUATE PROTECTION AND INSPECTION THERETO. IT SHALL BE THIS CONTRACTOR'S RESPONSIBILITY TO DETERMINE THE ACTUAL LOCATION OF ALL SUCH FACILITIES IN THE FIELD.

EXCAVATED MATERIALS

THE WASTE FROM THE TRENCH AND/OR FOUNDATION EXCAVATION INCLUDED UNDER THIS CONTRACT SHALL BE DISPOSED OF OFF SITE BY THE CONTRACTOR, UNLESS OTHERWISE DIRECTED BY THE ENGINEER. THE CONTRACT UNIT PRICE FOR "TRENCH AND BACKFILL" AND "CONCRETE FOUNDATION" OF THE SIZE INDICATED ON THE PLANS, SHALL INCLUDE THE DISPOSAL OF WASTE MATERIALS AS MAY OR MAY NOT BE DESIGNATED ABOVE, THEREFORE, AS A PROVISION THIS CONTRACT, THE CONTRACTOR WILL BE REQUIRED TO DISPOSE OF ALL SURPLUS MATERIALS OFF SITE AS WORK PROGRESSES. THE TEMPORARY STOCKPILING OF MATERIAL ON SITE WILL NOT BE ALLOWED.

TREES AND BRANCHES

WHERE OVERHANGING BRANCHES INTERFERE WITH OPERATIONS OF CONSTRUCTION, SAID BRANCHES SHALL BE TRIMMED AND SEALED IN ACCORDANCE WITH ARTICLE 253.09 OF THE "STANDARD SPECIFICATIONS FOR ROAD AND BRIDGE CONSTRUCTION", AND WILL BE PAID FOR IN ACCORDANCE WITH THE SPECIFICATIONS.

SAWING EXISTING IMPROVEMENTS

ALL PERMANENT TYPE PAVEMENTS OR OTHER PERMANENT IMPROVEMENTS WHICH ABUT THE PROPOSED IMPROVEMENT AND MUST BE REMOVED, SHALL BE SAWED AS DIRECTED PRIOR TO REMOVAL. ALL ITEMS SO REMOVED SHALL BE REPLACED WITH SIMILAR CONSTRUCTION MATERIALS TO THEIR ORIGINAL CONDITION OR BETTER. EXISTING DRIVEWAY PAVEMENT AND SIDEWALK TO REMAIN IN PLACE SHALL BE SAWCUT TO PROVIDE A NEAT VERTICAL FACE BETWEEN THE PROPOSED AND THE EXISTING.

PROJECT SAFETY

THE CONTRACTOR SHALL COMPLY WITH AND OBSERVE THE RULES AND REGULATIONS OF O.S.H.A. AND APPROPRIATE AUTHORITIES REGARDING SAFETY PROVISIONS. THE CONTRACTOR, ENGINEER, AND OWNER SHALL EACH BE RESPONSIBLE FOR THEIR OWN RESPECTIVE AGENTS AND EMPLOYEES. THE ENGINEER AND OWNER ARE NOT RESPONSIBLE FOR THE CONSTRUCTION MEANS, METHODS, TECHNIQUES, SEQUENCES OR PROCEDURES, TIME OF PERFORMANCE, PROGRAMS, OR FOR ANY SAFETY PRECAUTIONS USED BY THE CONTRACTOR. THE CONTRACTOR IS SOLELY RESPONSIBLE FOR EXECUTION OF HIS WORK IN ACCORDANCE WITH THE DOCUMENTS AND SPECIFICATIONS.

RAILROAD FLAGGERS GENERAL NOTE

IT IS THE CONTRACTOR'S SOLE RESPONSIBILITY TO COORDINATE WITH THE CHICAGO, CENTRAL AND PACIFIC RAILROAD (CC&P RR) UNDER THE PARENT COMPANY OF THE CANADIAN NATIONAL RAILROAD (CN RR) WHENEVER CONSTRUCTION ACTIVITY IS WITHIN 25 FEET OF THE RAILROAD ROW. THE CONTRACTOR SHALL RETAIN FLAGMEN EMPLOYED AND DESIGNATED BY THE CANADIAN NATIONAL RAILROAD (CN RR) TO MONITOR ON-COMING TRAIN TRAFFIC AND ADVISE CONTRACTOR PERSONNEL WHEN ACTIVITY ON OR NEAR THE RAILROAD RIGHT-OF-WAY MAY PROCEED. THIS ITEM WILL BE PAID FOR ACCORDING TO ARTICLE 107.12 AND WILL BE REIMBURSED ACCORDING TO ARTICLE 109.05

	USER NAME =	DESIGNED - JEF	REVISED - 6-11-24		INDEX	OF SHEETS,	LIST OF	DISTRIC	CT 1 S
(FAU 2759) DES PLAINES AVENUE		drawn — JFP	REVISED - 7-9-24	STATE OF ILLINOIS		LIST OF ILLI	NOIS DO	T HIGHV	NAY
(FAU 1459) 26TH STREET TO (FAU 1453) CERMAK ROAD LED STREET LIGHTING	PLOT SCALE =	CHECKED – THK	REVISED - 7-11-24	DEPARTMENT OF TRANSPORTATION	GE	ENERAL CONS	STRUCTI	ION NOT	ES, L
#20072	PLOT DATE =	DATE - 2-22-24	REVISED - 10-25-24		SCALE: NONE	SHEET NO.	OF S	SHEETS	STA

- ENGINEER

- 9. ALL SIDEWALK REMOVAL AND REPLACEMENT SHALL BE SELECTED BY THE ENGINEER.

ILLINOIS DOT HIGHWAY STANDARDS

RD SYMBOLS, ABBREVIATIONS, AND PATTERNS OPERATIONS, MULTILANE, 15' TO 24" FROM PAVEMENT EDGE SURE, MULTILANE, INTERMITTENT OR MOVING OPERATION, FOR SPEEDS \leq 40 MPH ANE CLOSURE, MULTILANE, 1W OR 2W WITH NONTRAVERSABLE MEDIAN SINGLE LANE CLOSURE, MULTILANE, 2W WITH MOUNTABLE MEDIAN ANE CLOSURE, MULTILANE INTERSECTION , CORNER OR CROSSWALK CLOSURE CONTROL DEVICES LIGHT POLE FOUNDATION

LIGHTING NOTES

1. THE CONTRACTOR SHALL VERIFY ALL OF THE INFORMATION SHOWN IN THE CONTRACT PLANS WHICH AFFECT THE WORK UNDER THIS CONTRACT.

2. IT IS THE RESPONSIBILITY OF THE CONTRACTOR TO ASCERTAIN EXISTING FILED CONDITIONS BEFORE BIDDING ON THE PROJECT.

3. THE ENGINEER RESERVES THE RIGHT TO ADJUST THE LOCATIONS OF LIGHT POLES, CONDUIT PUSHES, TRENCH LINES, AND OTHER APPURTENANCES TO NEW LOCATIONS DEPENDING UPON THE LOCATION OF OTHER FACILITIES THAT MAY CONFLICT WITH THE NEW LIGHTING SYSTEM.

4. ALL LUMINAIRES SHALL BE ORIENTED WITH THE OPTICS PERPENDICULAR TO THE ROADWAY UNLESS OTHERWISE INDICATED OR DIRECTED BY THE

5. CONDUIT DUCTS SHALL BE INSTALLED AT A MINIMUM DEPTH OF 30" BELOW GRADE AND POSITIONED IN THE FIELD TO AVOID CONFLICT WITH ROADWAY UNDERDRAINS AND OTHER EXISTING AND PROPOSED UTILITIES. THE CONTRACTOR SHALL INCREASE DEPTH OF UNIT DUCT AND CONDUIT AS REQUIRED. THE CONTRACTOR SHALL COORDINATE RACEWAY DEPTH WITH THE ELECTRICAL DETAILS AND THE ENGINEER.

6. WHERE THE CONTRACTOR'S EXCAVATION MEETS AN OBSTRUCTION, THE CONTRACTOR SHALL NOTIFY THE ENGINEER FOR DIRECTION IN WRITING PRIOR TO EXCAVATION. IF DAMAGE OCCURS, THE CONTRACTOR SHALL RESTORE THE DAMAGE TO EXISTING SYSTEMS OR UTILITIES AND REMOVE EXISTING OBSTRUCTIONS AND FOUNDATIONS TO THE SATISFACTION OF THE ENGINEER.


7. ALL THE FOUNDATIONS SHALL INCLUDE A GROUND ROD PER STANDARD DETAIL BE-300 AND STANDARD SPECIFICATION SECTION 806..

8. POLE SETBACKS SHALL NOT BE LESS THAN 3 FEET FROM FACE OF CURB (FOC) TO CENTER OF POLE.

1 STANDARD DETAILS, Y STANDARDS,			U.		SEC	TION			COUNTY	ŕ	TOTAL SHEETS	SHEET NO.
			2759 22-00094-00-LT						COOK		21	2
6, LIGHTING	NOTES	_							CONTR	ACT	T NO. 61	K53
STA.	TO STA.	FED.	ROAD	DIST.	N0.	ILLINOIS	FED.	AID	PROJECT	1	WL3A(61	9)

	,		F		80% Fed 20% Local	
	Specialty ltem	Code Number	Description	Unit	Total Quantity	Constru Cod Roadwa
	*	20101300	TREE PRUNING (1 TO 10 INCH DIA METER)	EACH	5	
	*	20101350	TREE PRUNING (OV ER 10 INCH DIA METER)	EACH	5	
		21101615	TOPSOIL FURNISH AND PLACE, 4"	SQYD	285	
		25000400	NITROGEN FERTILIZER NUTRIENT	POUND	4	
		25000500	PHOSPHORUS FERTILIZER NUTRIENT	POUND	4	
		25000600	POTA SSIUM FERTILIZER NUTRIENT	POUND	4	
		25200110	SODDING, SALT TOLERANT	SQYD	285	
		25200200	SUPPLEMENTAL WATERING	UNIT	25	
	* .	42400200	PORTLAND CEMENT CONCRETE SIDEWALK, 5"	SQ FT	1,000	
	*	42400800	DETECTA BLE WA RNINGS	SQ FT	20	-
	*	44000600	SIDEWALKREMOVAL	SQ FT	1,350	
		67100100	MOBILIZATION	L.SUM	1	
		70102625	TRAFFIC CONTROL AND PROTECTION, STANDARD 701606	L.SUM	1	
		70102630	TRAFFIC CONTROL AND PROTECTION, STANDARD 701601	L.SUM	1	- -
		70102635	TRAFFIC CONTROL AND PROTECTION, STANDARD 701701	L.SUM	1	
		70102640	TRAFFIC CONTROL AND PROTECTION, STANDARD 701801	L.SUM	1	
FILE NAME FAU 2759 (DES PLAINES AVENUE) FAU 1459 (26TH STREET) TO FAU 1453 (CERMAK ROAD) LED STREET LIGHTING #20072	D PLDY SCALE - C	esigned – JEF ravin – JFP hecked – THK ate – 2–22-	REVISED - 5-22-24 REVISED - 6-11-24 STATE OF ILLINOIS REVISED - 7-9-24 DEPARTMENT OF TRANSPORTATION -24 REVISED - 10-25-24	SCALE:		


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20% Local

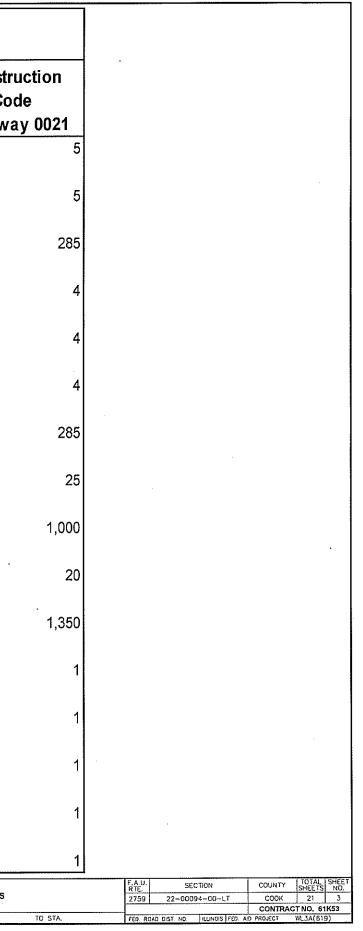	1		1	20% Local	
Specialty Item	Code Number	Description	Unit	Total Quantity	
	81028200	UNDERGROUND CONDUIT, GALVANIZED STEEL, 2" DIA.	FOOT	65	
	81702400	ELECTRICAL CABLE IN CONDUIT, 600V (XLP-TYPE USE), 3-1/C NO. 2	FOOT	65	
	82500360	LIGHTING CONTROLLER, BASE MOUNTED, 480 VOLT, 100AMP	EACH	1	
	83600200	LIGHT POLE FOUNDATION, 24" DIA METER	FOOT	310	
	83600352	LIGHT POLE FOUNDATION, METAL, 11 1/2" Bolt Circle, 8' 5/8" x 6'	EACH	7	
	84200500	REMOVAL OF LIGHTING UNIT, SALVAGE	EACH	36	
	84200804	REMOVAL OF POLE FOUNDATION	EACH	36	
	84500110	REMOVAL OF LIGHTING CONTROLLER	EACH	1	
	84500120	REMOVAL OF ELECTRICAL SERVICE INSTALLATION	EACH	1	
	84500130	REMOVAL OF LIGHTING CONTROLLER FOUNDATION	EACH	1	
	89502300	REMOVE ELECTRIC CABLE FROM CONDUIT	FOOT	270	
	X1400282	POLYETHYLENE DUCT, 1-1/4" DIA.	FOOT	50	
	XX009688	ELECTRICAL CABLE IN CONDUIT, 600V (XLP-TYPE USE), 3-1/C NO. 10, 3-1/C NO. 6, 1/C NO. 8 GROUND	FOOT	270	
	XX009691	UNIT DUCT, 600V, 3-1/C NO. 8, 3-1/C NO. 1, 1/C NO. 6 GROUND, (XLP-TYPE USE), 1 1/2" DIA. POLYETHYLENE, DIRECTIONALLY BORED	FOOT	1,630	
USER NAVE =	DESIGNED	JEF REVISED - 5-22-24			
AAK ROAD)	DRAWN CHECKED DATE	THK REVISED - 7-9-24 DEPARTMENT OF TRANSPORTATION	SCALE: NONE SHEET	SUMMARY OF QUANTITIES	

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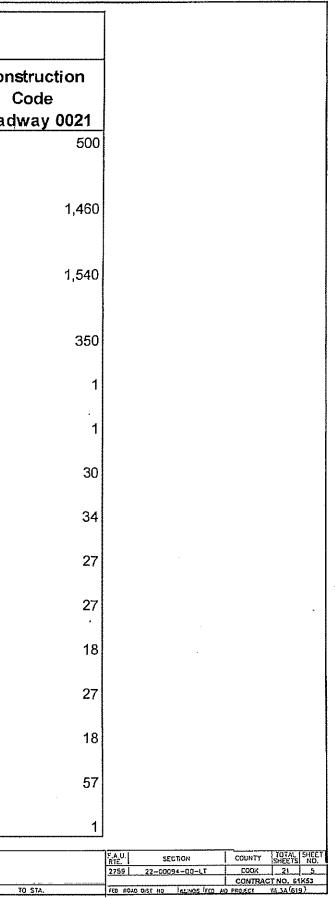
			1	80% Fed 20% Local	
Specialty Item	Code Number	Description	Unit	Total Quantity	Con (Road
Piere de la Mille de la desance de la constance	XX009692	UNIT DUCT, 600V, 3-1/C NO. 10, 3-1/C NO. 4, 1/C NO. 8 GROUND, (XLP-TYPE USE), 1 1/2" DIA. POLYETHYLENE, DIRECTIONALLY BORED	FOOT	500	·••···································
		UNIT DUCT, 600V, 3-1/C NO. 10, 3-1/C NO. 6, 1/C NO. 8 GROUND, (XLP-TYPE USE), 1 1/2" DIA. POLYETHYLENE, DIRECTIONALLY BORED	FOOT	1,460	
	XX009694	UNIT DUCT, 600V, 3-1/C NO. 10, 3-1/C NO. 2, 1/C NO. 8 GROUND, (XLP-TY PE USE), 1 1/2" DIA. POLY ETHYLENE, DIRECTIONALLY BORED	FOOT	1,540	
*	X1700067	STAMPED COLORED PORTLAND CEMENT CONCRETE SIDEWALK, 5"	SQ FT	350	
	X8050135	SERVICE INSTALLATION, TYPE C (MODIFIED)	EACH	1	
	X8130125	REMOVE EXISTING JUNCTION BOX	EACH	1	
	X8360215	LIGHT POLE FOUNDATION, 24" DIA METER, OFFSET	EACH	30	
	X8380084	BREAKAWAY DEVICE, COUPLING	EACH	34	
	XX008068	LUMINAIRE INSTALLATION, TYPE 1	EACH	27	
	XX008069	LUMINAIRE INSTALLATION, TYPE 2	EACH	27	
	XX009148	LUMINAIRE INSTALLATION, TYPE 3	EACH	18	
	XX009377	DECORATIVE LIGHT POLE, TYPE A	EACH	27	
	XX009378	DECORATIVE LIGHT POLE, TY PE B	EACH	18	
	Z0030850	TEMPORARY INFORMATIONSIGN NG	SQ FT	57	
	Z0048665	RAILROAD PROTECTIVE LIABILITY INSURANCE	L.SUM	1	


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ALE NAUS	USER NAVE #	DESIGNED - JEF	REVISED - 6-11-24		
FAU 2759 (DES PLAINES AVENUE)		DRAWN - JFP	REVISED - 7-9-24	STATE OF ILLINOIS	SUMMARY OF QUANTITIES
FAU 1459 (26TH STREET) TO FAU 1453 (CERMAK ROAD) LED STREET LIGHTING	PLOT SCALE -	снескев – ТНК	REVISED - 7-17-24	DEPARTMENT OF TRANSPORTATION	
#20072		DATE - 2-22-24	REVISED - 10-25-24	Der Annie en Thanse en Tallen	SCALE, NONE SHEET NO. OF SHEETS STA. TO
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EXISTING LEGEND

(2) EXISTING COMBINATION CONCRETE CURB AND GUTTER. TYPE B-6.12 to REMAIN (3) PORTLAND CEMENT SIDEWALK, STAMPED PORTLAND CEMENT CONCRETE SIDEWALK. (ACCEPT AT EXCAVATIONS FOR UNDERGROUND ELECTRICAL WORK)

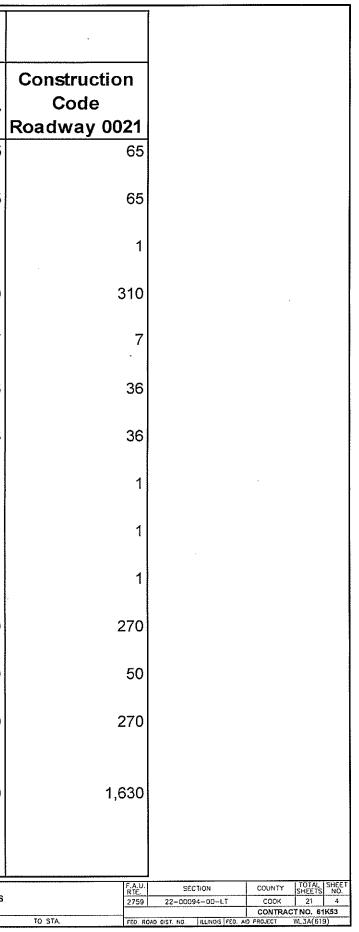PROPOSED LEGEND


(A) PROPOSED DECORATIVE LED LIGHTING STANDARD, TYPE B WITH PLANTER BASKET AND FESTOON OUTLETS MOUNTED ON NEW CONCRETE FOUNDATION

(B) PROPOSED DECORATIVE LED LIGHTING STANDARD, TYPE A WITH BANNER ARMS AND FESTOON OUTLETS, MOUNTED ON NEW CONCRETE FOUNDATION

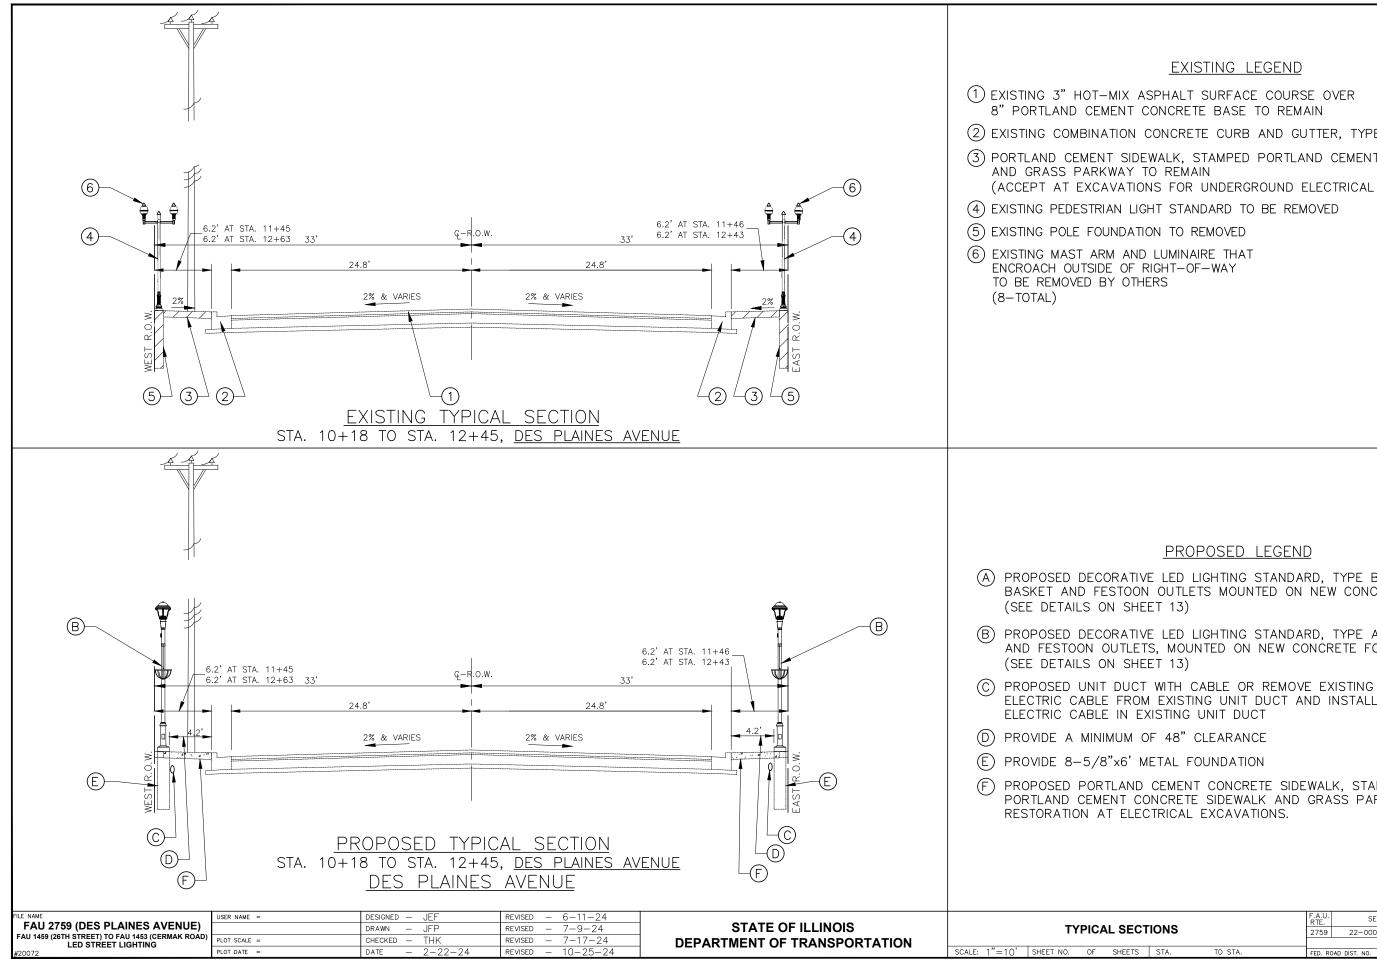ELECTRIC CABLE FROM EXISTING UNIT DUCT AND INSTALL NEW

(F) PROPOSED PORTLAND CEMENT CONCRETE SIDEWALK, STAMPED PORTLAND CEMENT CONCRETE SIDEWALK AND GRASS PARKWAY

			I. SEC	TION		COUNTY	/ TOTAL SHEETS	SHEET NO.
ONS		2759	22-0009	4-00-L1	СООК	21	6	
						CONTR	ACT NO. 61	K53
STA.	TO STA.	FED.	ROAD DIST. NO.	ILLINOIS	FED. A	ID PROJECT	WL3A(61	9)

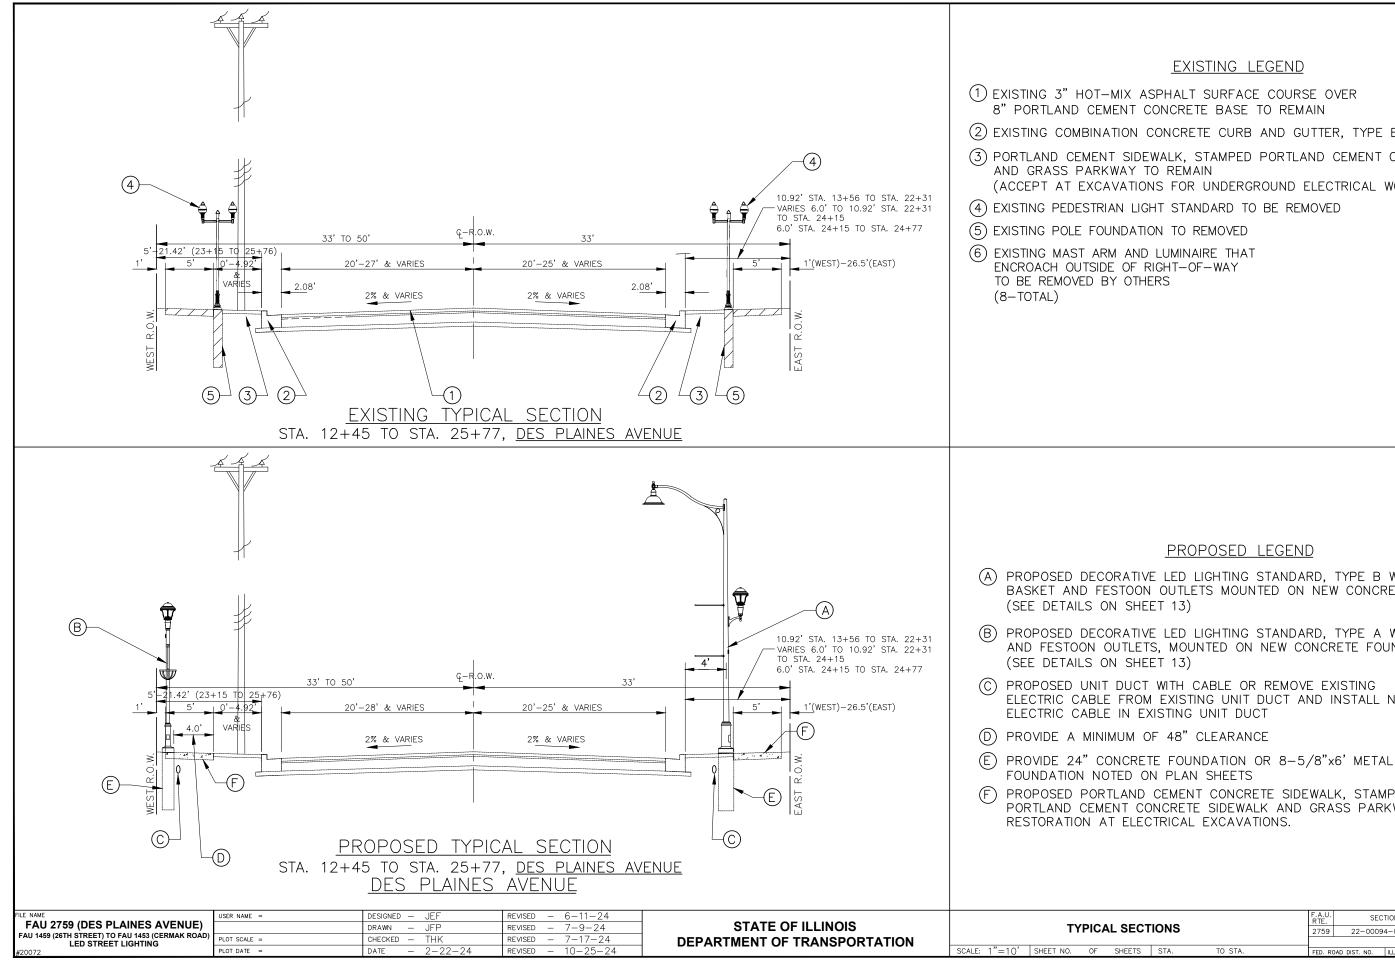

EXISTING LEGEND

(2) EXISTING COMBINATION CONCRETE CURB AND GUTTER. TYPE B-6.12 to REMAIN (3) PORTLAND CEMENT SIDEWALK, STAMPED PORTLAND CEMENT CONCRETE SIDEWALK. (ACCEPT AT EXCAVATIONS FOR UNDERGROUND ELECTRICAL WORK)

PROPOSED LEGEND

(A) PROPOSED DECORATIVE LED LIGHTING STANDARD, TYPE B WITH PLANTER BASKET AND FESTOON OUTLETS MOUNTED ON NEW CONCRETE FOUNDATION


(B) PROPOSED DECORATIVE LED LIGHTING STANDARD, TYPE A WITH BANNER ARMS AND FESTOON OUTLETS, MOUNTED ON NEW CONCRETE FOUNDATION

PROPOSED UNIT DUCT WITH CABLE OR REMOVE EXISTING ELECTRIC CABLE FROM EXISTING UNIT DUCT AND INSTALL NEW

PROPOSED PORTLAND CEMENT CONCRETE SIDEWALK, STAMPED

PORTLAND CEMENT CONCRETE SIDEWALK AND GRASS PARKWAY

ONS		F.A. RTE		SEC	TION		COUNTY	TOTAL SHEETS	SHEET NO.
		275	9	22-0009	4-00-L	COOK	21	7	
							CONTRA	CT NO. 61	K53
STA.	TO STA.	FED.	ROAD	DIST. NO.	ILLINOIS	FED. AI	D PROJECT	WL3A(61	9)

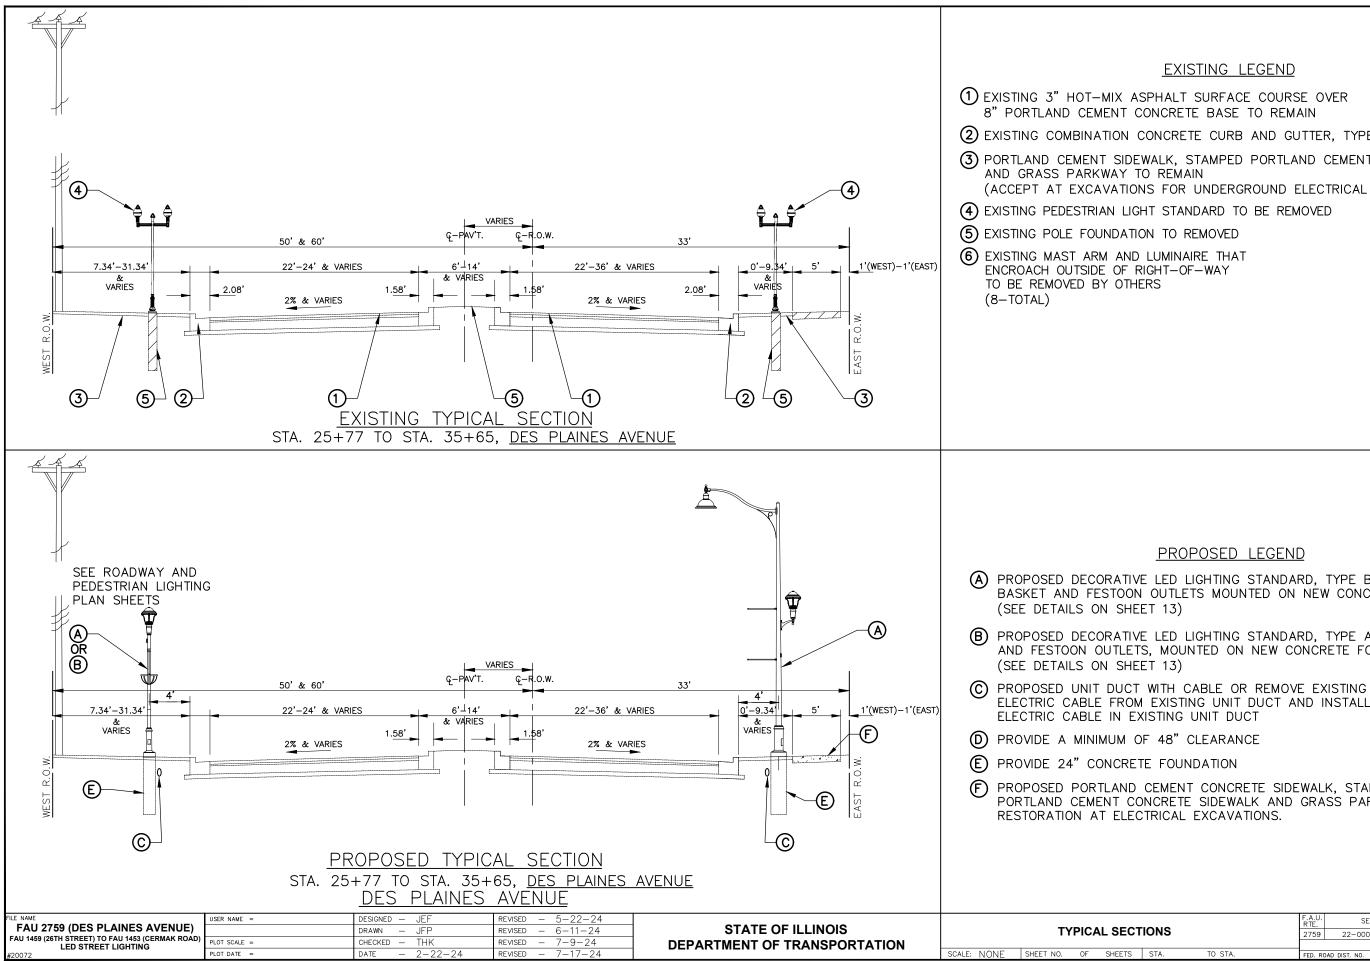

EXISTING LEGEND

(2) EXISTING COMBINATION CONCRETE CURB AND GUTTER. TYPE B-6.12 to REMAIN (3) PORTLAND CEMENT SIDEWALK, STAMPED PORTLAND CEMENT CONCRETE SIDEWALK, (ACCEPT AT EXCAVATIONS FOR UNDERGROUND ELECTRICAL WORK)

PROPOSED LEGEND


(A) PROPOSED DECORATIVE LED LIGHTING STANDARD, TYPE B WITH PLANTER BASKET AND FESTOON OUTLETS MOUNTED ON NEW CONCRETE FOUNDATION


(B) PROPOSED DECORATIVE LED LIGHTING STANDARD, TYPE A WITH BANNER ARMS AND FESTOON OUTLETS, MOUNTED ON NEW CONCRETE FOUNDATION


ELECTRIC CABLE FROM EXISTING UNIT DUCT AND INSTALL NEW

(F) PROPOSED PORTLAND CEMENT CONCRETE SIDEWALK, STAMPED PORTLAND CEMENT CONCRETE SIDEWALK AND GRASS PARKWAY

ONS			F.A.U. SECTION RTE.						COUNT	Υ	TOTAL SHEETS	SHEET NO.
			2759 22-00094-00-LT						COOF	<	21	8
									CONT	RACT	T NO. 61	K53
STA.	TO STA.	FED.	ROAD	DIST. NO.	. IL	LINOIS	FED.	AID	PROJECT	١	NL3A(61))

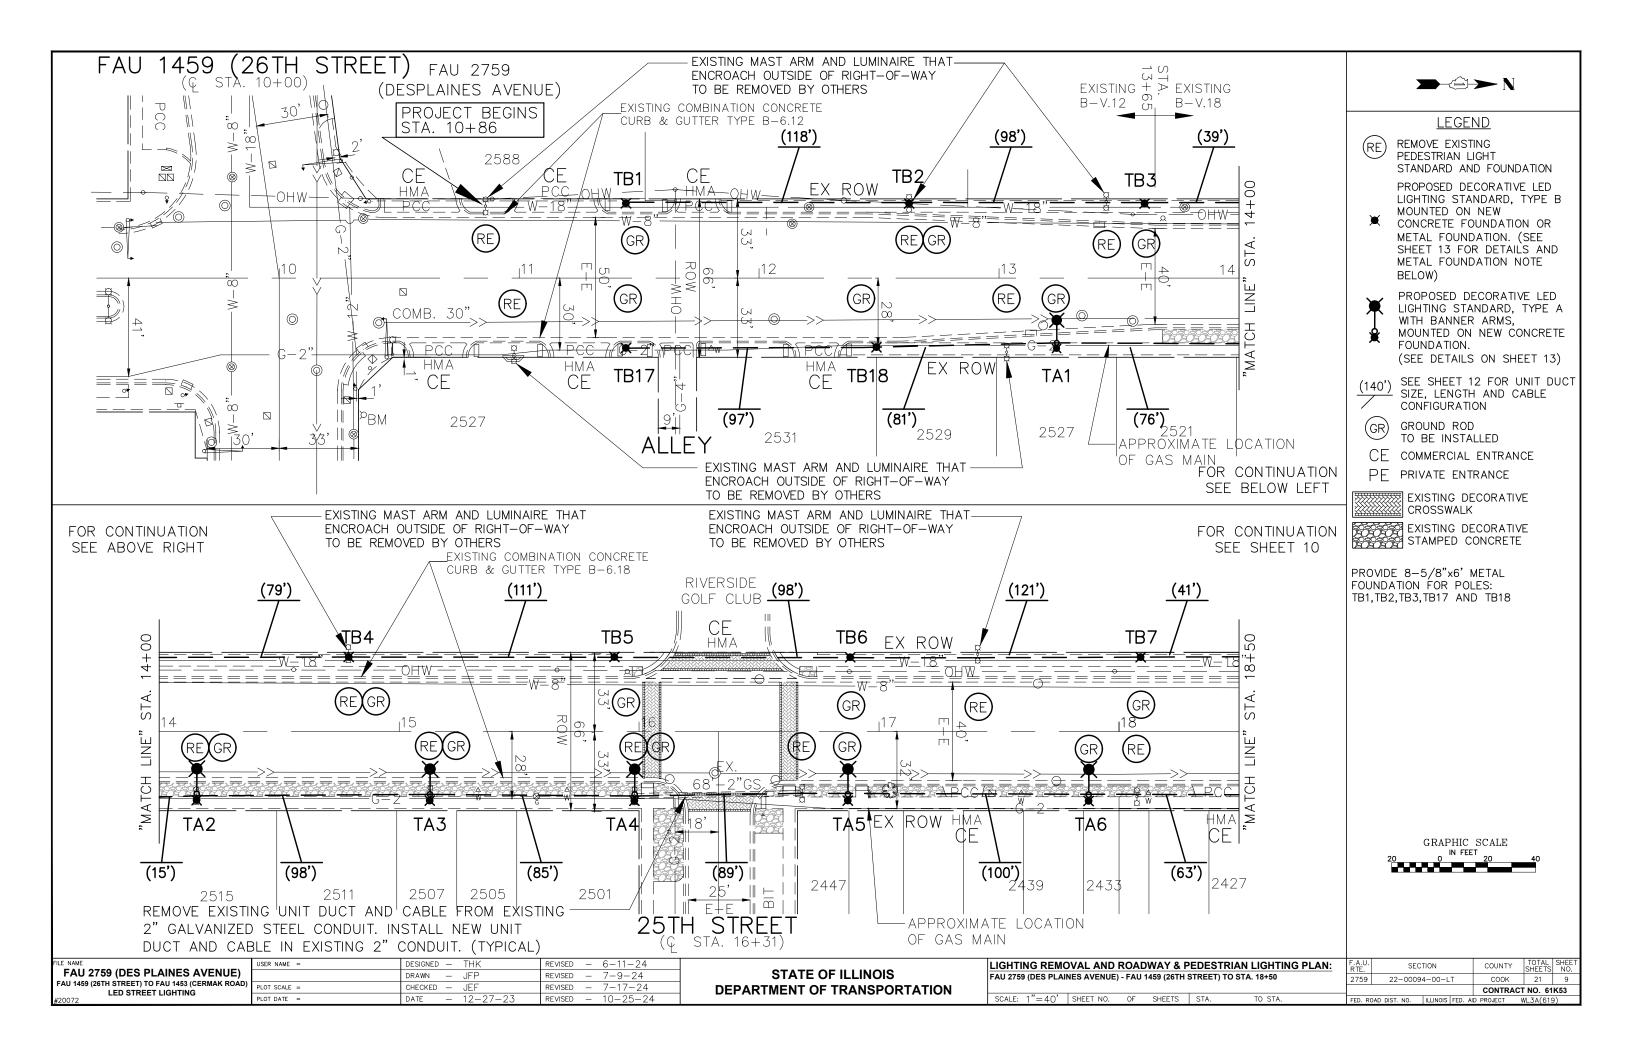

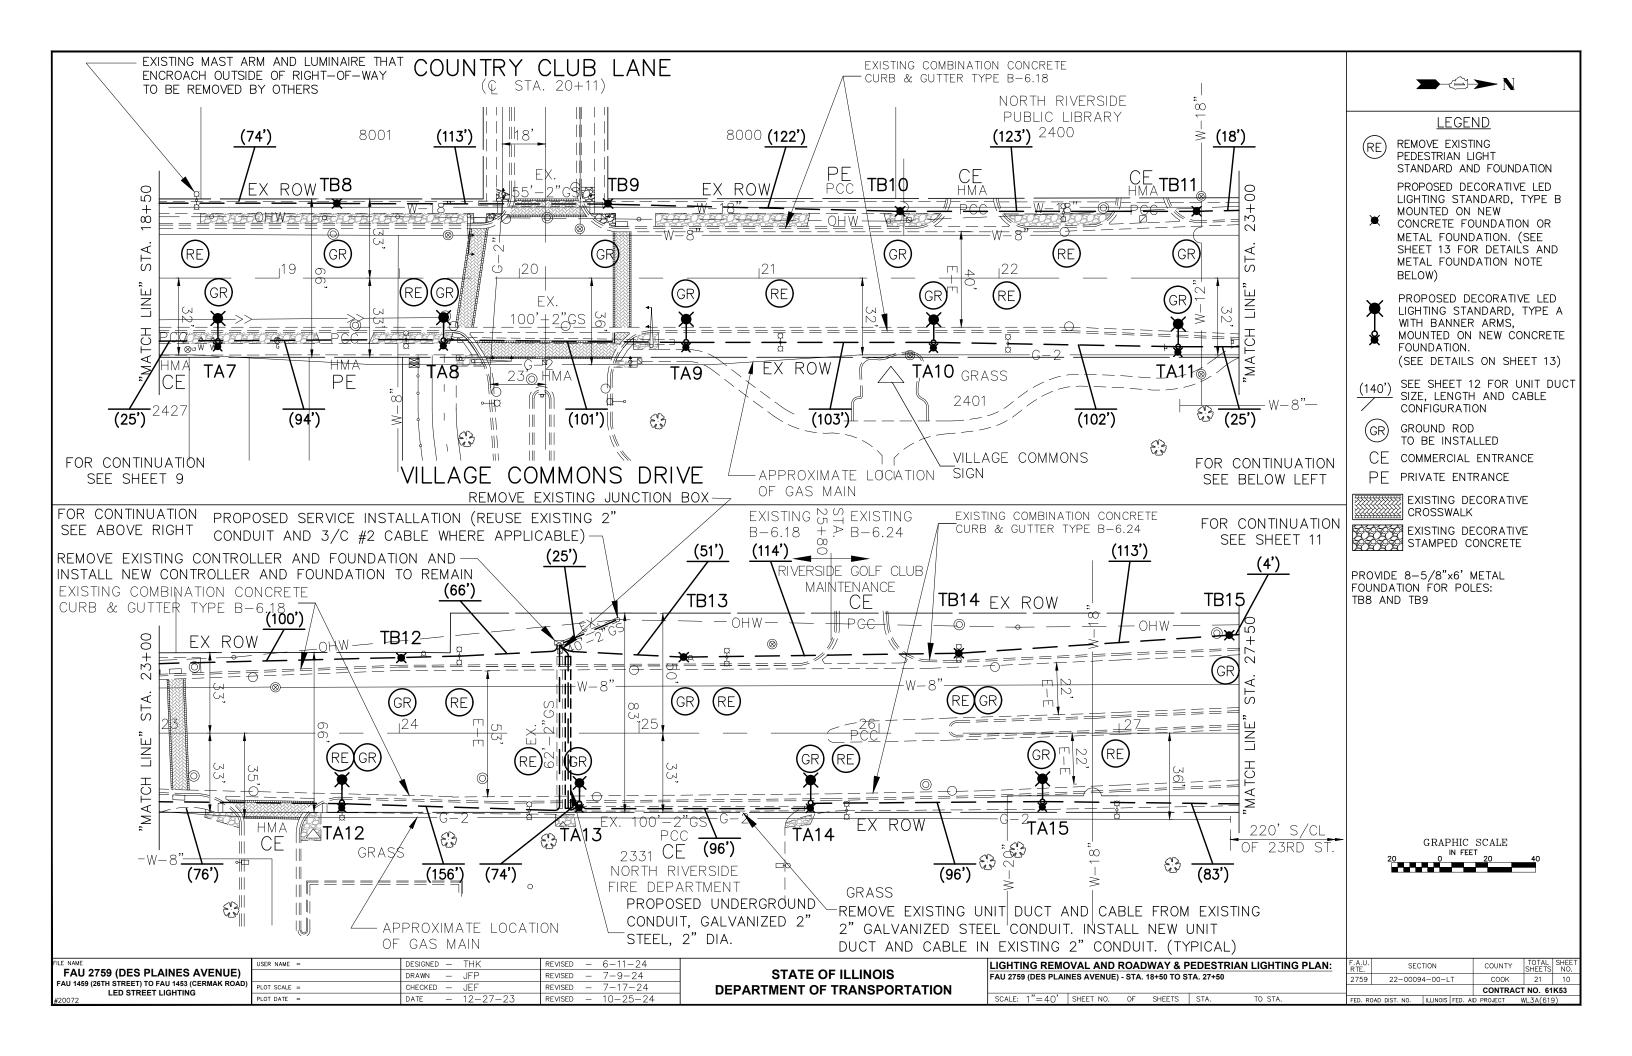

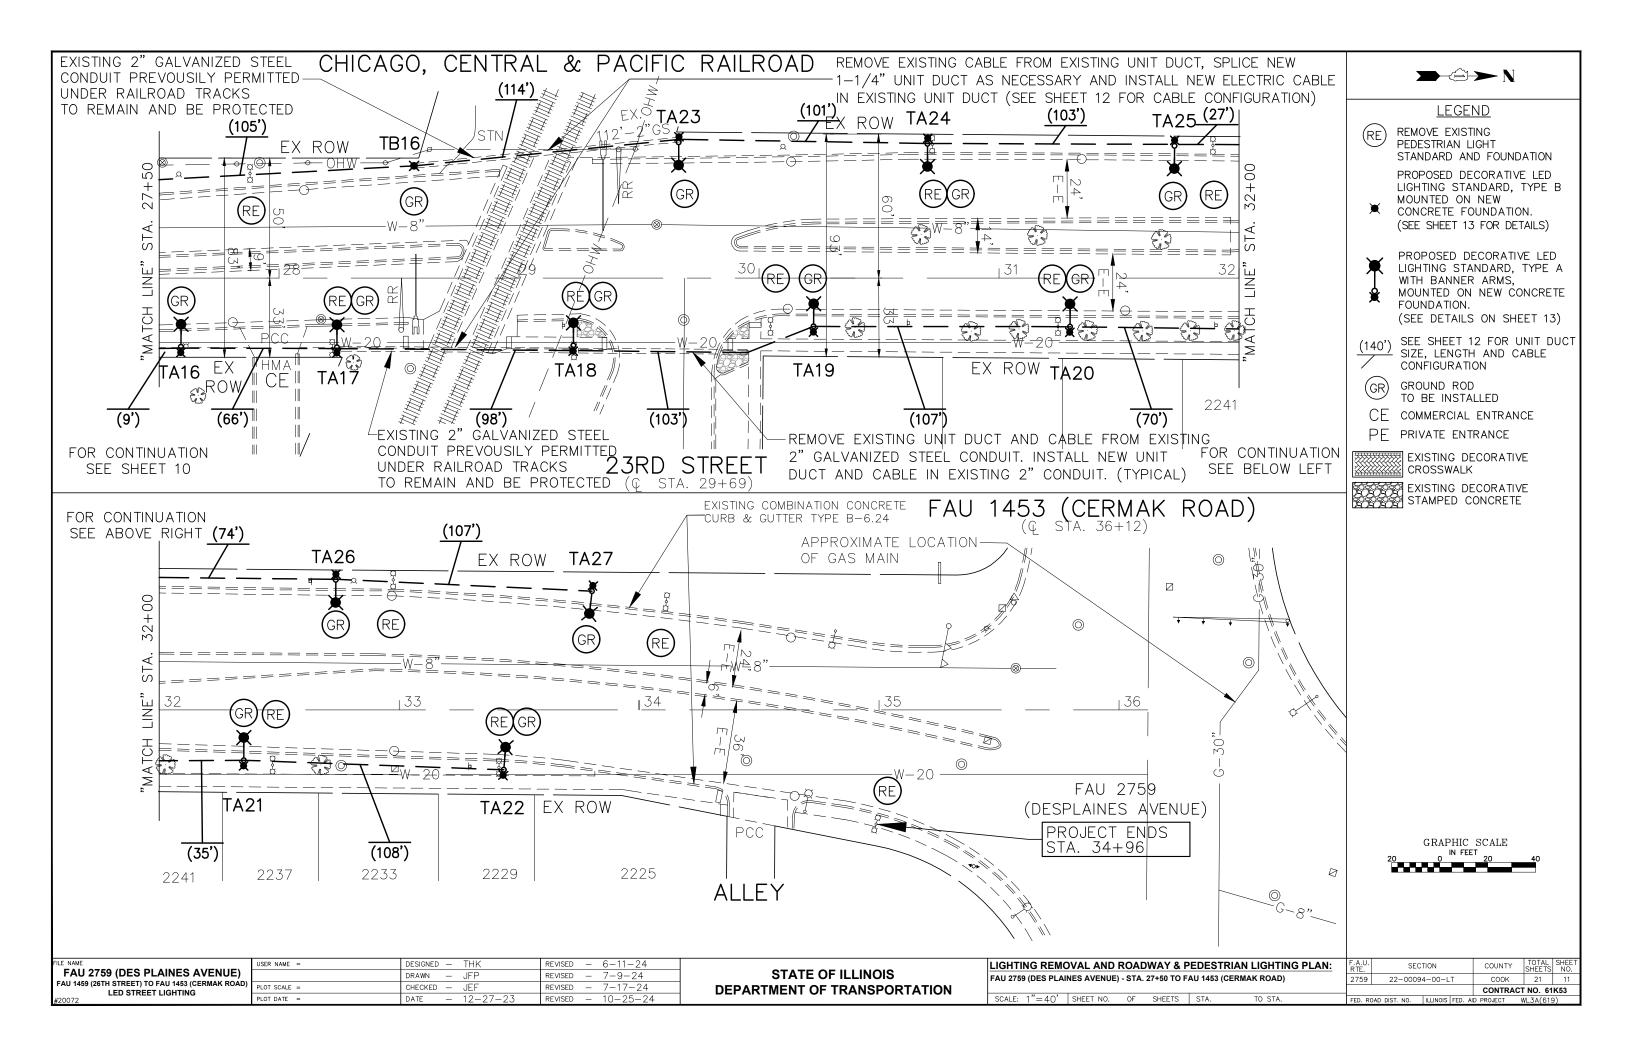


				WEST PROPOSED UNIT DUCT &	SIDE CONDUCTOR				
		LENGTH					LENGTH		
FROM TB1	TO TB2	(FT) 118.0000	SIZE (IN)	CABLES & CONDUCTORS LIGHTING 3/C #10, RECEPTACLES 3/C #2, GROUND 1/C #8	FROM TB12		(FT)	SIZE (IN)	CABLES & CONDUCTORS LIGHTING 3/C #10, RECEPTACLES 3/C #2, GROUND 1/C #8
TB2	TB3	98.0000		LIGHTING 3/C #10, RECEPTACLES 3/C #2, GROUND 1/C #8	CONTROL	CONTROLLER TB13	66.0000 51.0000	1-1/2	LIGHTING 3/C #10, RECEPTACLES 3/C #4, GROUND 1/C #8
TB3	TB4	118.0000		LIGHTING 3/C #10, RECEPTACLES 3/C #2, GROUND 1/C #8	TB13	TB14	114.0000	1-1/2	LIGHTING 3/C #10, RECEPTACLES 3/C #6, GROUND 1/C #8
TB4	TB5	111.0000	1-1/2	LIGHTING 3/C #10, RECEPTACLES 3/C #2, GROUND 1/C #8	TB14	TB15	113.0000	1-1/2	LIGHTING 3/C #10, RECEPTACLES 3/C #6, GROUND 1/C #8
TB5	TB6	98.0000	1-1/2	LIGHTING 3/C #10, RECEPTACLES 3/C #2, GROUND 1/C #8	TB15	TB16	109.000 0	1-1/2	LIGHTING 3/C #10, RECEPTACLES 3/C #6, GROUND 1/C #8
TB6	TB7	121.0000	1-1/2	LIGHTING 3/C #10, RECEPTACLES 3/C #2, GROUND 1/C #8	TB16	TA25	114.0000	USE EXISTING 1-1/4	LIGHTING 3/C #10, RECEPTACLES 3/C #6, GROUND 1/C #8
TB7	TB8	115.0000	1-1/2	LIGHTING 3/C #10, RECEPTACLES 3/C #2, GROUND 1/C #8	TA23	TA24	101.0000	1-1/2	LIGHTING 3/C #10, RECEPTACLES 3/C #6, GROUND 1/C #8
TB8	TB9	113.0000	1-1/2	LIGHTING 3/C #10, RECEPTACLES 3/C #2, GROUND 1/C #8	TA24	TA25	103.000 0	1-1/2	LIGHTING 3/C #10, RECEPTACLES 3/C #6, GROUND 1/C #8
TB9	TB10	122.000 0	1-1/2	LIGHTING 3/C #10, RECEPTACLES 3/C #2, GROUND 1/C #8	TA25	TA26	101.0000	1-1/2	LIGHTING 3/C #10, RECEPTACLES 3/C #6, GROUND 1/C #8
TB10	TB11	123.000 0	1-1/2	LIGHTING 3/C #10, RECEPTACLES 3/C #2, GROUND 1/C #8	TA26	TA27	107.000 0	1-1/2	LIGHTING 3/C #10, RECEPTACLES 3/C #6, GROUND 1/C #8
TB11	TB12	118.0000	1-1/2	LIGHTING 3/C #10, RECEPTACLES 3/C #2, GROUND 1/C #8					

	WEST SIDE LIG	HT POLES	
POLE NO.	STATION	OFFSET	LIGHTING CLE CIRCUIT CIRCUIT
TB 1	11+45	31.0'	SW-B(L) SW-B(R)
TB 2	12+63	31.0'	SW-R(L) SW-R(R)
TB 3	13+61	31.0'	SW-B(L) SW-B(R)
TB 4	14+79	31.0'	SW-R(L) SW-R(R)
TB 5	15+90	31.0'	SW-B(L) SW-B(R)
TB 6	16+88	31.0'	SW-R(L) SW-R(R)
TB 7	18+09	31.0'	SW-B(L) SW-B(R)
TB 8	19+24	31.0'	SW-R(L) SW-R(R)
TB 9	20+37	31.0'	SW-B(L) SW-B(R)
TB 10	21+59	28.0'	SW-R(L) SW-R(R)
TB 11	22+82	28.0'	SW-B(L) SW-B(R)
TB 12	24+00	31.0'	SW-R(L) SW-R(R)
TB 13	25+19	32.0'	NW-B(L) NW-B(R)
TB 14	26+33	33.0'	NW-R(L) NW-R(R)
TB 15	27+46	40.0'	NW-B(L) NW-B(R)
TB 16	28+55	46.0'	NW-R(L) NW-R(R)
TA 23	29+69	56.0'	NW-B(L) NW-B(R)
TA 24	30+70	56.0'	NW-R(L) NW-R(R)
TA 25	31+73	55.0'	NW-B(L) NW-B(R)
TA 26	32+74	54.0'	NW-R(L) NW-R(R)
TA 27	33+81	50.0'	NW-B(L) NW-B(R)


						FAST	r side				
					PROPOSED L		CONDUCTOR	INFORMATION			
۲)	FROM	ТО	LENGTH (FT)	UNIT DUCT SIZE (IN)	CABLES & CONDUCT	TORS	FROM	ТО	LENGTH (FT)	UNIT DUCT SIZE (IN)	CABLES & CONDUCTORS
	TB17	TB18	97.0000	1-1/2	LIGHTING 3/C #8, RECEPT/ #1, GROUND 1/C	ACLES 3/C	TA11	TA12	101.0000		LIGHTING 3/C #8, RECEPTACLES 3/C #1, GROUND 1/C #6
	TB18	TA1	81.0000	1-1/2	LIGHTING 3/C #8, RECEPT #1, GROUND 1/C	/	TA12	CONTROLLER	156.000 0	1-1/2	LIGHTING 3/C #8, RECEPTACLES 3/C #1, GROUND 1/C #6
	TA1	TA2	91.0000	1-1/2	LIGHTING 3/C #8, RECEPT/ #1, GROUND 1/C	'	CONTROL LER	TA13	74.0000	1-1/2	LIGHTING 3/C #10, RECEPTACLES 3/C #4, GROUND 1/C #8
	TA2	TA3	98.0000	1-1/2	LIGHTING 3/C #8, RECEPT/ #1, GROUND 1/C		TA13	TA14	96.0000	1-1/2	LIGHTING 3/C #10, RECEPTACLES 3/C #4, GROUND 1/C #8
	TA3	TA4	85.0000	1-1/2	LIGHTING 3/C #8, RECEPT/ #1, GROUND 1/C		TA14	TA15	96.0000	1-1/2	LIGHTING 3/C #10, RECEPTACLES 3/C #4, GROUND 1/C #8
	TA4	TA5	89.0000	1-1/2	LIGHTING 3/C #8, RECEPT/ #1, GROUND 1/C		TA15	TA16	92.0000	1-1/2	LIGHTING 3/C #10, RECEPTACLES 3/C #4, GROUND 1/C #8
	TA5	TA6	100.000	1-1/2	LIGHTING 3/C #8, RECEPT/ #1, GROUND 1/C		TA16	TA17	66.0000		LIGHTING 3/C #10, RECEPTACLES 3/C #6, GROUND 1/C #8
	TA6	TA7	88.0000	1-1/2	LIGHTING 3/C #8, RECEPT/ #1, GROUND 1/C		TA17	TA18	98.0000		LIGHTING 3/C #10, RECEPTACLES 3/C #6, GROUND 1/C #8
	TA7	TA8	94.0000	1-1/2	LIGHTING 3/C #8, RECEPT/ #1, GROUND 1/C		TA18	TA19	103.000 0	1-1/2	LIGHTING 3/C #10, RECEPTACLES 3/C #6, GROUND 1/C #8
	TA8	TA9	101.0000	1-1/2	LIGHTING 3/C #8, RECEPT/ #1, GROUND 1/C	· · · ·	TA19	TA20	107.000 0	1-1/2	LIGHTING 3/C #10, RECEPTACLES 3/C #6, GROUND 1/C #8
	TA9	TA10	103.000 0	1-1/2	LIGHTING 3/C #8, RECEPT #1, GROUND 1/C	/	TA20	TA21	105.000 0	1-1/2	LIGHTING 3/C #10, RECEPTACLES 3/C #6, GROUND 1/C #8
	TA10	TA11	102.000 0	1-1/2	LIGHTING 3/C #8, RECEPT/ #1, GROUND 1/C		TA21	TA22	108.000 0	1-1/2	LIGHTING 3/C #10, RECEPTACLES 3/C #6, GROUND 1/C #8
REVISED REVISED REVISED				ATE OF I			FAU 275	AND CCONDUCTOR INFO		RTS -	F.A.U. RTE. SECTION COUNTY TOTA SHEE 2759 22-00094-00-LT COOK 21 CONTRACT NO. CONTRACT NO. CONTRACT NO.
REVISED	-		,			scale: NTS	SHEET NO.	OF SHEETS STA.	TO STA.		FED. ROAD DIST. NO. ILLINOIS FED. AID PROJECT WL3A(6


	EAST SIDE LI	GHT POLES		
POLE NO.	STATION	OFFSET	LIGHTING CIRCUIT	RECEPTAC E CIRCUI
TB17	11+46	29.0'	SE-B(L)	SE-B(R)
TB18	12+43	29.0'	SE-R(L)	SE-R(R)
TA1	13+24	28.0'	SE-B(L)	SE-B(R)
TA2	14+15	26.0'	SE-R(L)	SE-R(R)
TA3	15+13	26.0'	SE-B(L)	SE-B(R)
TA4	15+98	26.0'	SE-R(L)	SE-R(R)
TA5	16+87	26.0'	SE-B(L)	SE-B(R)
TA6	17+87	26.0'	SE-R(L)	SE-R(R)
TA7	18+75	26.0'	SE-B(L)	SE-B(R)
TA8	19+69	26.0'	SE-R(L)	SE-R(R)
TA9	20+70	26.0'	SE-B(L)	SE-B(R)
TA10	21+73	26.0'	SE-R(L)	SE-R(R)
TA11	21+75	29.0'	SE-B(L)	SE-B(R)
TA12	23+76	29.0'	SE-R(L)	SE-R(R)
TA13	24+75	30.0'	NE-B(L)	NE-B(R)
TA14	25+71	30.0'	NE-R(L)	NE-R(R)
TA15	26+67	29.0'	NE-B(L)	NE-B(R)
TA16	27+59	28.0'	NE-R(L)	NE-R(R)
TA17	28+25	28.0'	NE-B(L)	NE-B(R)
TA18	29+23	28.0'	NE-R(L)	NE-R(R)
TA19	30+23	20.0'	NE-B(L)	NE-B(R)
TA20	31+30	20.0'	NE-R(L)	NE-R(R)
TA21	32+35	21.0'	NE-B(L)	NE-B(R)
TA22	33+43	24.0'	NE-R(L)	NE-R(R)

FILE NAME	USER NAME =	DESIGNED - JEF	REVISED - 7-17-24						
FAU 2759 (DES PLAINES AVENUE)		drawn — JFP	REVISED -	STATE OF ILLINOIS	LIGHT POLE	E, UNIT DUCT			
FAU 1459 (26TH STREET) TO FAU 1453 (CERMAK ROAD) LED STREET LIGHTING	PLOT SCALE =	CHECKED – THK	REVISED -	DEPARTMENT OF TRANSPORTATION		FAU 27	(59 (DE	ES PLAINE	ES AV
#20072	PLOT DATE =	DATE - 6-11-24	REVISED -		SCALE: NTS	SHEET NO.	OF	SHEETS	STA.

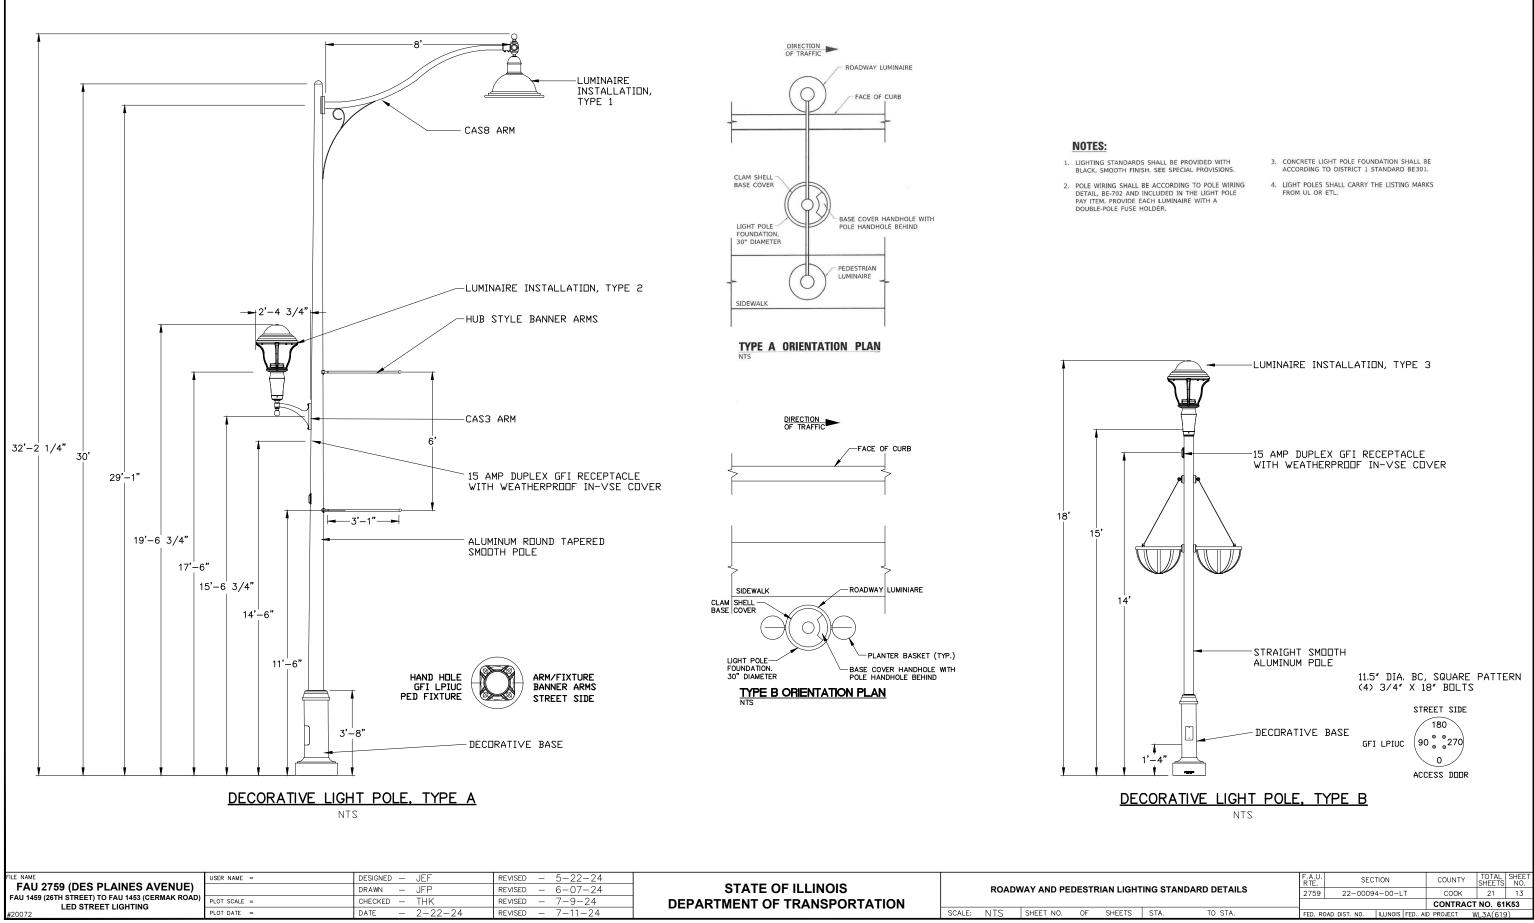


		F.A.U. RTE.	SEC.	TION		COUNTY	/	TOTAL SHEETS	SHEET NO.
G STAN	IDARD DETAILS	2759	22-0009	4-00-L	Т	СООК		21	13
						CONTRA	٩СТ	NO. 61	K53
STA.	TO STA.	FED. RC	DAD DIST. NO.	ILLINOIS	FED. AI	D PROJECT	N	L3A(619))

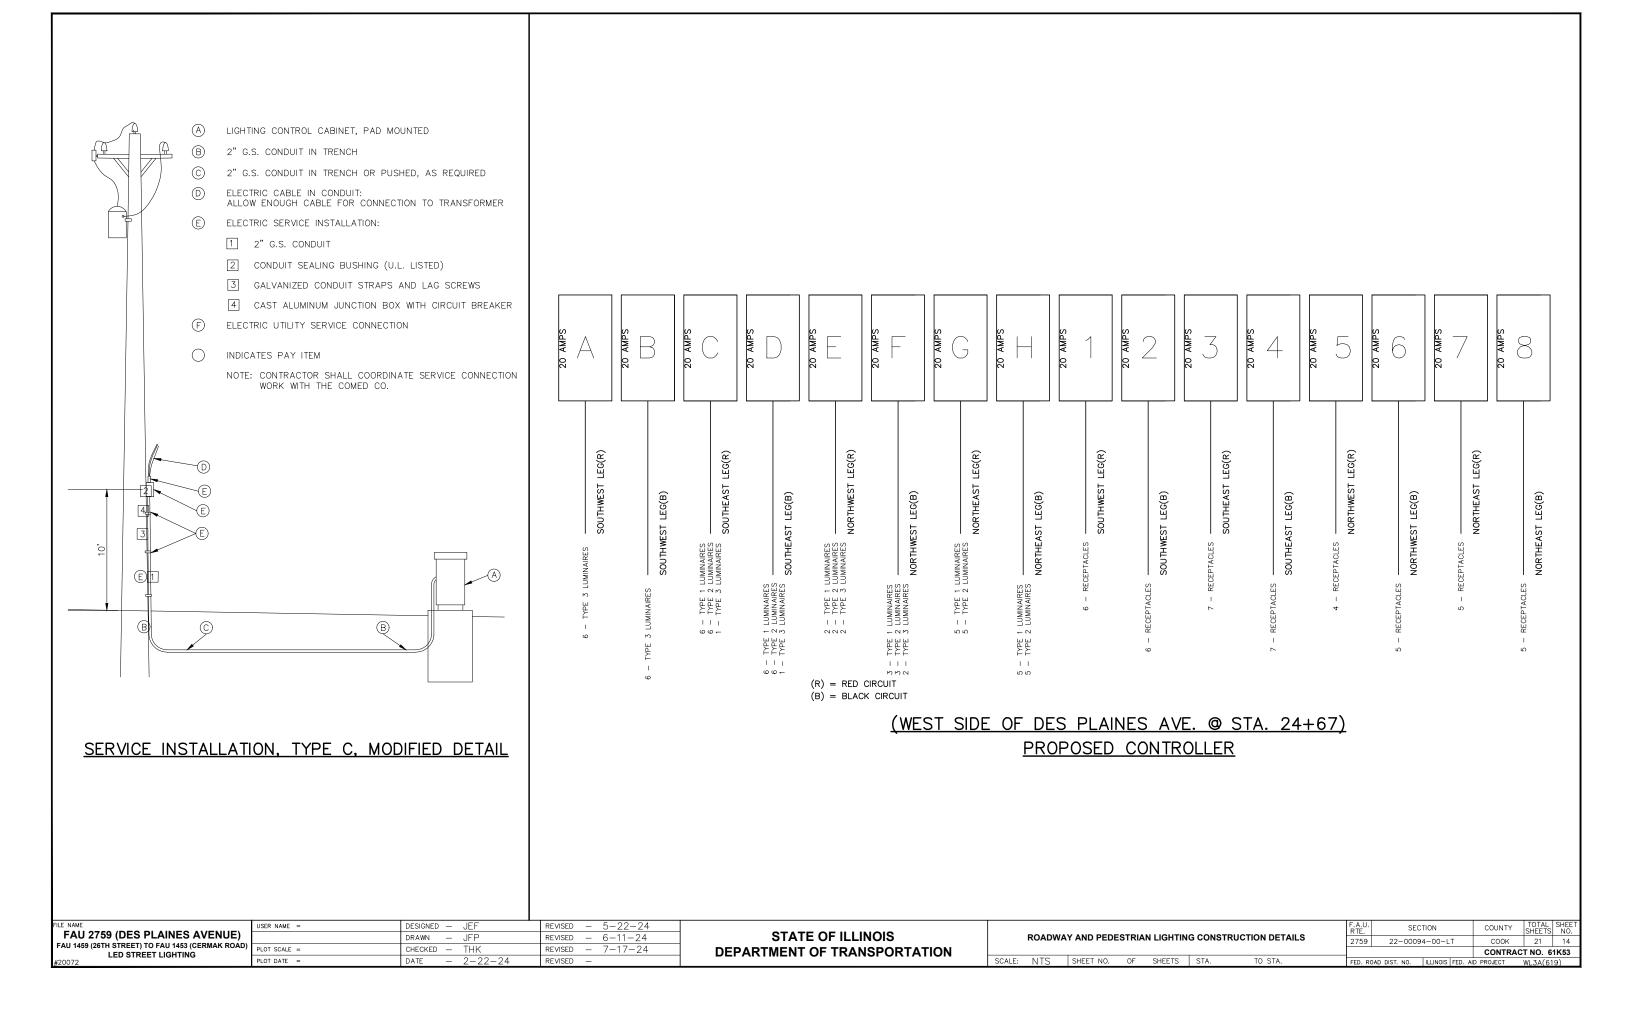

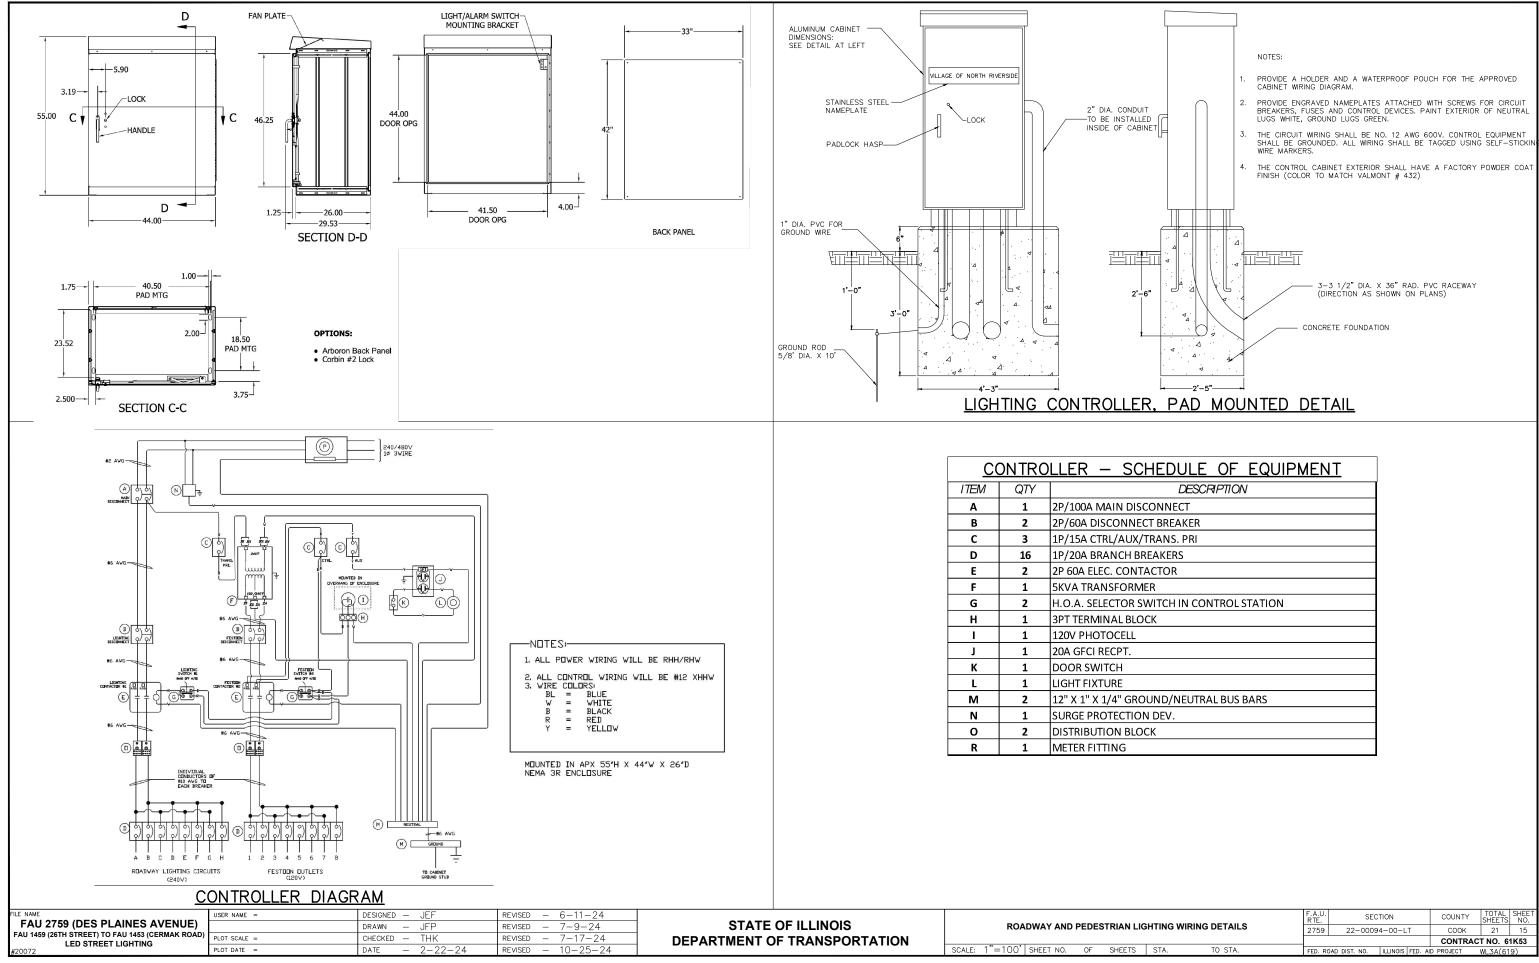


EDULE OF EQUIPMENT
DESCRIPTION
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ND/NEUTRAL BUS BARS
DEV.


ITING WIRING DETAILS		F.A.U RTE		SECTION				COUNTY		TOTAL SHEETS	SHEET NO.	
		275	9	22-00094-00-LT				COOK		21	15	
									CONTR	ACT	T NO. 61	K53
STA.	TO STA.	FED.	ROAD	DIST. I	NO.	ILLINOIS	FED.	AID F	PROJECT	1	WL3A(61	9)

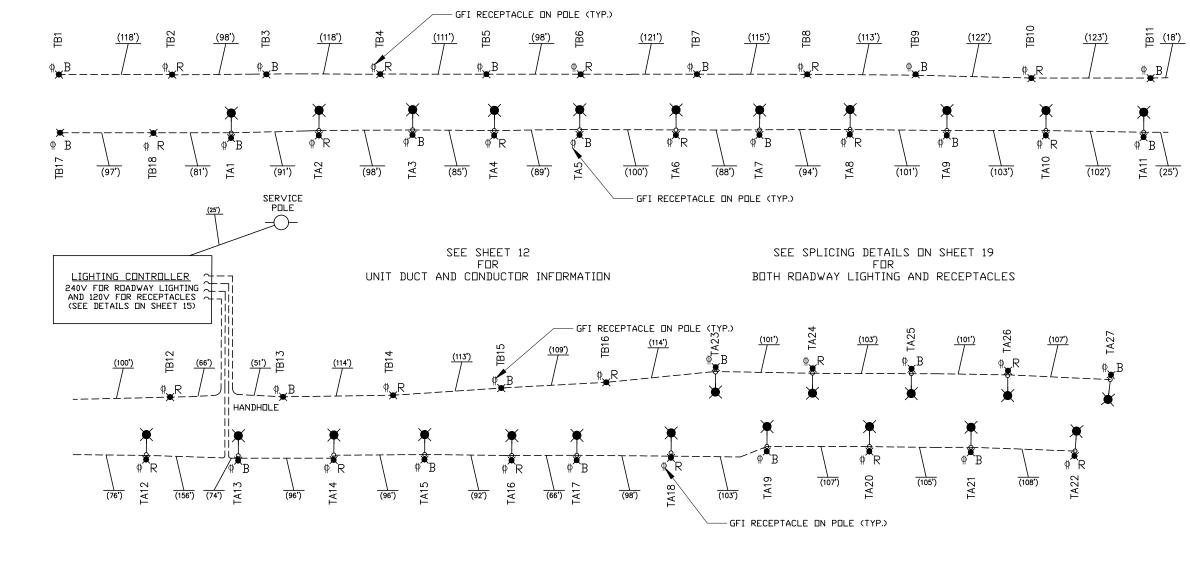

	USER NAME =	DESIGNED - JEF	REVISED - 5-22-24			F.A.U. SECTION	COUNTY TOTAL SHEET SHEETS NO.
FAU 2759 (DES PLAINES AVENUE) FAU 1459 (26TH STREET) TO FAU 1453 (CERMAK ROAD)		DRAWN - JFP	REVISED - 6-11-24	STATE OF ILLINOIS	SINGLE LINE DIAGRAM	2759 22-00094-00-LT	СООК 21 16
LED STREET LIGHTING	PLOT SCALE = PLOT DATE =	CHECKED – THK DATE – 2–22–24	REVISED - 7-17-24 REVISED -	DEPARTMENT OF TRANSPORTATION	SCALE: 1"=100' SHEET NO. OF SHEETS STA. TO STA.	FED. ROAD DIST. NO. ILLINOIS FED.	CONTRACT NO. 61K53

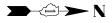



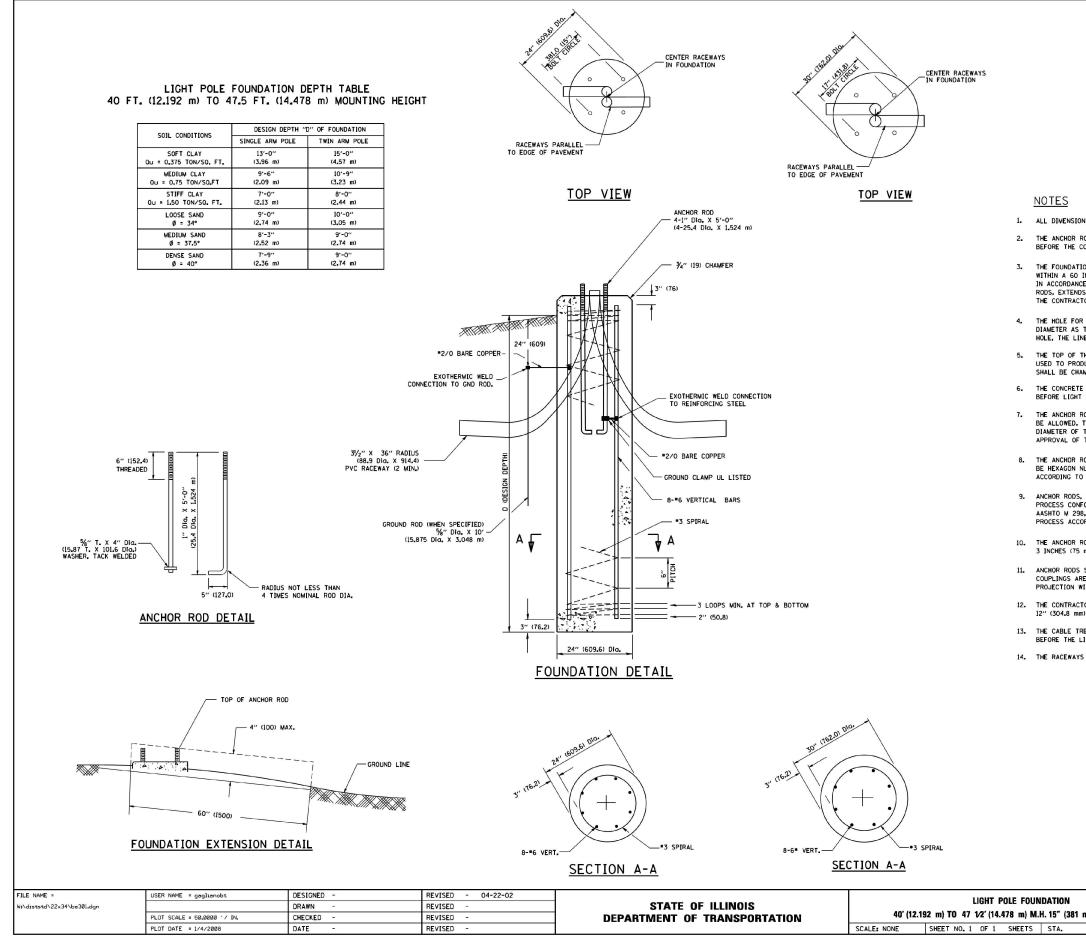

1. ALL DIMENSIONS ARE IN INCHES (MILLIMETERS) UNLESS OTHERWISE SHOWN.

THE ANCHOR RODS AND RACEWAYS SHALL BE PROPERLY SECURED IN PLACE BEFORE THE CONCRETE IN PLACED.

3. THE FOUNDATION SHALL NOT PROTRUDE MORE THAN 100MM (4 IN.) ABOVE THE FINISHED GRADE WITHIN A 60 IN. (1.5 m) CHORD ACROSS THE FOUNDATION, WITH ANCHOR RODS INCLUDED. IN ACCORDANCE WITH AASHTO GUIDELINES. IF THE FOUNDATION HEIGHT, INCLUDING ANCHOR RODS, EXTENDS BEYOND THESE SPECIFIED LIMITS, THE FOUNDATION SHALL BE REPLACED AT THE CONTRACTOR'S EXPENSE. SEE FOUNDATION EXTENSION DETAIL.

4. THE HOLE FOR THE FOUNDATION SHALL BE MADE BY DRILLING WITH AN AUGER, OF THE SAME DIAMETER AS THE FOUNDATION. IF SOIL CONDITIONS REQUIRE THE USE OF A LINER TO FORM THE HOLE, THE LINER SHALL BE WITHDRAWN AS THE CONCRETE IS DEPOSITED.

5. THE TOP OF THE FOUNDATION SHALL BE CONSTRUCTED LEVEL. A LINER OR FORM SHALL BE USED TO PRODUCE A UNFORM SMOOTH SIDE TO THE TOP OF THE FOUNDATION. FOUNDATION TOP CONTRACTOR WILL AND ADDRESS AND SHALL BE CHAMFERED 3/4-IN. (20 mm).

THE CONCRETE SHALL BE CLASS SJ. CONCRETE SHALL CURE ACCORDING TO ARTICLE 1020.13 BEFORE LIGHT POLES ARE INSTALLED.

7. THE ANCHOR ROD SHALL BE A HOOK ROD TYPE. COLD BENDING OF THE ANCHOR ROD WILL NOT BE ALLOWED. THE RADIUS OF THE HOOK BEND SHALL NOT BE LESS THAN 4 TIMES THE NOMINAL DIAMETER OF THE ANCHOR ROD. A TACK WELDED ANCHOR ROD MAY BE SUBSTITUTED WITH THE APPROVAL OF THE ENGINEER.

8. THE ANCHOR RODS SHALL BE ACCORDING TO ASTM F1554 GRADE 725 (GRADE 105). NUTS SHALL BE HEXAGON NUTS ACCORDING TO ASTM A 194 2H OR ASTM A 563 DH, AND WASHERS SHALL BE ACCORDING TO ASTM F 436.

9. ANCHOR RODS, NUTS AND WASHERS SHALL BE COMPLETELY GALVANIZED BY EITHER THE HOT-DIPPED PROCESS CONFORMING WITH AASHTO M 232. THE WECHANICAL PLATING METHOD CONFORMING TO AASHTO M 298, CLASS 50 WITH A MAXIMUM COATING THICKNESS OF 150 UM(6 MILS) OR THE ELECTROLYTIC PROCESS ACCORDING TO ASTM F 1136.

THE ANCHOR RODS SHALL BE THREADED A MINIMUM OF 6 INCHES (150 mm) WITH A MINIMUM OF 3 INCHES (75 mm) OF THREADED ANCHOR ROD EMBEDDED IN THE FOUNDATION.

11. ANCHOR RODS SHALL PROJECT 23/" (69.9 mm) ABOVE THE TOP OF THE FOUNDATION. IF BREAKAWAY COUPLINGS ARE SPECIFIED, THE CONTRACTOR SHALL CAREFULLY COORDINATE THE ANCHOR ROD PROJECTION WITH THE INSTALLATION REQUIREMENTS OF THE BREAKAWAY COUPLINGS.

12. THE CONTRACTOR SHALL USE A "3 SPIRAL AT 6" (152.4 mm) PITCH OR MAY SUBSTITUTE "3 TIES AT 12" (304.8 mm) O.C. WITH THE APPROVAL OF THE ENGINEER.

13. THE CABLE TRENCHES AND FOUNDATION SHALL BE BACK FILLED AND COMPACTED AS SPECIFIED BEFORE THE LIGHT POLE IS ERECTED.

14. THE RACEWAYS SHALL PROJECT 1" (25.4 mm) ABOVE THE TOP OF THE FOUNDATION.


ON	F.A.U. RTE	SECT	LION		COUNTY	TOTAL SHEETS	SHEET NO.
(381 mm) BOLT CIRCLE	2759	22-00094	-00-LT		COOK	21	17
(381 MM) BULT CIRCLE		BE-30			CONTRACT	NO.61	<53
A. TO STA.	FED. R	OAD DIST. NO. 1	ILLINOIS	FED. AID	PROJECT	H99H(73C)


FOUNDATION DESIGN TABLE

	DESIGN DEPTH C	F FOUNDATION		REINFORCEMENT	IN FOUNDATION	
TYPE OF SOIL	SINGLE ARM	TWIN ARM	SINGLE	ARM	TWIN	ARM
	D	D	VERT BARS	SPIRAL	VERT BARS	SPIRAL
SOFT CLAY	13'-0"	15'-0''	8-#6X12'-6''	#3X122'	8-#6X14'-3''	#3X141′
	(3.962 m)	(4.572 m)	(3.810 m)	(37.186 m)	(4.343 m)	(42.977 m)
MEDIUM CLAY	9'-6''	10'-9''	8- # 6X9'-0''	#3X90′	8- # 6X10'-0''	#3X100′
	(2 . 896 m)	(3.277 m)	(2 . 743 m)	(27 . 432 m)	(3 . 048 m)	(30.480 m)
STIFF CLAY	7'-0''	8'-0''	8-#6X6'-6''	#3X66′	8- # 6X7'-6''	#3X76′
	(2 . 134 m)	(2.438 m)	(1.981 m)	(20 . 112 m)	(2 . 286 m)	(23 . 165 m)
LOOSE SAND	9'-0''	10'-0''	8-#6X8'-6"	#3X85′	8- # 6X9'-6''	#3X94′
	(2.743 m)	(3.048 m)	(2.591 m)	(25.908 m)	(2 . 896 m)	(28 . 651 m)
MEDIUM SAND	8'-3''	9'-0''	8-#6X8'-0''	#3X78′	8-#6X8'-6''	#3X85'
	(2 . 515 m)	(2.743 m)	(2.438 m)	(23 . 774 m)	(2.591 m)	(25.908 m)
DENSE SAND	7'-9''	9'-0''	8-#6X7'-6''	#3X73'	8-#6X8'-6''	#3X85′
	(2 . 362 m)	(2.743 m)	(2_286 m)	(22.250 m)	(2 . 591 m)	(25.908 m)
ROCK OR SOLIDIFIED SLAG	5'-0'' (1.524 m)	5'-0'' (1.524 m)	NONE	NONE	NONE	NONE

NOTES

- 1. ALL DIMENSIONS ARE IN INCHES (MILLIMETERS) UNLESS OTHERWISE SHOWN.
- 2. THE ENGINEER SHALL DETERMINE THE CLASS OF SOIL DURING EXCAVATION AND SELECT THE DESIGN DEPTH OF FOUNDATION FROM THE DESIGN TABLE.
- 3. EXCAVATION OF THE POLE FOUNDATION SHALL BE MADE WITH AN AUGER, 24" (609.6 mm) OR 30" (762.0 mm) IN DIAMETER.
- 4. THE ANCHOR ROD SHALL BE A HOOK ROD TYPE. COLD BENDING OF THE ANCHOR ROD WILL NOT BE ALLOWED. THE RADIUS OF THE HOOK BEND SHALL NOT BE LESS THAN 4 TIMES THE NOMINAL DIAMETER OF THE ANCHOR ROD. A TACK WELDED ANCHOR ROD MAY BE SUBSTITUTED WITH THE APPROVAL OF THE ENGINEER.
- 5. THE ANCHOR BOLTS AND RACEWAYS SHALL BE PROPERLY SECURED IN PLACE BEFORE THE CONCRETE IS PLACED IN THE FORM.
- 6. THE ANCHOR RODS SHALL BE ACCORDING TO ASTM F1554 GRADE 725 (GRADE 105). NUTS SHALL BE HEXAGON NUTS ACCORDING TO ASTM A 194 2H OR ASTM A 563 DH, AND WASHERS SHALL BE ACCORDING TO ASTM F 436.
- 7. THE CONTRACTOR SHALL COORDINATE EXTENSION OF ANCHOR BOLTS ABOVE TOP OF FOUNDATION WITH THE BREAKAWAY DEVICE MANUFACTURER'S REQUIREMENTS. IF LIGHT POLE IS MOUNTED WITHOUT BREAKAWAY DEVICE, ANCHOR BOLTS SHALL PROJECT 23/4" (69.9 mm) ABOVE TOP OF THE FOUNDATION. THE CONTRACTOR SHALL CONFIRM ANCHOR BOLT EXTENTION WITH ENGINEER.
- 8. RACEWAYS SHALL PROJECT 1" (25.4 mm) ABOVE THE TOP OF THE FOUNDATION.
- 9. THE CABLE TRENCH SHALL BE BACKFILLED AND FIRMLY COMPACTED BEFORE THE LIGHT IS ERECTED.

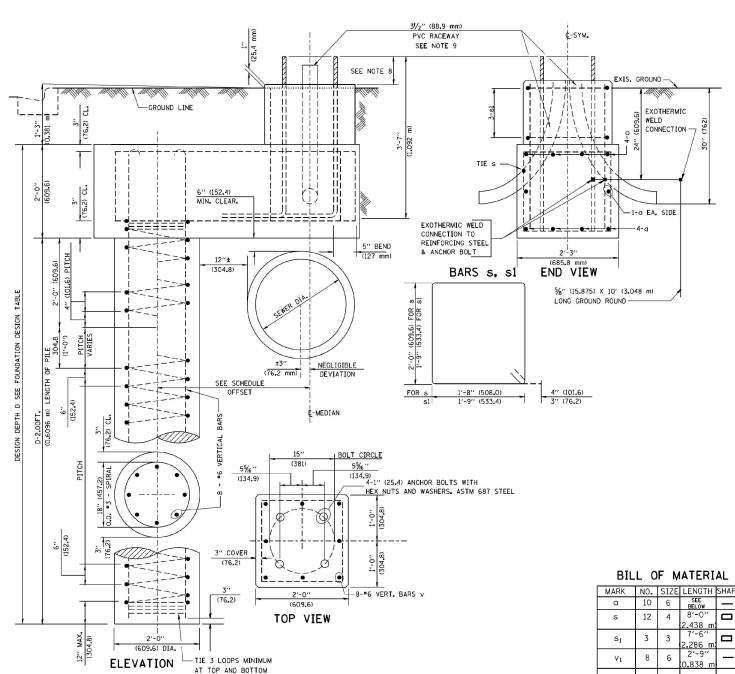

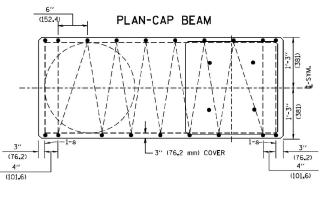

FILE NAME =	USER NAME = bauerdl	DESIGNED -	REVISED - 06-16-08 R. TOMSONS			LIGHT POLE FOUNDATION OFFSET	F_A_U RTF-	SECTION	COUNTY TOTAL SHEET SHEETS NO.
K:\diststd22x34\be310.dgn		DRAWN -	REVISED -	STATE OF ILLINOIS		40' (12.192 m) TO 47 1/2 ' (14.478 m) M.H.	2759	22-00094-00-LT	COOK 21 18
	PLOT SCALE = 50.000 '/ IN.	CHECKED -	REVISED -	DEPARTMENT OF TRANSPORTATION		15" (381 mm) BOLT CIRCLE		BE-310	CONTRACT NO.61K53
	PLOT DATE = 6/16/2008	DATE -	REVISED -		SCALE:	SHEET NO. 1 OF 1 SHEETS STA. TO STA.		ILLINOIS FED	

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MARK	NO.	SIZE	LENGTH	SHAPE
a	10	6	SEE BELOW	Ι
s	12	4	8'-0''	0
			2.438 m	
s ₁	3	3	7'-6''	
-1	-		2.286 m	
V1	8	6	2'-9''	_
11	Ŭ	Ŭ	0.838 m	
V ₂				

OFFSET SCHEDULE		
SEWER	PILE OFFSET	
DIAM. d	from¢-MED'N	ot BAR a
IN.	FΤ.	FT.
UP TO 24"	3'-3''	* 6 × 5'-3"
(609.6 mm)	(0.991 m)	(1.600 m)
27" (685.8 m)TO	3'-9''	5'-9''
36" (914.4 mm)	(1.143 m)	(1.753 m)
42" (1066.8 mm) TO	4'-6''	6'-6''
48" (1219.2 mm)	(1.372 m)	(1.981 m)
54" (1371.6 mm) TO	5'-0''	7'-0''
60" (1524.0 mm)	(1.524 m)	(2.134 m)
66" (1676.4 mm) TO	5'-6''	7'-6''
72" (1828.8 mm)	(1.676 m)	(2.286 m)

