STATE OF ILLINOIS

DEPARTMENT OF TRANSPORTATION

D-91-500-20

LOCATION OF SECTION INDICATED THUS: -

2020-101-RS&SW

COOK 93 1

FOR INDEX OF SHEETS, SEE SHEET NO. 2

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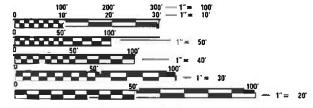
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THE PROJECT IS LOCATED IN THE VILLAGES OF ORLAND PARK, PALOHS HEIGHTS, AND WORTH,

SPEED LIMIT = 35, 40, 45 MPH TRAFFIC DATA:

159TH ST TO 151ST ST: 35,100 ADT (2019) 151ST ST TO 143RD ST: 33,800 ADT (2019) 143RD ST TO 135TH ST: 31,100 ADT (2019) 135TH ST TO ISHNALA DR: 30,300 ADT (2019) ISHNALA DR TO 127TH ST: 31,700 ADT (2019) 127TH ST TO 123RD ST: 29,400 ADT (2019) 123RD ST TO IL-83: 32,700 ADT (2019) IL-83 TO 115TH ST: 37,700 ADT (2019) 115TH ST TO 111TH ST: 34,200 ADT (2019)



FULL SIZE PLANS HAVE BEEN PREPARED USING STANDARD ENGINEERING SCALES, REDUCED SIZED PLANS WILL NOT CONFORM TO STANDARD SCALES, IN MAKING MEASUREMENTS ON REDUCED PLANS, THE ABOVE SCALES MAY BE USED.


JOINT UTILITY LOCATION INFORMATION FOR EXCAVATORS 1-800-892-0123

PROJECT ENGINEER: DANIEL WILGREEN (847) 705-4240 PROJECT MANAGER: FAWAD AQUEEL (847) 705-4247

PROPOSED HIGHWAY PLANS

ROUTE: F.A.P. 348 IL-43 (HARLEM AVENUE) 111TH ST TO US 6 (159TH ST) **SECTION: 2020–101–RS&SW** PROJECT: NHPP-2NNA(480) **SMART OVERLAY AND ADA IMPROVEMENTS COOK COUNTY**

C-91-298-20

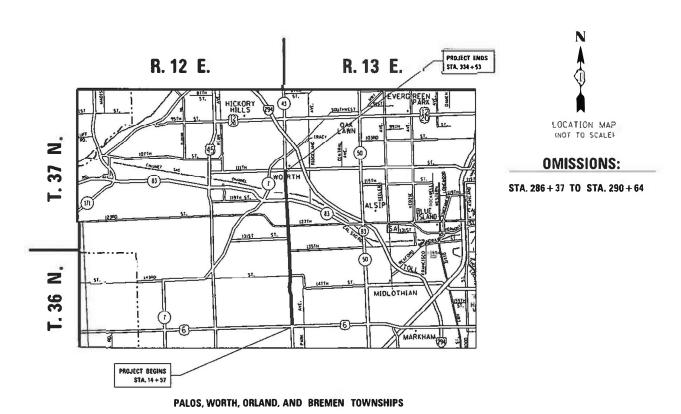

GROSS LENGTH = 31,996 FT. = 6.06 MILES NET LENGTH = 31,569 FT. = 5.98 MILES

STATE OF ILLINOIS DEPARTMENT OF TRANSPORTATION SUBMITTED DEDAKE LA

PRINTED BY THE AUTHORITY OF THE STATE OF ILLINOIS

CONTRACT NO. 62L79

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92	PD-05: PROJE	CT DETIAL FOR DEPRESSED CORNER	R CURB RAMPS	
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000001-08		ARD SYMBOLS, ABBREVIATIONS AND	PATTERNS	
424001-11	PERPEN	IDICULAR CURB RAMPS FOR SIDEWAI	LKS	
424006-05	DIAGON	NAL CURB RAMPS FOR SIDEWALKS		
424011-04	CORNE	R PARALLEL CURB RAMPS FOR SIDEV	VALKS	
424016-05	MID-BL0	OCK CURB RAMPS FOR SIDEWALKS		
424021-05	DEPRES	SSED CORNER FOR SIDEWALKS		
424026-03	ENTRAN	NCE / ALLEY PEDESTRIAN CROSSINGS	5	
424031-02	MEDIAN	N PEDESTRIAN CROSSINGS		
442201-03	CLASS	C AND D PATCHES		
		USER NAME = skinneral	DESIGNED -	REVISED -
			DRAWN -	REVISED -
		PLOT SCALE = 100.0000 ' / in. PLOT DATE = 10/15/2020	CHECKED - DATE -	REVISED -
				•

STANDARD NO. 606301-04	DESCRIPTION PC CONCRETE ISLANDS AND MEDIANS
701101-05	OFF-RD OPERATIONS, MULTILANE, 15' TO 24" FROM PAVEMENT EDGE
701426-09	LANE CLOSURE, MULTILANE, INTERMITTENT OR MOVING OPER., FOR SPEEDS >= 45 MPR
701427-05	LANE CLOSURE, MULTILANE, INTERMITTENT OR MOVING OPER., FOR SPEEDS <= 40 MPH
701428-01	TRAFFIC CONTROL SET UP AND REMOVAL FREEWAY/EXPRESSWAY
701601-09	URBAN LANE CLOSURE, MULTILANE, 1W OR 2W WITH NONTRAVERSABLE MEDIAN
701602-10	URBAN LANE CLOSURE, MULTILANE, 2W WITH BIDIRECTIONAL LEFT TURN LANE
701606-10	URBAN SINGLE LANE CLOSURE, MULTILANE, 2W WITH MOUNTABLE MEDIAN
701701-10	URBAN LANE CLOSURE, MULTILANE INTERSECTION
701801-06	SIDEWALK, CORNER OR CROSSWALK CLOSURE
701901-08	TRAFFIC CONTROL DEVICES
814001-03	HANDHOLES
	CENERAL NOTES

GENERAL NOTES

- 1. BEFORE STARTING ANY EXCAVATION, THE CONTRACTOR SHALL CALL "J.U.L.I.E."AT (800) 892-0123 OR 811 FOR FIELD LOCATIONS OF BURIED ELECTRIC, TÈLEPHONE AND GAS UTILITIES. 48 HOUR NOTIFICATION IS
- 2. TEN (10) FOOT TRANSITIONS SHALL BE USED TO MATCH PROPOSED CURB AND GUTTER AND MEDIAN ITEMS OF WORK TO EXISTING CURBS AND GUTTER AND MEDIANS IN THE FIELD, UNLESS OTHERWISE SHOWN. THE TRANSITIONS SHALL BE PAID FOR AT THE CONTRACT UNIT PRICE FOR THE PROPOSED ITEMS OF WORK SPECIFIED.
- 3. THE CONTRACTOR SHALL COORDINATE CONSTRUCTION ACTIVITIES WITH UTILITY COMPANIES AND THE VILLAGES OF WORTH, PALOS HEIGHTS, AND ORLAND PARK
- 4. THE CONTRACTOR WILL NOT BE ALLOWED TO SET UP A YARD OR FIELD OFFICE ON STATE PROPERTY WITHOUT WRITTEN PERMISSION FROM THE DEPARTMENT
- 5. SIDEWALK RAMPS MODIFICATIONS WITHIN THE LIMITS OF THE PROJECT SHALL CONFORM TO THE APPLICABLE HIGHWAY STANDARDS INCLUDED IN THE PLANS.
- 6. ANY PAVEMENT MARKINGS AND RAISED REFLECTIVE PAVEMENT MARKERS OBLITERATED BY MILLING AND RESURFACING OPERATIONS ON SIDE STREETS AND ENTRANCES SHALL BE REPLACED AND PAID FOR IN KIND.
- 7. ALL DAMAGE TO EXISTING PAVEMENT MARKINGS OR RAISED REFLECTIVE PAVEMENT MARKERS OUTSIDE THE REMOVAL LINE SHOWN ON THE PLANS SHALL BE REPLACED AT NO ADDITIONAL COST TO THE DEPARTMENT.
- 8. BEFORE BEGINNING ANY WORK, THE CONTRACTOR SHALL RETAIN AND RECORD FOR FUTURE REFERENCE, ALL EXISTING PAVEMENT MARKING LINES (AND RAISED REFLECTIVE PAVEMENT MARKERS) IN ORDER THAT THESE LOCATIONS CAN BE RE-ESTABLISHED FOR STRIPING. EXACT LOCATIONS OF ALL PAVEMENT MARKINGS SHALL BE AS DIRECTED BY THE
- 9. ALL PAVEMENT PATCHING LOCATIONS WILL BE DETERMINED IN THE FIELD BY THE ENGINEER.
- 10. LOCATION OF COMBINATION CONCRETE CURB AND GUTTER REMOVAL AND REPLACEMENT IOR COMBINATION CURB AND GUTTER (THE TYPE SPECIFIED ON THE PLANS)]. WILL BE DETERMINED IN THE FIELD BY THE ENGINEER
- 11. DRAINAGE ADJUSTMENT OR RECONSTRUCTION LOCATIONS WILL BE DETERMINED IN THE FIELD BY THE ENGINEER.
- 12. IT SHALL BE THE CONTRACTOR'S RESPONSIBILITY TO VERIFY ALL DIMENSIONS AND CONDITIONS EXISTING IN THE FIELD PRIOR TO CONSTRUCTION AND ORDERING OF MATERIALS.
- 13. FRAMES AND GRATES ADJUSTMENT OF PRIVATE UTILITIES WITHIN THE LIMITS OF THE IMPROVEMENTS SHALL BE DONE BY THEIR RESPECTIVE OWNERS AND ARE NOT PART OF THIS CONTRACT
- 14. SIDEWALK REMOVAL AND P.C.C. SIDEWALK 5" LOCATIONS SHALL BE DETERMINED BY THE ENGINEER.
- 15 THE CONTRACTOR SHALL CONTACT THE DISTRICT ONE ARTERIAL TRAFFIC CONTROL SUPERVISOR AT KALPANA.KANNAN-HOSADURGA@ILLINOIS.GOV A MINIMUM OF 72 HOURS IN ADVANCE OF BEGINNING WORK

SCALE:

GENERAL NOTES (CONT.)

- 16. THE RESIDENT ENGINEER SHALL CONTACT PATRICE HARRIS, AREA TRAFFIC FIELD TECHNICIAN AT PATRICE.HARRIS@ILLINOIS.GOV A MINIMUM OF TWO (2) WEEKS PRIOR TO THE PLACEMENT OF PERMANENT
- 17. THE CONTRACTOR SHALL BE REQUIRED TO PROVIDE ACCESS TO ABUTTING PROPERTY AT ALL TIMES DURING THE CONSTRUCTION OF THIS PROJECT.
- 18. THE CONTRACTOR WILL BE REQUIRED TO KEEP A RECORD OF THE LOCATIONS OF PLATED STRUCTURES BY STATION AND OFFSET LEFT OR RIGHT OF THE CENTERLINE OF PAVEMENT.
- 19. THE CONTRACTOR WILL BE REQUIRED TO KEEP A RECORD OF THE LOCATIONS OF THE BURIED STRUCTURES ACCORDING TO THE STATION AND DISTANCE LEFT OR RIGHT OF THE CENTERLINE OF PAVEMENT, UPON COMPLETION OF THE WORK, THE CONTRACTOR WILL DELIVER THE RECORD TO THE ENGINEER
- 20. EXISTING BROKEN FRAMES AND LIDS SHALL BE REMOVED AND DISPOSED OF BY THE CONTRACTOR AND SHALL BE REPLACED AS DIRECTED BY THE ENGINEER. REPLACEMENT FRAMES AND LIDS WILL BE PAID FOR ACCORDING TO ARTICLE 109.04 OF THE STANDARD SPECIFICATIONS UNLESS A SEPARATE PAY ITEM HAS BEEN PROVIDED.
- 21. DO NOT SCALE PLANS FOR CONSTRUCTION DIMENSIONS.
- 22. PAVEMENT MARKING TAPE, TYPE III SHALL BE USED FOR SHORT TERM PAVEMENT MARKINGS ON ALL FINAL SURFACES.
- 23. WHEN THE MILLED PAVEMENT IS OPEN TO TRAFFIC THE MAXIMUM GRADE DIFFERENTIAL BETWEEN PASSES OF THE MILLING MACHINE SHALL NOT EXCEED 1 1/2 INCHES (40 mm) WHERE THE SPEED LIMIT IS 40 MPH (80 km/h) OR LESS AND 1 INCH (25 mm) WHERE THE SPEED LIMIT IS GREATER THAN 40 MPH (80 km/h), WITH WRITTEN APPROVAL OF THE ENGINEER, A MAXIMUM GRADE DIFFERENTIAL OF 3 INCHES (75 mm) MAY BE ALLOWED IF THE EDGE OF THE MILLING IS SLOPED A MINIMUM 1:3 (V:H) OR A NOTCHED LONGITUDINAL WEDGE IS USED.
- 24. OVERNIGHT LANE CLOSURES SHALL NOT BE ALLOWED FOR REHABILITATION PROJECTS INVOLVING DAYTIME MILLING AND RESURFACING OPERATIONS AND CLASS D PATCHING UNLESS OTHER CONDITIONS WARRANT EXTENDED LANE CLOSURES AS DETERMINED AND APPROVED IN WRITING BY THE ENGINEER OR AS PROVIDED FOR IN THE CONTRACT SPECIFICATIONS.
- 25. CONTACT THE ROADSIDE DEVELOPMENT UNIT 72 HOURS PRIOR TO TREE REMOVAL AND WEED CONTROL AT (847) 705-4171.
- 26. DURING CONSTRUCTION OF PROPOSED IMPROVEMENTS ALONG 135TH STREET WEST OF HARLEM AVENUE, THE ROADWAY SHALL REMAIN OPEN FOR ALL TRAFFIC AT ALL TIMES, IF ANY ACTIVITY THAT REQUIRES ENCROACHMENT INTO A LANE OPEN FOR TRAFFIC. THAT ACTIVITY SHALL BE RESTRICTED TO WITHIN THE HOURS OF 9:00 AM TO 3:00 PM FOLLOWING THE APPLICABLE IDOT AND IDOT-DISTRICT 1 TRAFFIC CONTROL STANDARDS INCLUDED IN THE PLANS FOR OFF-ROAD AND ON-ROAD APPLICATIONS.
- 27. IF ANY EXISTING PAVEMENT MARKING AND/OR SIGNING ALONG 135TH STREET WEST OF HARLEM AVENUE IS DAMAGED DUE TO THE CONSTRUCTION OF THE PROPOSED IMPROVEMENT, THE CONTRACTOR SHALL REPLACE THE DAMAGED TRAFFIC CONTROL DEVICES TO THE SATISFACTION OF COOK COUNTY PER IDOT AND IDOT-DISTRICT 1 STANDARDS FOR TRAFFIC CONTROL DEVICES FOR PAVEMENT MARKING AND SIGNAGE INCLUDED IN THE PLANS.

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STATE OF ILLINOIS **DEPARTMENT OF TRANSPORTATION**

IL-43 (I	HARLEM	AVE) (111	TH STRE	ET TO	D US 6 (159TH ST))	
INDEX	OF SHEE	TS, STATE	STANDA	RDS	& GENERAL NOTES	
	SHEET	OF	SHEETS	STA.	TO STA.	

A.P. TE.	SECT	TION		COUNTY	TOTAL SHEETS	SHEET NO.			
348	2020-101	i-RS&SW	COOK 93 2						
				CONTRACT NO. 62L79					
		I	C						

	SUMMARY OF QUANTITIES				CC	ONSTRUCTION	ON TYPE C	ODE		SUMMARY OF QUANTITIES				C	ONSTRUCTIO	N TYPE CO	DE
CODE NO	ITEM	UNIT	TOTAL QUANTITIES URBAN	80% FEDERAL 20% STATE 0005	100% STATE 0005				CODE NO	ITEM	UNIT	TOTAL QUANTITIES URBAN	80% FEDERAL 20% STATE 0005	100% STATE 0005			
20100110	TREE REMOVAL (6 TO 15 UNITS DIAMETER)	UNIT	55	55					25100115	MULCH, METHOD 2	ACRE	0.4	0.4				
20100210	TREE REMOVAL (OVER 15 UNITS DIAMETER)	UNIT	60	60					25100630	EROSION CONTROL BLANKET	SO YD	15424	15424				
20101300	TREE PRUNING (1 TO 10 INCH DIAMETER)	EACH	10	10					25200110	SODDING, SALT TOLERANT	SO YD	1957	1957				
20101350	TREE PRUNING (OVER 10 INCH DIAMETER)	EACH	20	20					25200200	SUPPLEMENTAL WATERING	UNIT	85	85				
20200100	EARTH EXCAVATION	CU YD	141	141					40600290	BITUMINOUS MATERIALS (TACK COAT)	POUND	98837	98837				
20201200	REMOVAL AND DISPOSAL OF UNSUITABLE	CU YD	857	857					40600400		TON	330	330				
	MATERIAL									FLANGEWAYS							
21101600	TOPSOIL FURNISH AND PLACE, VARIABLE	SQ YD	17389	17389					40600982	HOT-MIX ASPHALT SURFACE REMOVAL - BUTT	SO YD	1811	1811				
	DEPTH									JOINT							
21101615	TOPSOIL FURNISH AND PLACE, 4"	SO YD	1717	1717					40601005	HOT-MIX ASPHALT REPLACEMENT OVER	TON	215	215				
										PATCHES							
25000115	SEEDING, CLASS 1B	ACRE	0.4	0.4													
									40605026	POLYMERIZED HOT-MIX ASPHALT SURFACE	TON	21525	21525				
25000210	SEEDING, CLASS 2A	ACRE	3. 2	3. 2						COURSE, STONE MATRIX ASPHALT, 9.5, MIX							
										"F", N80							
25000400	NITROGEN FERTILIZER NUTRIENT	POUND	251	251													
									42001300	PROTECTIVE COAT	SO YD	2748	2748				
25000500	PHOSPHORUS FERTILIZER NUTRIENT	POUND	251	251													
									42400200	PORTLAND CEMENT CONCRETE SIDEWALK 5	SO FT	12410	12410				
25000600	POTASSIUM FERTILIZER NUTRIENT	POUND	251	251						INCH							
25000750	MOWING	ACRE	13	13					42400800	DETECTABLE WARNINGS	SO FT	1206	1206				
25003115	INTERSEEDING, CLASS 1B	ACRE	2.8	2.8					44000100	PAVEMENT REMOVAL	SO YD	29	29			* = SI	REV-SEF PECIALTY ITEMS
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	SUMMARY OF QUANTITIES				CC)NSTRUCTI	ON TYPE C	ODE			SUMMARY OF QUANTITIES				CO	NSTRUCTI	ON TYPE CO	DDE	
CODE NO	ITEM	UNIT	TOTAL QUANTITIES URBAN	80% FEDERAL 20% STATE 0005	100% STATE 0005					CODE NO	ITEM	UNIT	TOTAL QUANTITIES URBAN	80% FEDERAL 20% STATE 0005	100% STATE 0005				
44000156	HOT-MIX ASPHALT SURFACE REMOVAL, 1	SO YD	219636	219636						60266600	VALVE BOXES TO BE ADJUSTED	EACH	10	10					
	3/4"																		
										60300105	FRAMES AND GRATES TO BE ADJUSTED	EACH	37	37					
44000200	DRIVEWAY PAVEMENT REMOVAL	SO YD	9	9															
										60300305	FRAMES AND LIDS TO BE ADJUSTED	EACH	67	67					
44000600	SIDEWALK REMOVAL	SO FT	12475	12475															
										60404950	FRAMES AND GRATES, TYPE 24	EACH	5	5					
44002212	HOT-MIX ASPHALT REMOVAL OVER PATCHES,	SO YD	1275	1275															
	3''									60406000	FRAMES AND LIDS, TYPE 1, OPEN LID	EACH	2	2					
																			<u> </u>
44201761	CLASS D PATCHES, TYPE I, 10 INCH	SO YD	6	6					:	* 66900200	NON-SPECIAL WASTE DISPOSAL	CU YD	141	141					
44001765	CLASS D DATOUES TYPE II 10 INCH	50.40	1007	1007									_						
44201765	CLASS D PATCHES, TYPE II, 10 INCH	SO YD	1097	1097					-	* 66900530	SOIL DISPOSAL ANALYSIS	EACH	5	5					
44201769	CLASS D PATCHES, TYPE III, 10 INCH	SO YD	200	200						* ((001001	DECLI ATED CURCTANCES DRE CONSTRUCTION	1.51154	,	,					
44201763	CLASS D FAICHES, TIPE III, 10 INCH	30 10	200	200						* 66901001	REGULATED SUBSTANCES PRE-CONSTRUCTION PLAN	LSUM	1	1					
44201771	CLASS D PATCHES, TYPE IV, 10 INCH	SO YD	141	141							FLAN								
									:	* 66901003	REGULATED SUBSTANCES FINAL CONSTRUCTION	LSUM	1	1					
60250200	CATCH BASINS TO BE ADJUSTED	EACH	1	1							REPORT		-						
60250400	CATCH BASINS TO BE ADJUSTED WITH NEW	EACH	2	2					:	* 66901006	REGULATED SUBSTANCES MONITORING	CAL DA	15	15					
	TYPE 1 FRAME, OPEN LID																		
										67000400	ENGINEER'S FIELD OFFICE, TYPE A	CAL MO	12	12					
60252800	CATCH BASINS TO BE RECONSTRUCTED	EACH	1	1															
										67100100	MOBILIZATION	L SUM	1	1					
60255500	MANHOLES TO BE ADJUSTED	EACH	5	5															
										70102630	TRAFFIC CONTROL AND PROTECTION.	L SUM	1	1					
60257900	MANHOLES TO BE RECONSTRUCTED	EACH	1	1							STANDARD 701601								
60260100	INLETS TO BE ADJUSTED	EACH	1	1						70102632	TRAFFIC CONTROL AND PROTECTION,	L SUM	1	1			¥ - 0	F SPECIALTY	REV-SEP
											STANDARD 701602								
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	PLOT DATE = 10/15/2020	DATE -		REVISED	-						SCALE: SHEET NO. OF	SHEETS ST.	A. TO	STA.	FED. RO	AD DIST. NO. 1	ILLINOIS FED. AID		02213

	SUMMARY OF QUANTITIES				CC	ONSTRUCTIO	N TYPE C	ODE				SUMMARY OF QUANTITIES				C	ONSTRUCTIO	N TYPE CO	DE
CODE NO	ITEM	UNIT	TOTAL QUANTITIES URBAN		100% STATE 0005					C	CODE NO	ITEM	UNIT	TOTAL QUANTITIES URBAN	80% FEDERAL 20% STATE 0005	100% STATE 0005			
70102635	TRAFFIC CONTROL AND PROTECTION.	L SUM	1	1						* 7	78000200	THERMOPLASTIC PAVEMENT MARKING - LINE	FOOT	95200	95200				
	STANDARD 701701											4"							
70102640	TRAFFIC CONTROL AND PROTECTION,	L SUM	1	1						* 7	78000400	THERMOPLASTIC PAVEMENT MARKING - LINE	FOOT	15925	15925				
	STANDARD 701801											6"							
70300100	SHORT TERM PAVEMENT MARKING	FOOT	16811	16811						* 7	78000500	THERMOPLASTIC PAVEMENT MARKING - LINE	FOOT	2719	2719				
												8"							
70300150	SHORT TERM PAVEMENT MARKING REMOVAL	SO FT	5604	5604						-									
										* 7	78000600	THERMOPLASTIC PAVEMENT MARKING - LINE	FOOT	4396	4396				
70300210	TEMPORARY PAVEMENT MARKING LETTERS AND	SO FT	2959	2959						-		12"							
	SYMBOLS									-	78000650	THERMOPLASTIC PAVEMENT MARKING - LINE	FOOT	2482	2482				
70300220	TEMPORARY PAVEMENT MARKING - LINE 4"	FOOT	95200	95200						*		24"	7001	2402	2402				
10300220	TEM ONANT FAZEMENT MAINTING ETTE	1 001	33200	33200															
70300240	TEMPORARY PAVEMENT MARKING - LINE 6"	FOOT	15925	15925						* 7	78008230	POLYUREA PAVEMENT MARKING TYPE I - LINE	FOOT	5	5				
												6"							
70300250	TEMPORARY PAVEMENT MARKING - LINE 8"	FOOT	2719	2719															
										* 7	78008250	POLYUREA PAVEMENT MARKING TYPE I - LINE	FOOT	6	6				
70300260	TEMPORARY PAVEMENT MARKING - LINE 12"	FOOT	4396	4396								12"							
70300280	TEMPORARY PAVEMENT MARKING - LINE 24"	FOOT	2482	2482						* 7	78100100	RAISED REFLECTIVE PAVEMENT MARKER	EACH	2460	2460				
70300520	PAVEMENT MARKING TAPE, TYPE III 4"	FOOT	8406	8406						7	78300200	RAISED REFLECTIVE PAVEMENT MARKER	EACH	2460	2460				
72400310	REMOVE SIGN PANEL - TYPE 1	SO FT	36	36								REMOVAL							
										* 8	35000200	MAINTENANCE OF EXISTING TRAFFIC SIGNAL	EACH	8	8				
72400710	RELOCATE SIGN PANEL - TYPE 1	SO FT	36	36								INSTALLATION							
78000100	THERMOPLASTIC PAVEMENT MARKING -	SO FT	2959	2959						* R	38600600	DETECTOR LOOP REPLACEMENT	FOOT	7486	7486				DE1/ 0==
	LETTERS AND SYMBOLS																	* = S	REV-SEF
FILE NAME =	USER NAME = skinneral D	ESIGNED -		REVISED	<u> </u>											F.A.P. RTE.	SECTIO	ON .	COUNTY TOTAL SHEET NO.
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		ATE -		REVISED	-		U	EPARTME	INI UF	IKAN	ISPUKIA	11014	SHEETS STA		O STA.	FED. R	DAD DIST. NO. 1 IL		CONTRACT NO. 62L79

	SUMMARY OF QUANTITIES				CO	NSTRUCTIO	ON TYPE C	ODE		SUMMARY OF QUANTITIES				CC	NSTRUCTIO	N TYPE CC	DE
CODE NO	ITEM	UNIT	TOTAL OUANTITIES URBAN	80% FEDERAL 20% STATE 0005	100% STATE 0005				CODE NO	ITEM	UNIT	TOTAL OUANTITIES URBAN	80% FEDERAL 20% STATE 0005	100% STATE 0005			
89500400	RELOCATE EXISTING PEDESTRIAN	EACH	7	7					x7030005	TEMPORARY PAVEMENT MARKING REMOVAL	SO FT	50869	50869				
	PUSH-BUTTON																
									Z0004562	COMBINATION CONCRETE CURB AND GUTTER	FOOT	3202	3202				
89502376	REBUILD EXISTING HANDHOLE	EACH	6	6						REMOVAL AND REPLACEMENT							
к0026700	TREE CARE	EACH	121	121					Z0018500	DRAINAGE STRUCTURES TO BE CLEANED	EACH	346		346			
K0029618	WEED CONTROL, BROADLEAF IN TURF	GALLON	30	30					Z0030850	TEMPORARY INFORMATION SIGNING	SO FT	52	52				
X0320050	CONSTRUCTION LAYOUT (SPECIAL)	L SUM	1	1					Z0033700	LONGITUDINAL JOINT SEALANT	FOOT	65974	65974				
X0325222	WEED CONTROL, BASAL TREATMENT	GALLON	30	30					Z0064800	SELECTIVE CLEARING	UNIT	16	16				
									Ø 20076600	TRAINEES	HOURS	500	500				
X0326681	REMOVE AND RE-ERECT BOULDERS	L SUM	1	1					Ø 20076604	TRAINEES - TRAINING PROGRAM GRADUATE	HOURS	500	500				
X0327611	REMOVE AND REINSTALL BRICK PAVER	SO FT	125	125													
X4240800	DETECTABLE WARNINGS (SPECIAL)	SO FT	200	200													
X4400501	COMBINATION CURB AND GUTTER REMOVAL AND REPLACEMENT LESS THAN OR EQUAL TO 10 FEET	FOOT	1227	1227													
X4402020	CONCRETE MEDIAN SURFACE REMOVAL	SO FT	138808	138808													
x5537800	STORM SEWERS TO BE CLEANED 12"	FOOT	2100		2100												
x6026624	VALVE BOXES TO BE ADJUSTED (SPECIAL)	EACH	5	5													
V6030310	FRAMES AND LIDS TO BE ADJUSTED	FACU	25	25													
x6030310	(SPECIAL)	EACH	25	25													Ø 004 REV-SE
																* = S	PECIALTY ITEMS
FILE NAME = pw:\\planroom.dotJiilnots	Sport-PWIDOT-Documents/IDOT Of Tices/District NProjects/DI50020-CADData/Design/DI50020-Sr/BR. PLOT SCALE = 100,0000 '/ in. CHI	SIGNED - ANN - ECKED - TE -	1	REVISED REVISED REVISED REVISED	- - -		DI		ILLINOIS TRANSPORTA		IARY OF QUANT		O STA.	F.A.P. RTE. 348	SECTIO 2020-101-F	S&SW	COUNTY TOTAL SHEETS NO COOK 93 6 CONTRACT NO. 62L7

LANDSCAPING SCHEDULE										
TREATMENT	UNIT	QUANTITY								
TREATMENT A										
SELECTIVE CLEARING	UNIT	116								
INTERSEEDING, CLASS 1B	ACRE	2.8								
TREATMENT B										
SELECTIVE CLEARING	UNIT	16								
TOPSOIL FURNISH AND PLACE, VARIABLE DEPTH	SQ YD	1725								
SEEDING, CLASS 1B	ACRE	0.4								
FERTILIZER NUTRIENTS	POUNDS	32								
MULCH METHOD 2	ACRE	0.4								
TREATMENT C										
CONCRETE MEDIAN SURFACE REMOVAL, 4"	SQ FT	138808								
REMOVAL AND DISPOSAL OF UNSUITABLE MATERIAL	CU YD	857								
TOPSOIL FURNISH AND PLACE, VARIABLE DEPTH	SQ YD	15424								
SEEDING, CLASS 2A	ACRE	3.2								
FERTILIZER NUTRIENTS	POUND	287								
EROSION CONTROL BLANKET	SQ YD	15424								

LANDSCAPING OPERATIONS CALENDAR									
DATES	DESCRIPTION								
MARCH 1 – APRIL 15	TREE REMOVAL								
MARCH 1 – APRIL 15	SELECTIVE CLEARING								
MARCH 1 – APRIL 15	TREE PRUNING								
APRIL 1 – NOVEMBER 1	TREE CARE								
APRIL 1 – NOVEMBER 1	WEED CONTROL, BASAL TREATMENT								
APRIL 1 – MAY 1	MOWING (CYCLE 1)								
MAY 1 – JUNE 30	WEED CONTROL, BROADLEAF IN TURF								
JULY 1 – AUGUST 1	MOWING (CYCLE 2)								
AUGUST 1 - NOVEMBER 1	INTERSEEDING, CLASS 1B								
AUGUST 1 – NOVEMBER 1	INTERSEEDING, CLASS 2A								

TREATMENT LOCATIONS

TREATMENT A										
START STA.	END STA.	AREA (SF)	LT/RT	OFFSET						
49+90	50+00	100	RT	54.9'						
50+25	50+35	100	RT	54.5'						
56+00	56+10	100	RT	54.4'						
58+40	58+50	100	LT	46.5'						
60+20	60+30	100	RT	56'						
62+30	72+00	14550	RT	50'						
86+00	88+00	3000	LT	50'						
86+00	88+00	3000	RT	50'						
90+00	100+00	10000	RT	50'						
103+00	113+00	15000	RT	50'						
108+00	113+00	7500	LT	50'						
124+50	130+00	5500	RT	50'						
132+00	147+00	15000	RT	50'						
159+00	168+25	9250	RT	50'						
161+00	164+00	3000	LT	50'						
166+50	167+80	1300	LT	50'						
175+00	179+00	6000	LT	50'						
176+00	179+50	5250	RT	50'						
186+00	190+00	4000	RT	50'						
193+00	198+00	7500	LT	50'						
193+00	195+50	2500	RT	50'						
197+00	199+00	2000	RT	50'						
284+37	286+37	4000	RT	56.7'						
290+46	290+76	300	LT	50'						
331+90	332+00	100	RT	44.6						

TREATMENT B											
START STA.	END STA.	AREA (SF)	LT/RT	OFFSET							
202+50	204+50	1000	LT	50'							
207+00	208+70	850	LT	50'							
209+55	212+20	1325	LT	50'							
214+50	215+50	500	LT	50'							
218+25	220+45	1100	LT	50'							
270+30	271+50	1200	RT	50'							
284+87	286+37	1500	LT	50'							
291+00	295+50	1300	RT	50'							
297+00	298+30	6750	LT	52.4							

TREATMENT C - MEDIAN REMOVAL						
START STA.	END STA.	AREA (SF)	VOLUME (CF)	VOLUME (CY)		
67+45	118+30	62277	10379	384		
124+39	130+87	7318	1220	45		
132+56	149+90	21423	3571	132		
151+64	157+90	7269	1211	45		
159+58	164+19	4124	687	25		
165+86	172+02	6494	1082	40		
175+96	185+64	11261	1877	70		
186+50	199+11	15220	2537	94		
294+44	298+64	3421	570	21		

LANDSCAPING LEGEND



TREATMENT A



TREATMENT B



TREATMENT C

NOTES

NOTE 1: LOCATIONS FOR TREE REMOVAL AND TREE PRUNING WILL BE DETERMINED IN THE FIELD BY THE RESIDENT ENGINEER

NOTE 2: DEPTH FOR REMOVAL AND DISPOSAL OF UNSUITABLE MATERIAL IS 2" FOR TREATMENT C.


USER NAME = skinneral	DESIGNED -	REVISED -
	DRAWN -	REVISED -
PLOT SCALE = 5000.0000 ' / in.	CHECKED -	REVISED -
PLOT DATE = 10/15/2020	DATE -	REVISED -

STATE OF ILLINOIS DEPARTMENT OF TRANSPORTATION

SCHEDULE OF QUANTITIES						F. R
IL. ROUTE 43	(HARLEM	AVE.) (1	11TH ST.	TO U.S	. ROUTE 6 (159TH ST.))	-
SCALE:	SHEET	OF	SHEETS	STA.	TO STA.	


A.P.	A.P. SECTION			COUNTY	TOTAL SHEETS	SHEET NO.
348	8 2020-101-RS&SW			СООК	93	7
			CONTRACT	NO. 62	2L79	
		ILLINOIS	FED. A	ID PROJECT		

IL -43 (HARLEM AVE.)

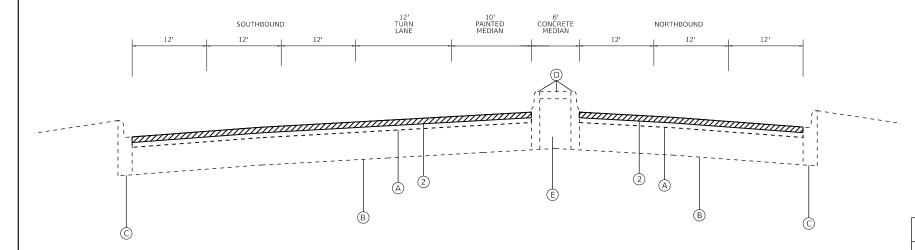

EXISTING TYPICAL SECTION STA. 14+57 TO STA. 31+52

IL -43 (HARLEM AVE.)

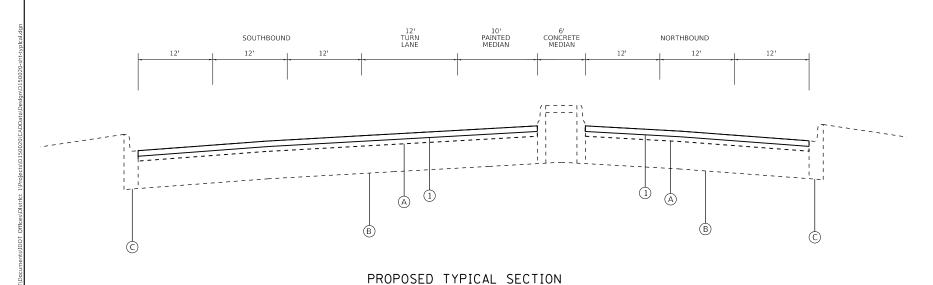

DRAWN REVISED HECKED REVISED DATE

REVISED

DESIGNED -

JSER NAME = skinneral

PLOT DATE = 10/16/2020

STA. 14+57 TO STA. 31+52

STATE OF ILLINOIS **DEPARTMENT OF TRANSPORTATION**

LEGEND - EXISTING:

- (A) HOT-MIX ASPHALT PAVEMENT, 3.0" +/-
- (B) PORTLAND-CEMENT CONCRETE PAVEMENT, 10" +/-
- C COMBINATION CONCRETE CURB & GUTTER, B-6.24 & VARIES
- (D) CONC. MEDIAN SURFACE & COMBINATION CONCRETE CURB & GUTTER, B-9.12
- E SAND FILL

LEGEND - PROPOSED

- ① POLYMERIZED HMA SURFACE COURSE, STONE MATRIX ASPHALT, 9.5, MIX "F", N80, 1.75"
 ② HOT-MIX ASPHALT SURFACE REMOVAL, 1.75"
- 3 CONCRETE MEDIAN SURFACE REMOVAL, 4"
- 4 REMOVAL AND DISPOSAL OF UNSUITABLE MATERIAL, 2"
- 5 TOPSOIL FURNISH & PLACE, VARIABLE DEPTH
- 6 FERTILIZER NUTRIENTS
- 7 EROSION CONTROL BLANKET
- 8 SEEDING CLASS 2A

NOTES:

- 1.) THE CONTRACTOR SHALL DO PATCHES BEFORE MILLING.
- 2.) THE LONGITUDINAL JOINT SEALANT SHALL BE PLACED OVER THE MILLED SURFACE.

HOT-MIX ASPHALT MIXTURE REQUIREMENTS	S	QUALITY MANAGEMENT		
MIXTURE TYPE	AIR VOIDS	PROGRAM (QMP)		
SMART OVERLAY				
POLYMERIZED HMA SURFACE COURSE, STONE MATRIX ASPHALT, 9.5, MIX "F", N80	3.5% AT 80 GYR	PFP		
PATCHING				
CLASS D PATCHES (HMA BINDER IL-19 mm)	4.0% AT 70 GYR	QC/QA		
HMA REPLACEMENT OVER PATCHES (HMA BINDER IL-19 mm)	4.0% AT 70 GYR	QC/QA		
QMP DESIGNATION: QUALITY CONTROL/QUALITY ASSURANCE (QC/QA); QUALITY CONTROL FOR PERFOR	MANCE (QCP); PAY FOR PE	RFORMANCE (PFP)		


- NOTE 1: THE UNIT WEIGHT USED TO CALCULATE ALL HMA SURFACE MIXTURE QUANTITIES IS 112 LBS/SQ YD/IN.
- NOTE 2: THE "AC TYPE" FOR POLYMERIZED HMA MIXES SHALL BE "SBS/SBR PG 76-22" AND FOR NON-POLYMERIZED HMA THE "AC TYPE" SHALL BE "PG 64-22" UNLESS MODIFIED BY SPECIAL PROVISIONS.


FOR USE OF RECYCLED MATERIALS SEE SPECIAL PROVISIONS.

NOTE 3: QUALITY MANAGEMENT PROGRAM (QMP) IDENTIFIES THE PARTICULAR QUALITY CONTROL SPECIFICATION THAT

APPLIES TO THE HMA MIXTURE.

SECTION TYPICAL SECTIONS 2020-101-RS&SW COOK 93 8 IL 43 - 111TH ST TO US 6 (159TH ST) CONTRACT NO. 62L79 OF SHEETS STA.

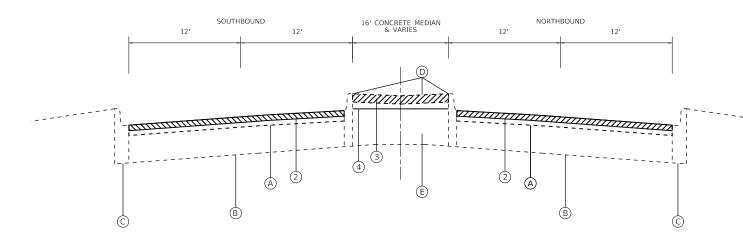

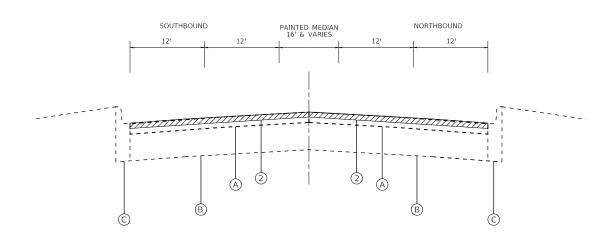

EXISTING TYPICAL SECTION STA. 31+52 TO STA. 208+26

IL -43 (HARLEM AVE.)

16' CONCRETE MEDIAN & VARIES

673

12"

12'

12'

LEGEND - EXISTING:


EXISTING TYPICAL SECTION STA. 208+26 TO STA. 286+37 STA. 290+64 TO STA. 334+53

- A HOT-MIX ASPHALT PAVEMENT, 3.0" +/-
- B PORTLAND-CEMENT CONCRETE PAVEMENT, 10" +/-
- COMBINATION CONCRETE CURB & GUTTER, B-6.24 & VARIES
- O CONC. MEDIAN SURFACE & COMBINATION CONCRETE CURB & GUTTER, B-9.12
- E SAND FILL

LEGEND - PROPOSED

- POLYMERIZED HMA SURFACE COURSE, STONE MATRIX ASPHALT, 9.5, MIX "F", N80, 1.75" HOT-MIX ASPHALT SURFACE REMOVAL, 1.75"
- CONCRETE MEDIAN SURFACE REMOVAL, 4"
- REMOVAL AND DISPOSAL OF UNSUITABLE MATERIAL, 2"
- TOPSOIL FURNISH & PLACE, VARIABLE DEPTH
- 6 FERTILIZER NUTRIENTS
- 7 EROSION CONTROL BLANKET
- 8 SEEDING CLASS 2A

IL -43 (HARLEM AVE.)

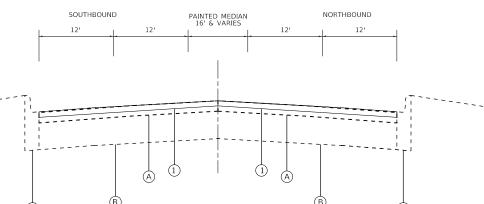

PROPOSED TYPICAL SECTION STA. 31+52 TO 208+26

PROPOSED TYPICAL SECTION STA. 208+26 TO STA. 286+37 STA. 290+64 TO STA. 334+53


СООК 93 9


CONTRACT NO. 62L79


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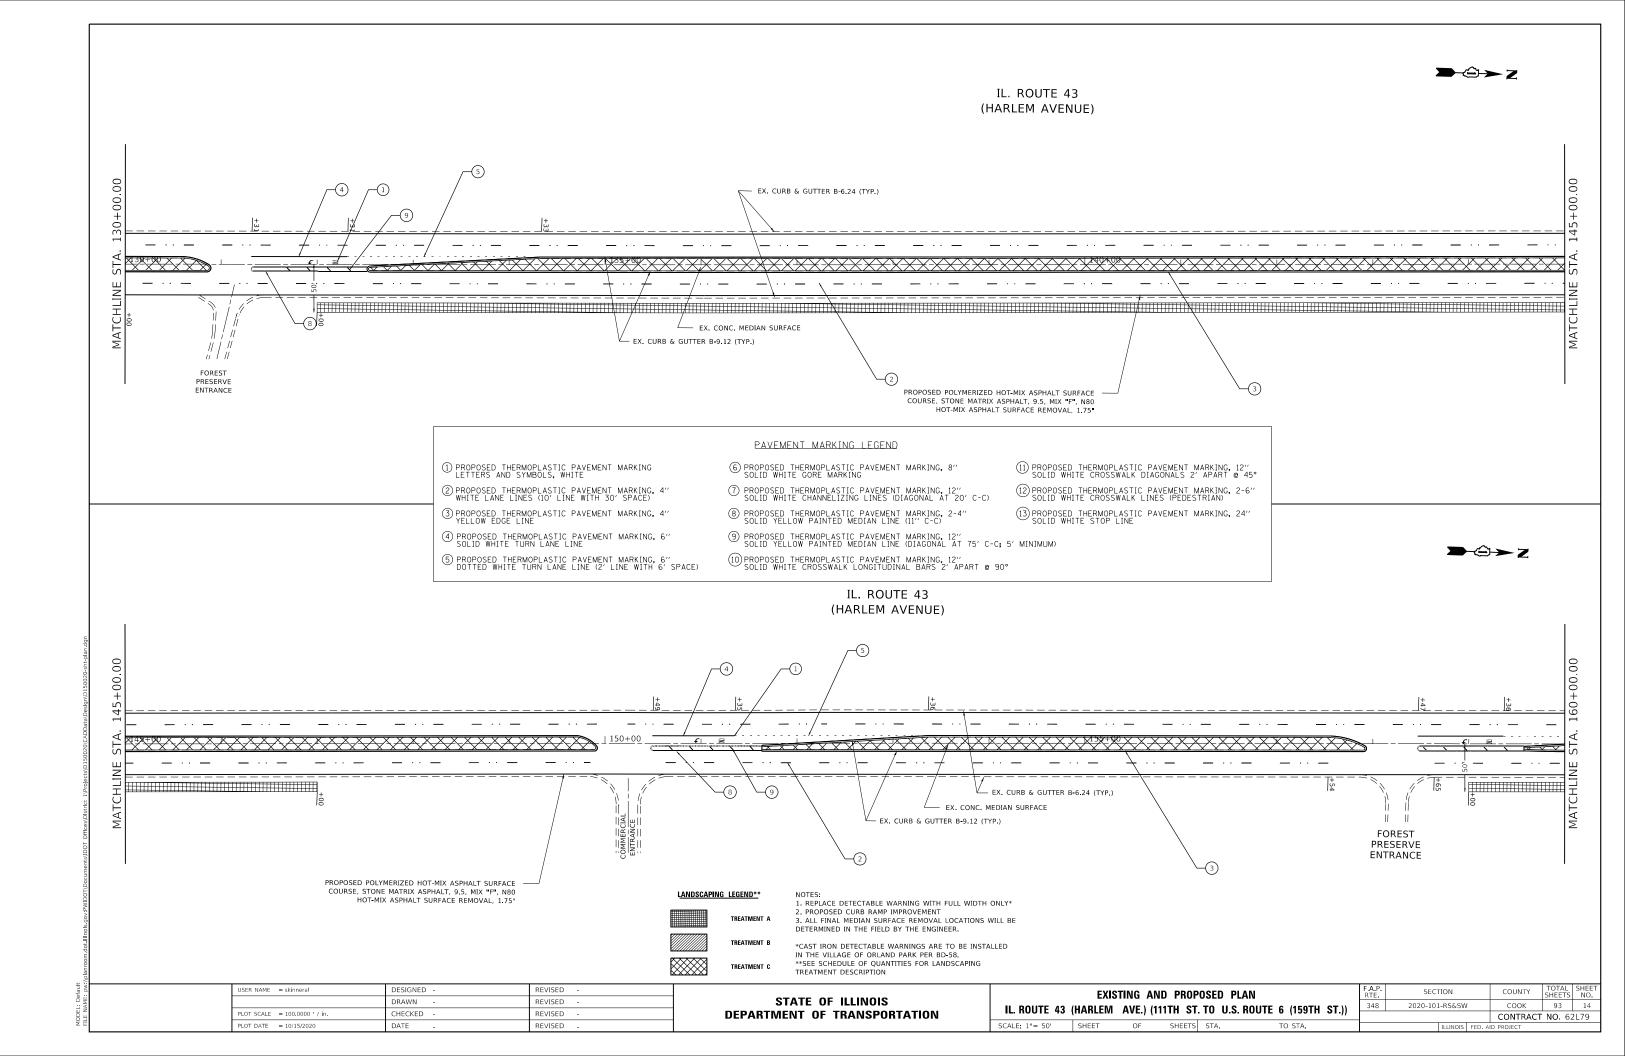
STATE OF ILLINOIS **DEPARTMENT OF TRANSPORTATION**


SECTION TYPICAL SECTIONS 2020-101-RS&SW IL 43 - 111TH ST TO US 6 (159TH ST) OF SHEETS STA.




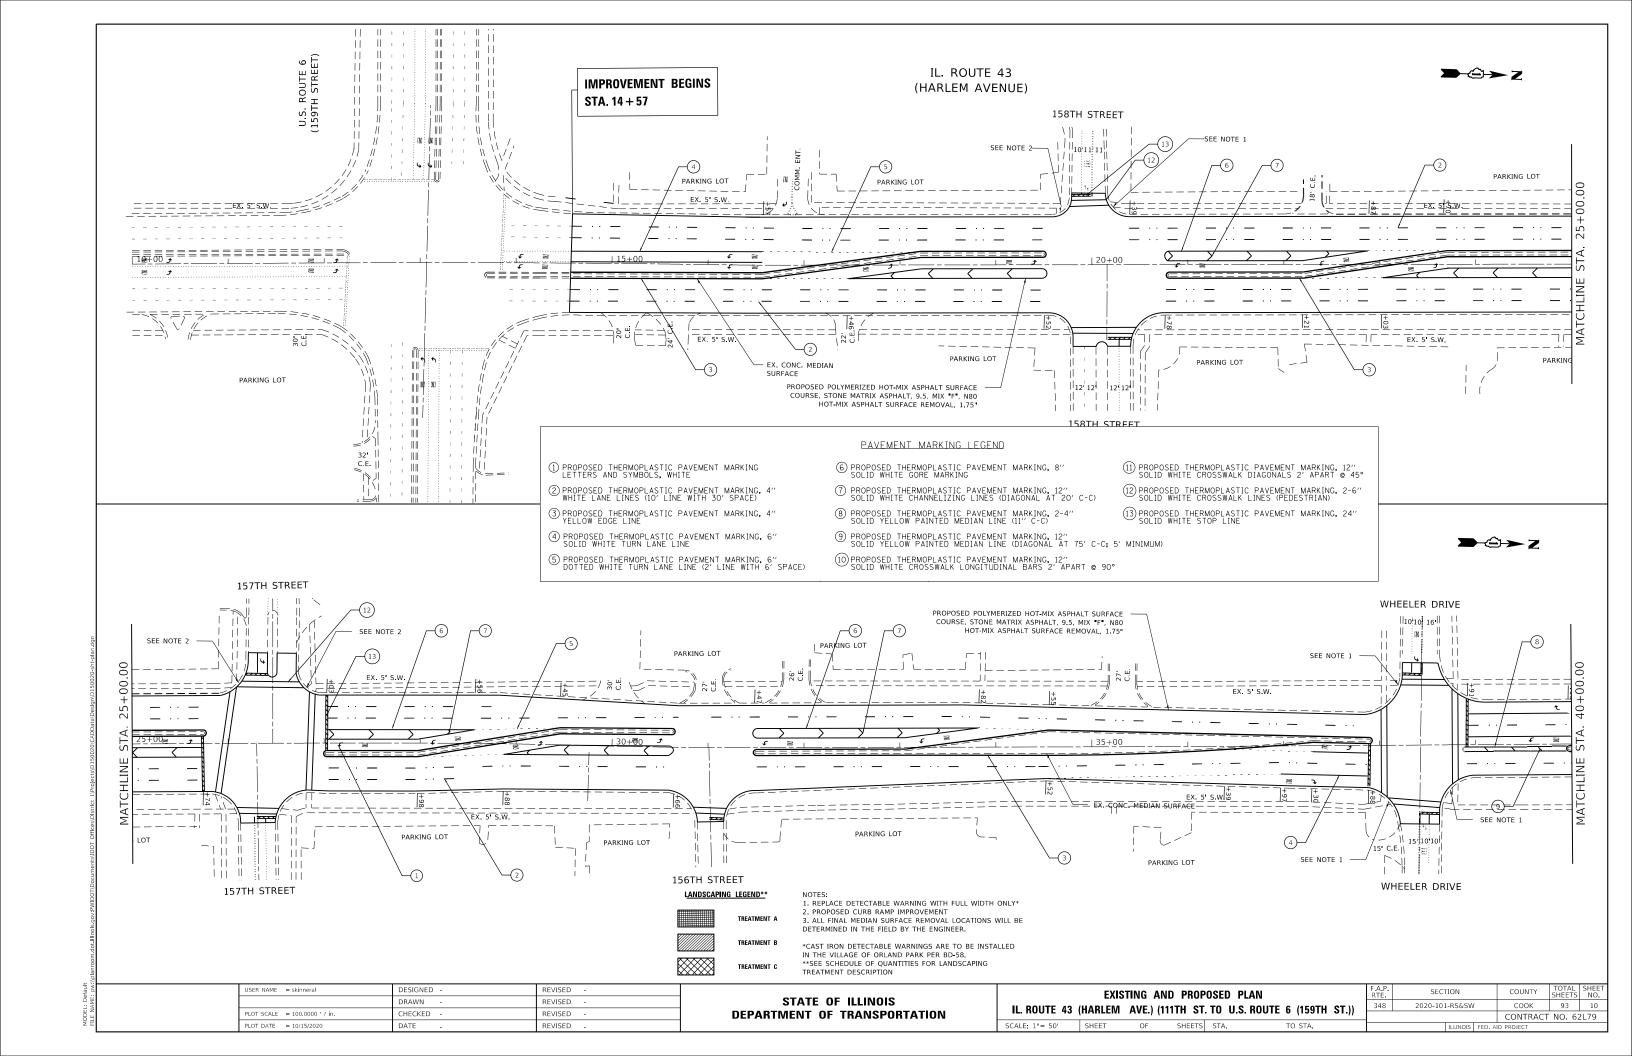


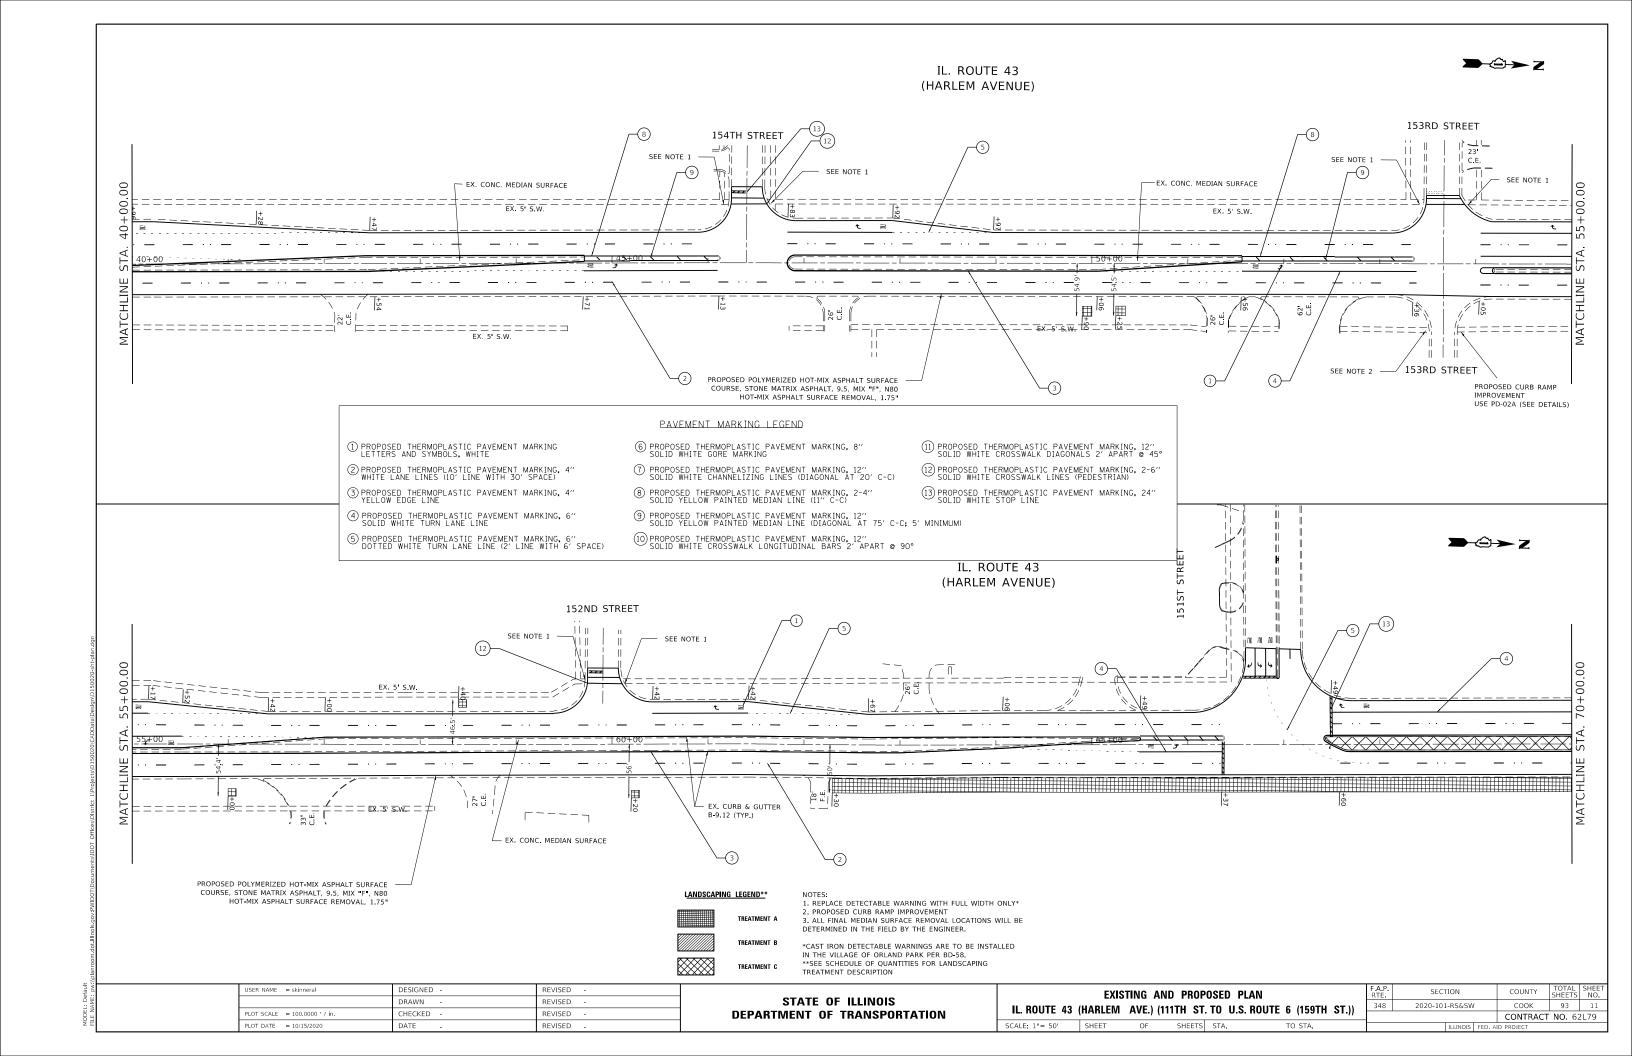


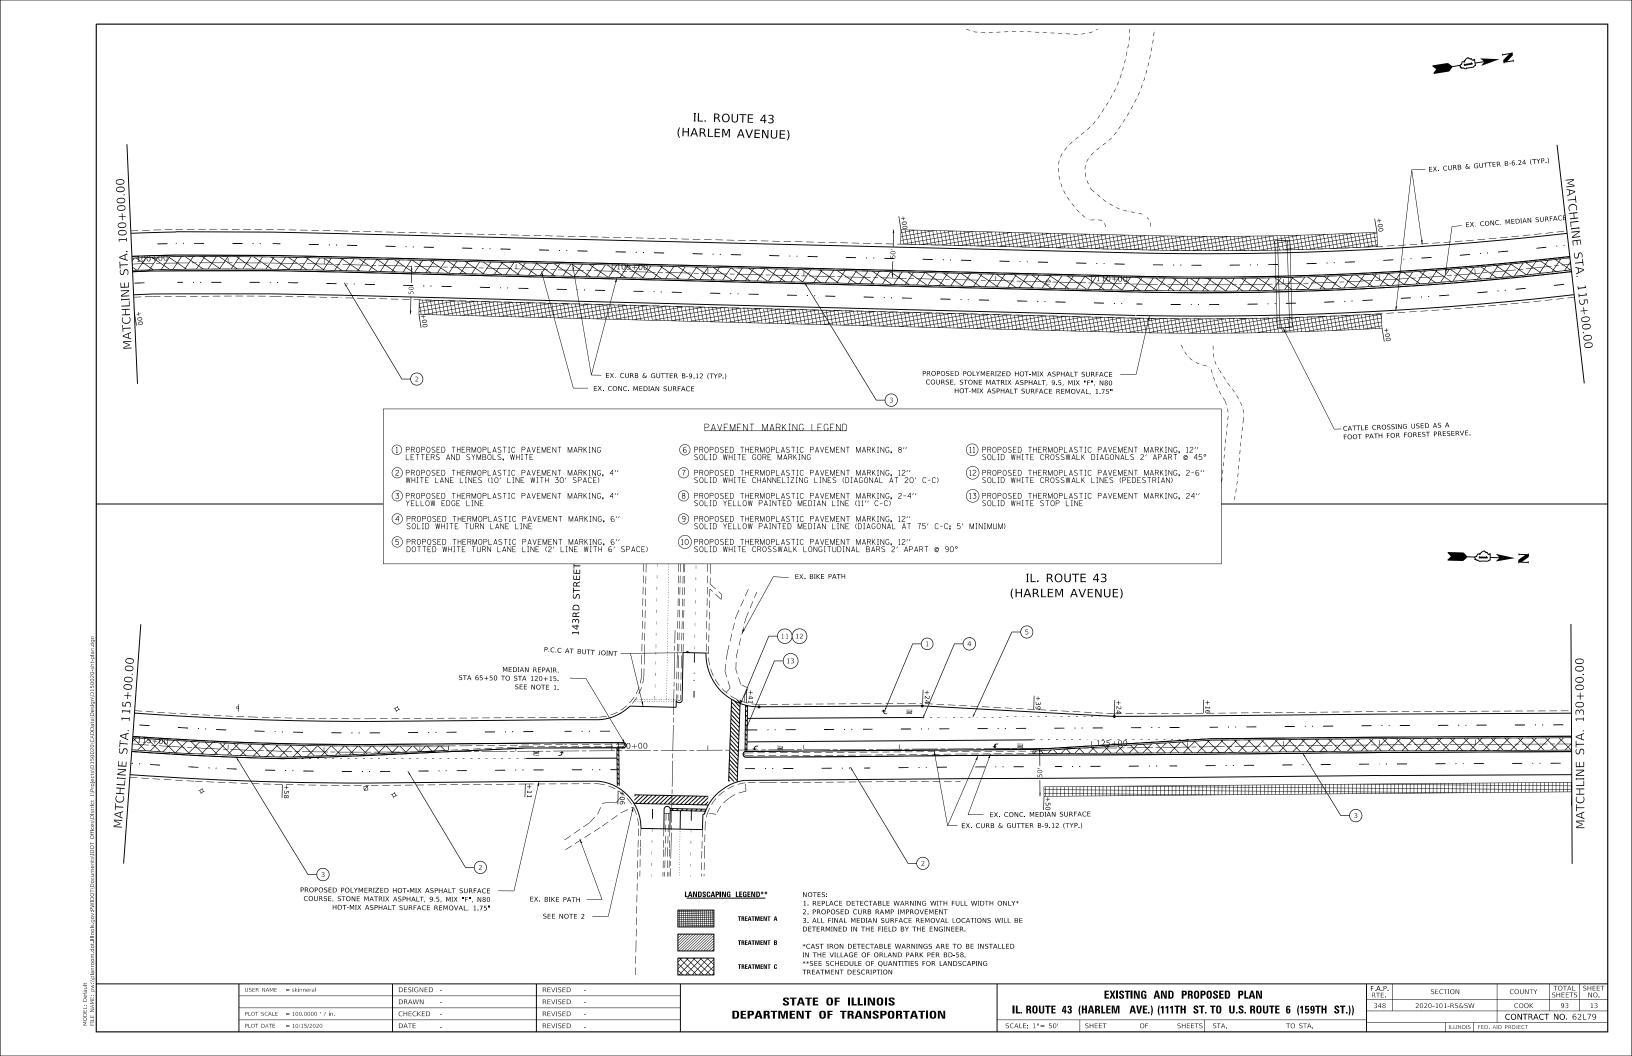


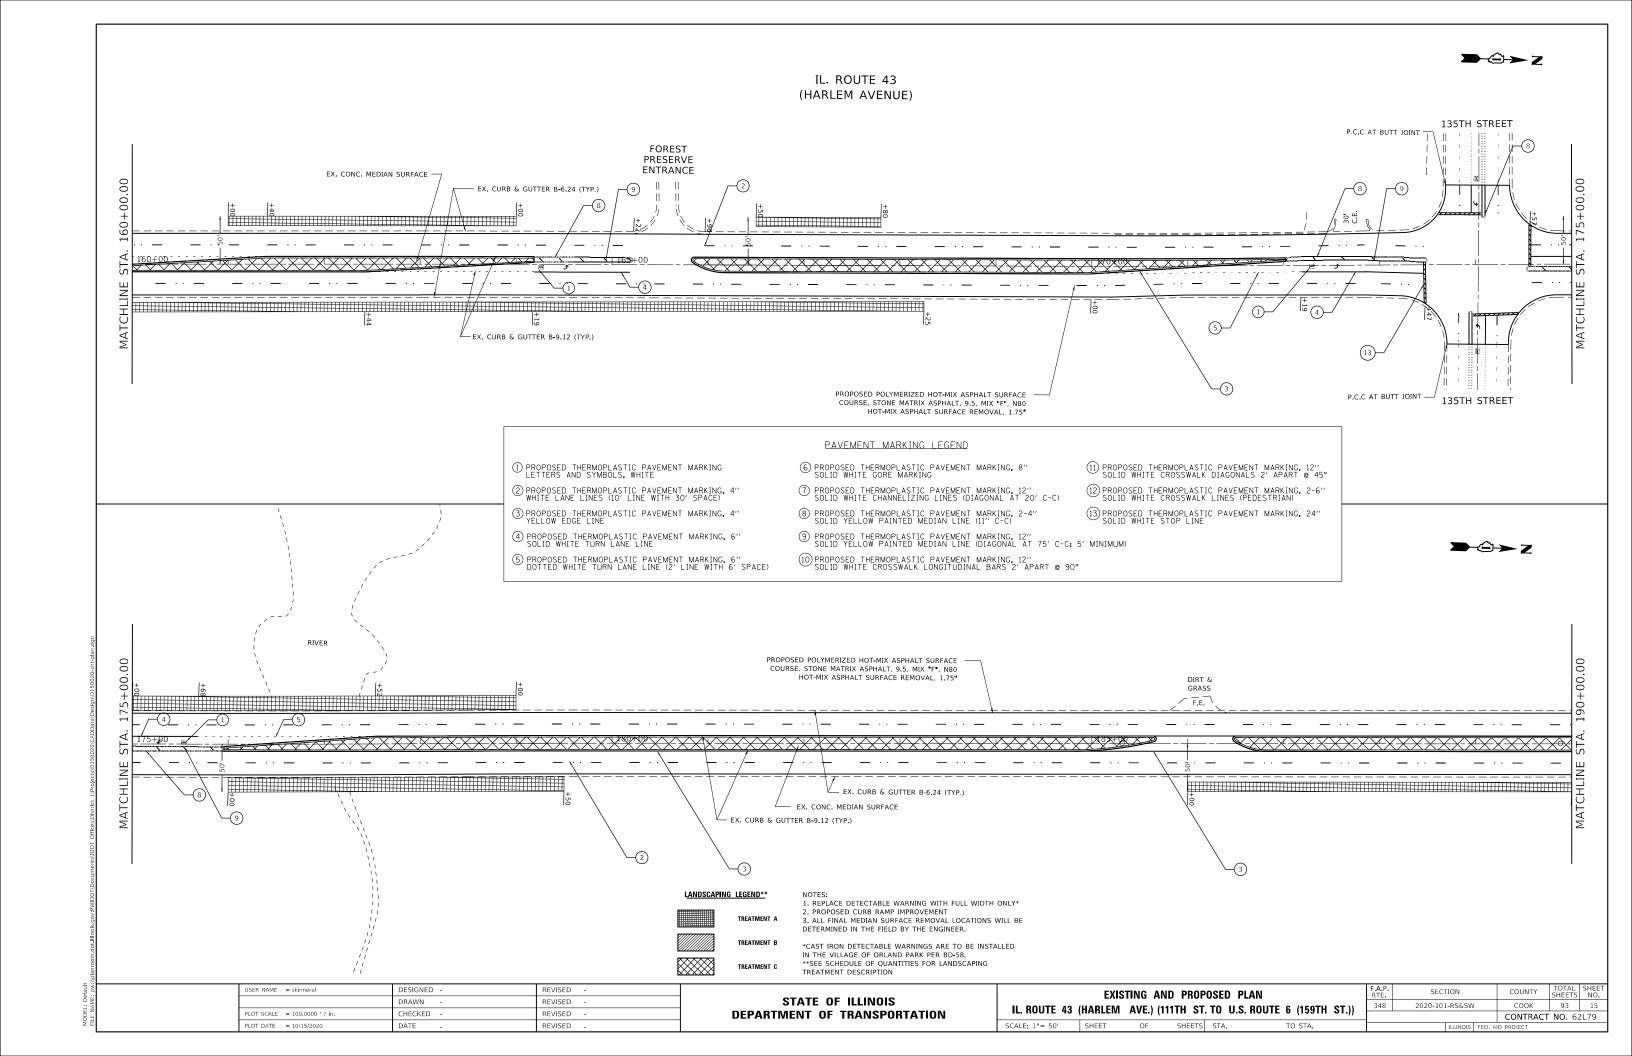

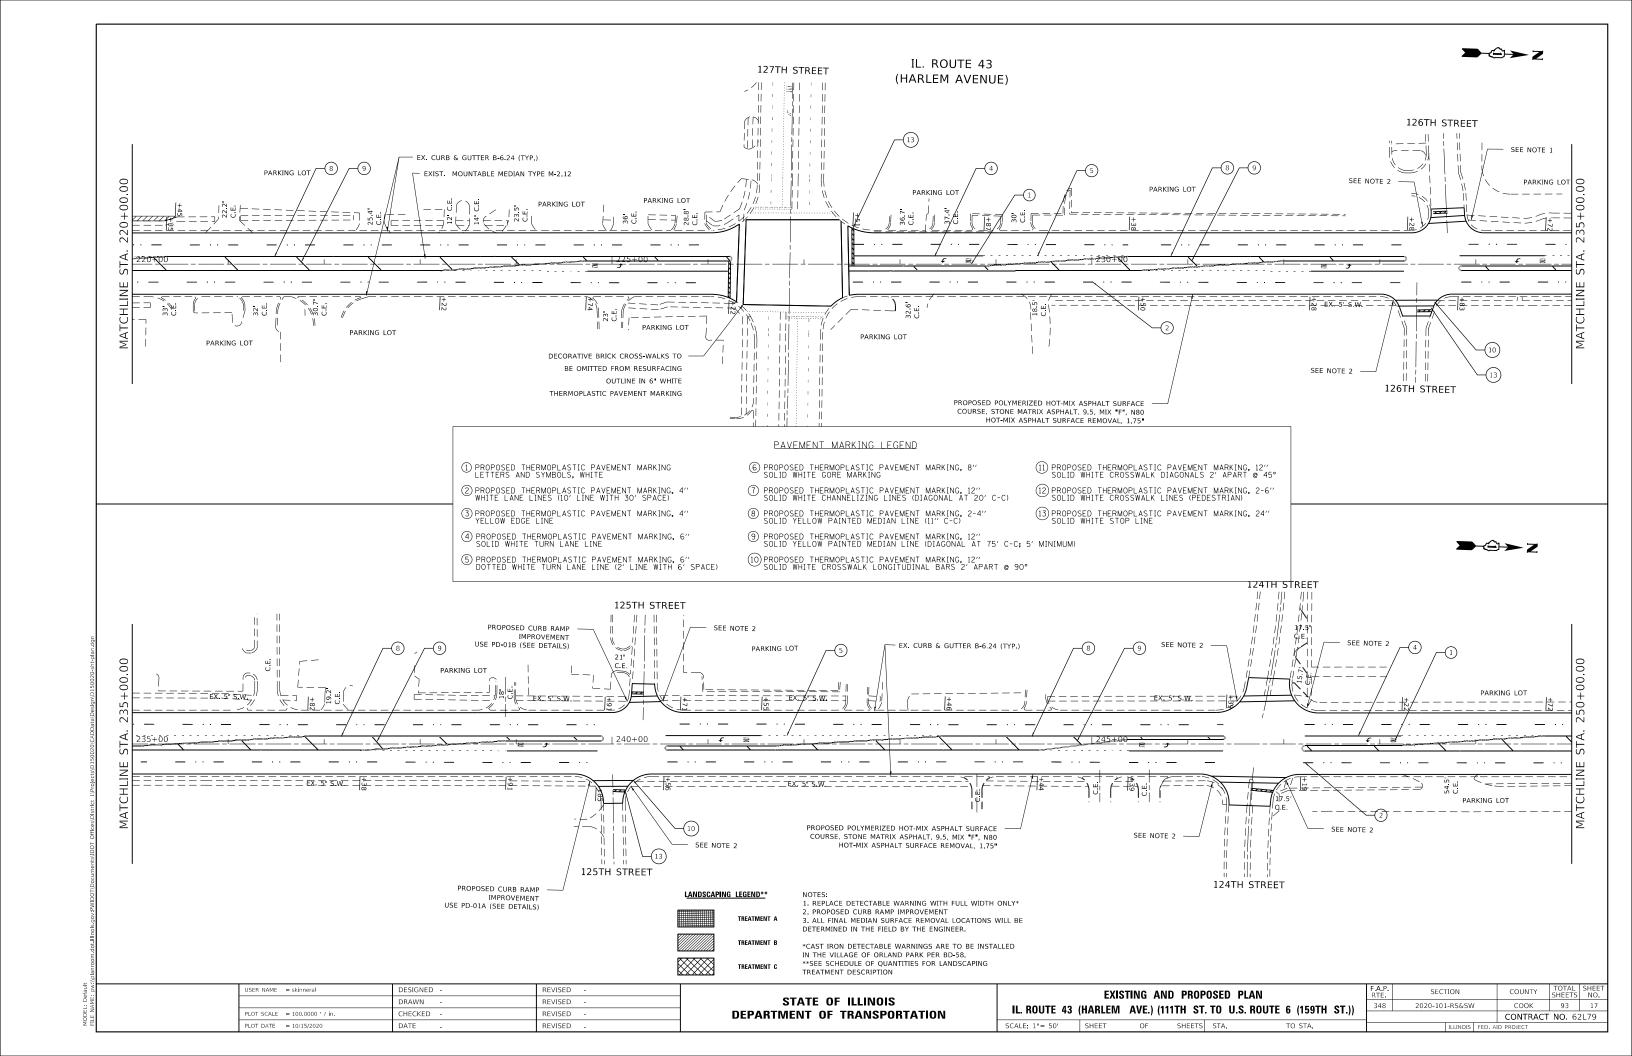

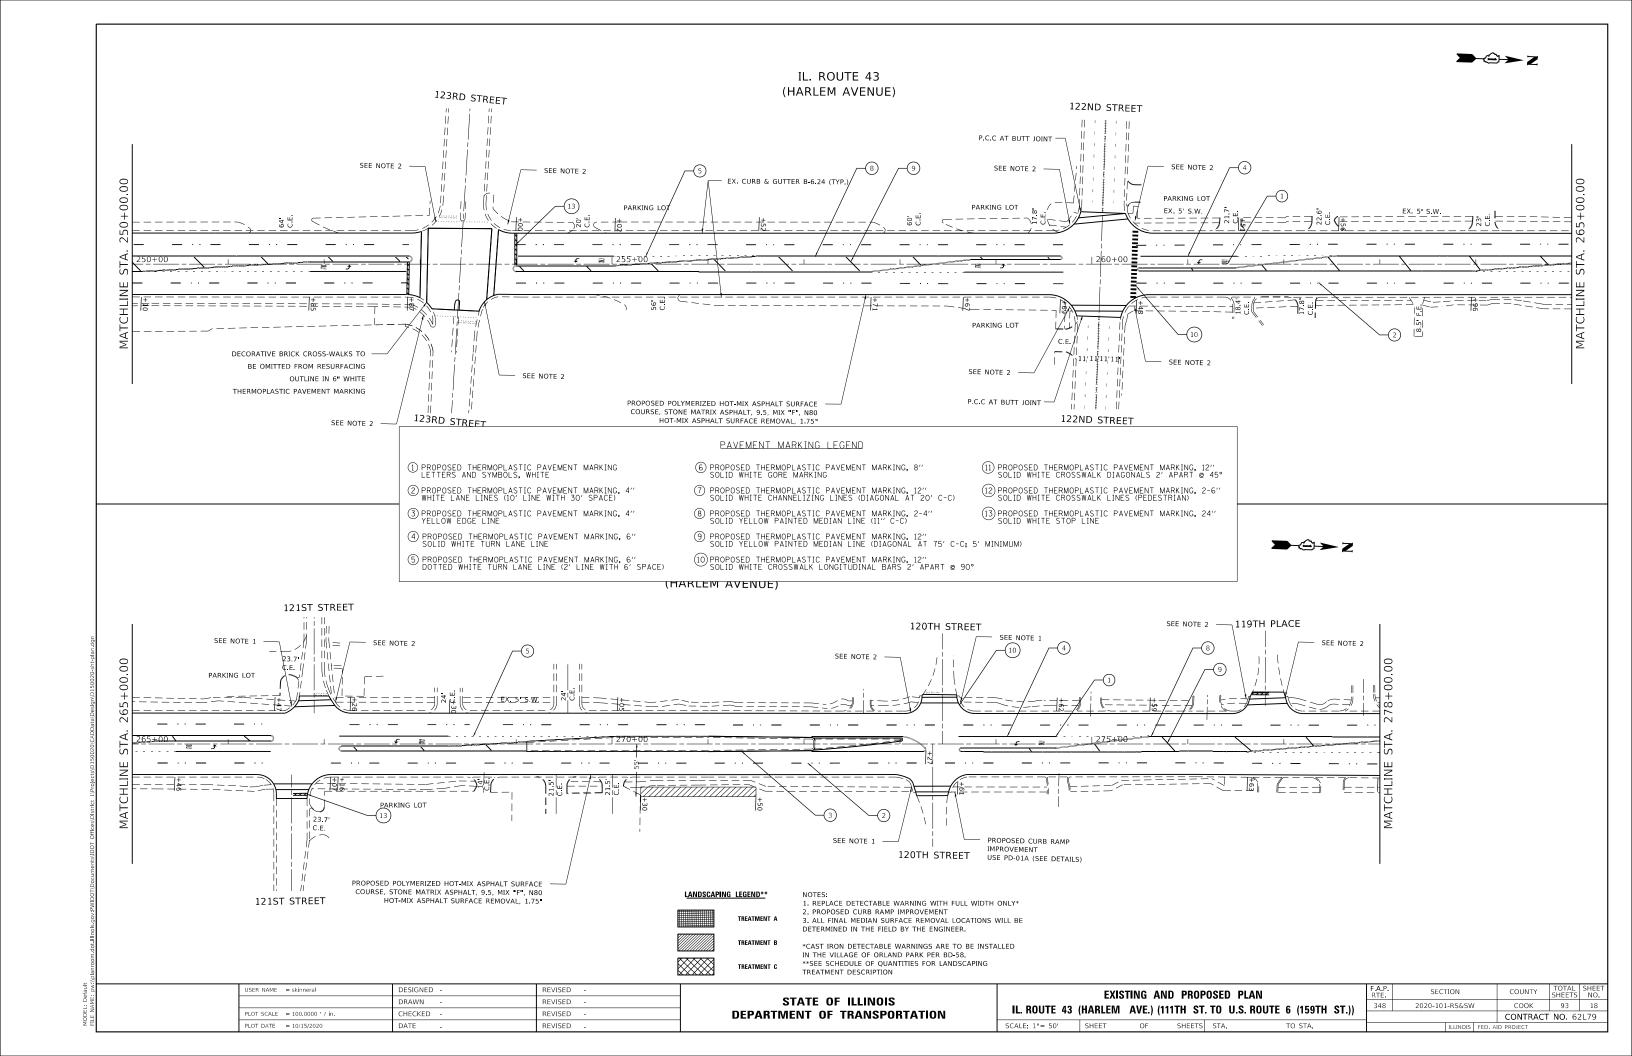

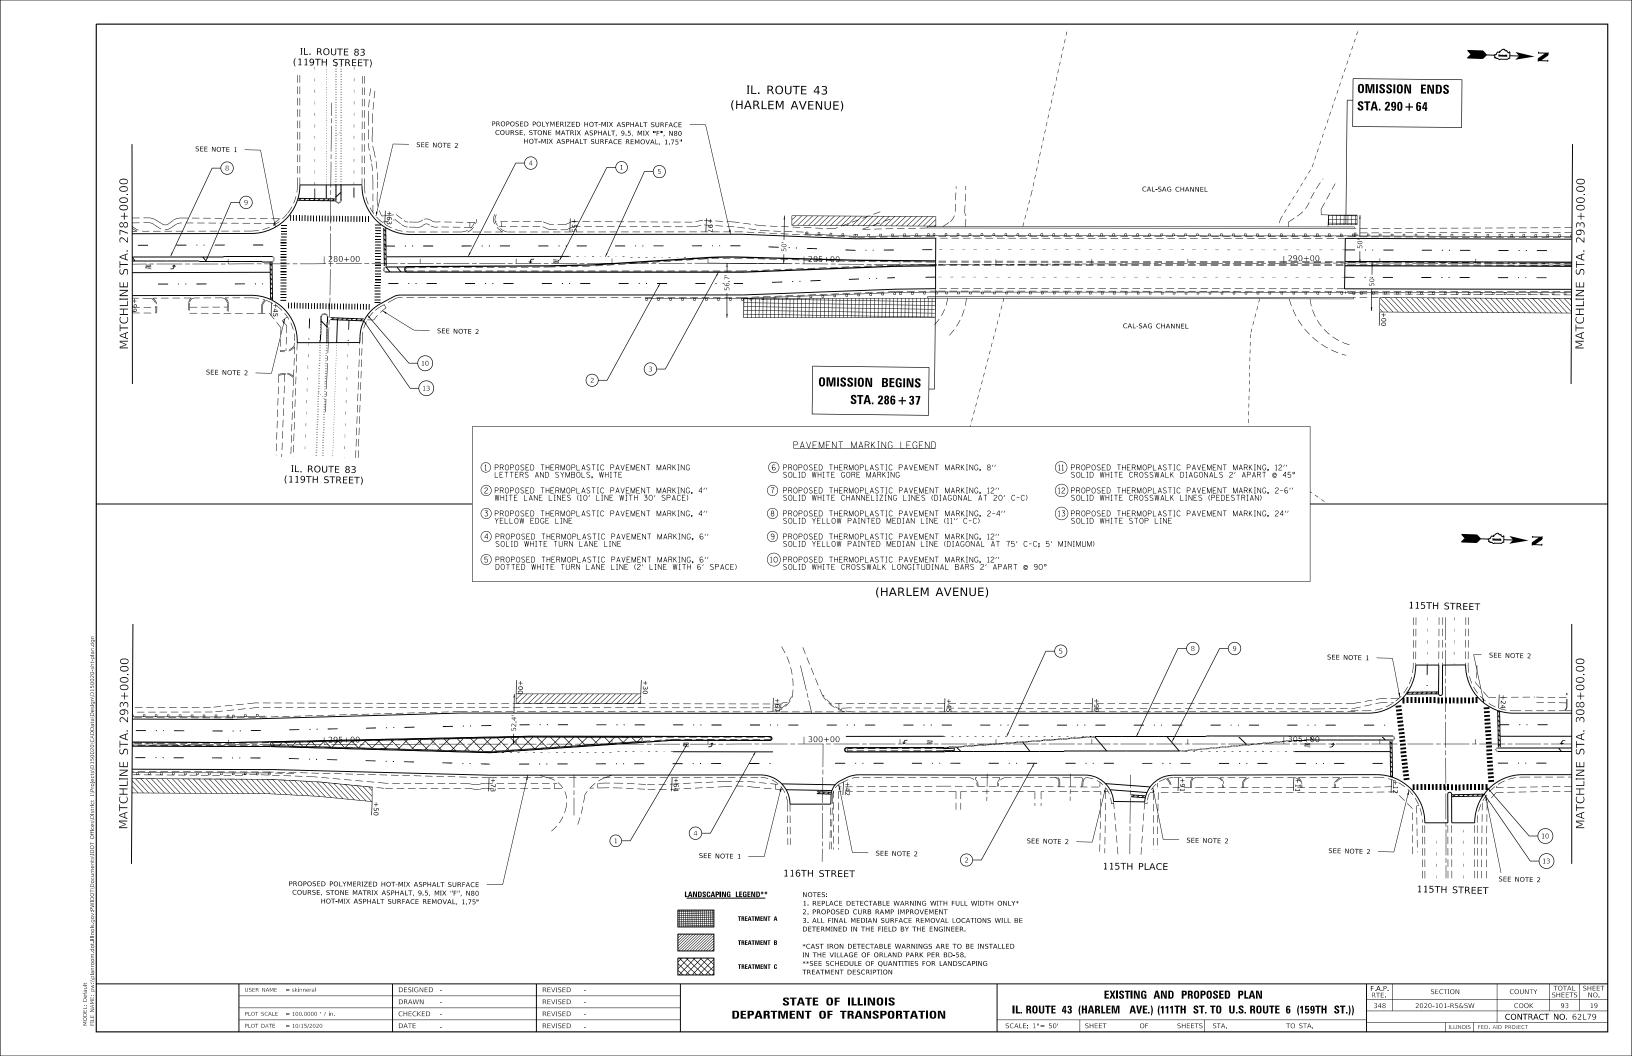

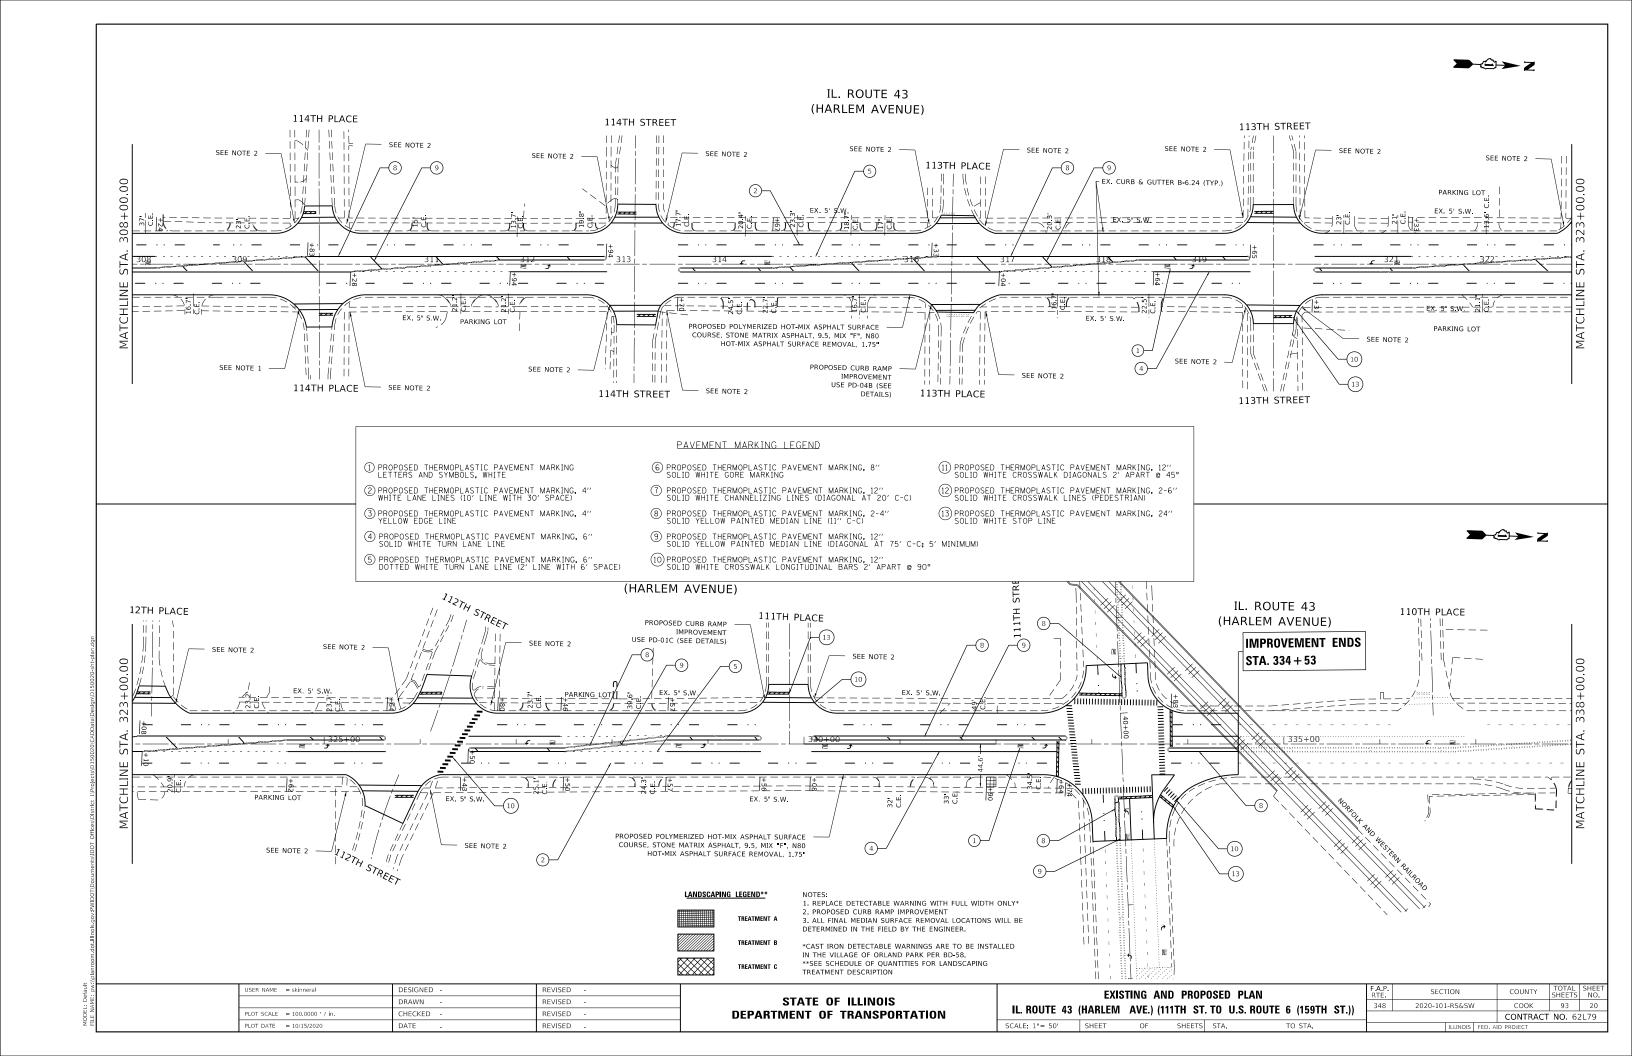

BENCHMARK: "X" ON SIDEWALK, NORTHERN: 1798750.43 EASTERN: 1131632.30 BAXTER WOODMAN Consulting Engineers

NOTE:

USER NAME = mornig DESIGNED - CJC REVISED -DRAWN - MJO REVISED -PLOT SCALE = 10.0000 ' / in. CHECKED - AKS REVISED -PLOT DATE = 10/9/2020 FILE - 140183_ADA Details_12.dgn DATE

STATE OF ILLINOIS **DEPARTMENT OF TRANSPORTATION**

ADA SIDEWALK DETAILS IL-43 (HARLEM AVE) FROM 111TH TO US 6 (159TH ST) SCALE: 1"=5' SHEET 12 OF 12 SHEETS STA.

COUNTY TOTAL SHEET NO.

COOK 93 21 SECTION 2020-101-RS&SW CONTRACT NO. 62L79

OUT ALONG THE LENGTH OF CURB. **LEGEND** PROPOSED SIDEWALK XX.XX' EXISTING LENGTH DETECTABLE WARNINGS PROPOSED SIDE CURB SIDEWALK REMOVAL EXISTING ELEVATION/SLOPE REPLACE W/ TOPSOIL & SOD

- CATCH BASINS TO BE ADJUSTED WITH NEW TYPE 1 FRAME, OPEN LID (ADA COMPLIANT)

— COMBINATION CURB & GUTTER REMOVAL AND REPLACEMENT, 16 FT

718.46

(718.72) (718.81)

ESTIMATED QUANTITIES FOR PAVEMENT PATCHING WAS CALCULATED AS 4 FT C
EFERENCE BENCHMARK ELEV 718.43 ENCHMARK: TOP OF THE EAST ANTENNA FLANGE BOLT OF FIRE HYDRANT OCATED AT SOUTHWEST CORNER OF 158th STREET & HARLEM AVENUE.

REFERENCE BENCHMARK ELEV 718.46

158TH STREET

- - 229 SF SIDEWALK REMOVAL 183 SF PCC SIDEWALK, 5"

CLASS D PATCHES, 10 INCH -7.5 SQ YD

(718.22) —

(718.38) -

(718.00) —

718.31

718.26

718.33

15' (718.41)


718.37

⊢ _{718.39} ج

718.61





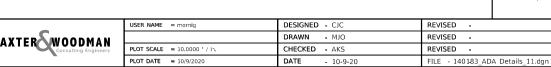

ESTIMATED QUANTITIES FOR PAVEMENT PATCHING WAS CALCULATED AS 4 FT OUT ALONG THE LENGTH OF CURB.

157TH STREET

BENCHMARK: TOP OF THE WEST ANTENNA FLANGE BOLT OF FIRE HYDRANT LOCATED AT

BENCHMARK: "X" ON SIDEWALK, NORTHERN: 1799524.74 EASTERN: 1131611.42

LEGEND

EXISTING LENGTH

PROPOSED SIDE CURB

EXISTING ELEVATION/SLOPE

DETECTABLE WARNINGS

PROPOSED SIDEWALK

REPLACE W/ TOPSOIL & SOD

BENCHMARK: TOP OF THE WEST ANTENNA FLANGE BOLT OF FIRE HYDRANT LOCATED AT SOUTHWEST CORNER OF 157th STREET & HARLEM AVENUE.

REFERENCE BENCHMARK ELEV 721.82

BENCHMARK: "X" ON SIDEWALK, NORTHERN: 1799379.66 EASTERN: 1131613.60

SIDEWALK REMOVAL

BAXTER WOODMAN

STATE OF ILLINOIS **DEPARTMENT OF TRANSPORTATION**

ADA SIDEWALK DETAILS SECTION COOK 93 22 2020-101-RS&SW IL-43 (HARLEM AVE) FROM 111TH TO US 6 (159TH ST) CONTRACT NO. 62L79 SCALE: 1"=5' SHEET 11 OF 12 SHEETS STA.

722.44 -VALVE BOXES 1/+ (722.52) TO BE ADJUSTED 722.09 -722.34 -722.09 722.01 FL 722.05 721.99 **—** 722.26 — 722.59 -CLASS D PATCHES, 1 11.5 SQ YD - 721.85 Fr 721.93 COMBINATION CURB & GUTTER REMOVAL AND REPLACEMENT, 26 FT

(723.20 (723.04) **-**722.86 268 SF SIDEWALK REMOVAL 268 SF PCC SIDEWALK, 5"

157TH STREET

COMBINATION CURB & GUTTER
REMOVAL AND REPLACEMENT, 30 FT (721.71)

- <u>(7</u>21.37) ¬







721.58

721.65 -- 722.63

721.59 721.61

SIDEWALK CURB -

160 SF SIDEWALK REMOVAL (721.86)\\ (721.74) —

196 SF PCC SIDEWALK, 5"

CLASS D PATCHES, 10 INCH

13.5 SQ YD


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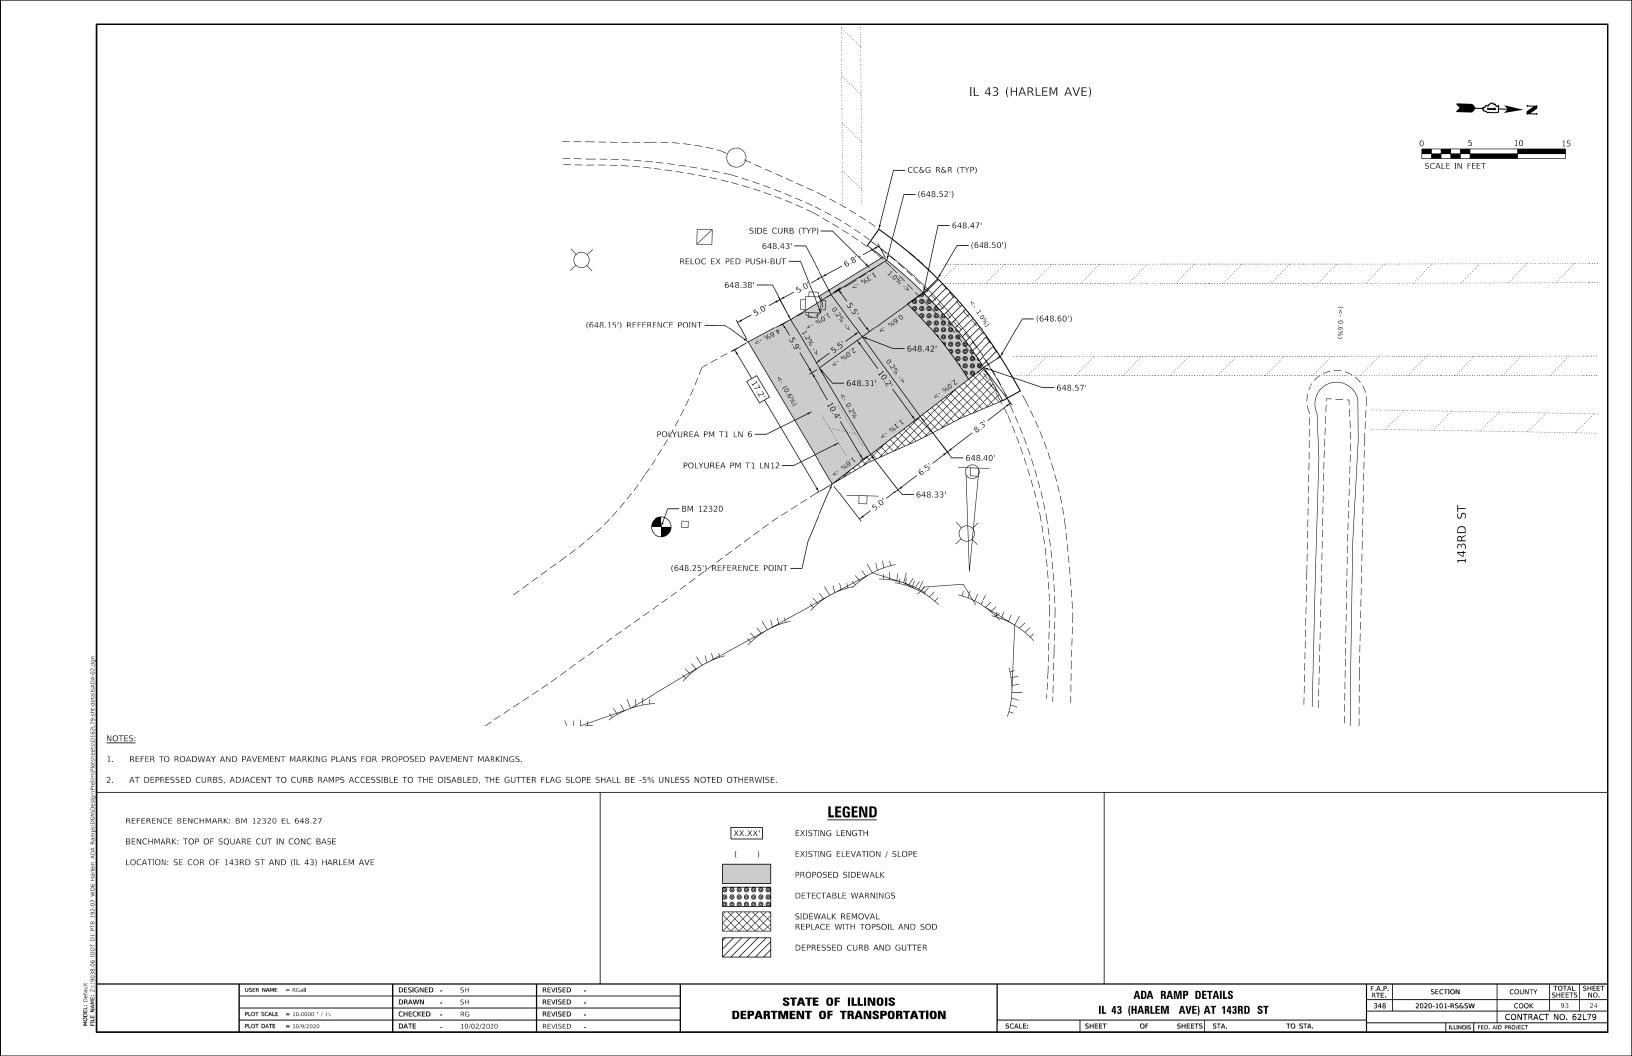
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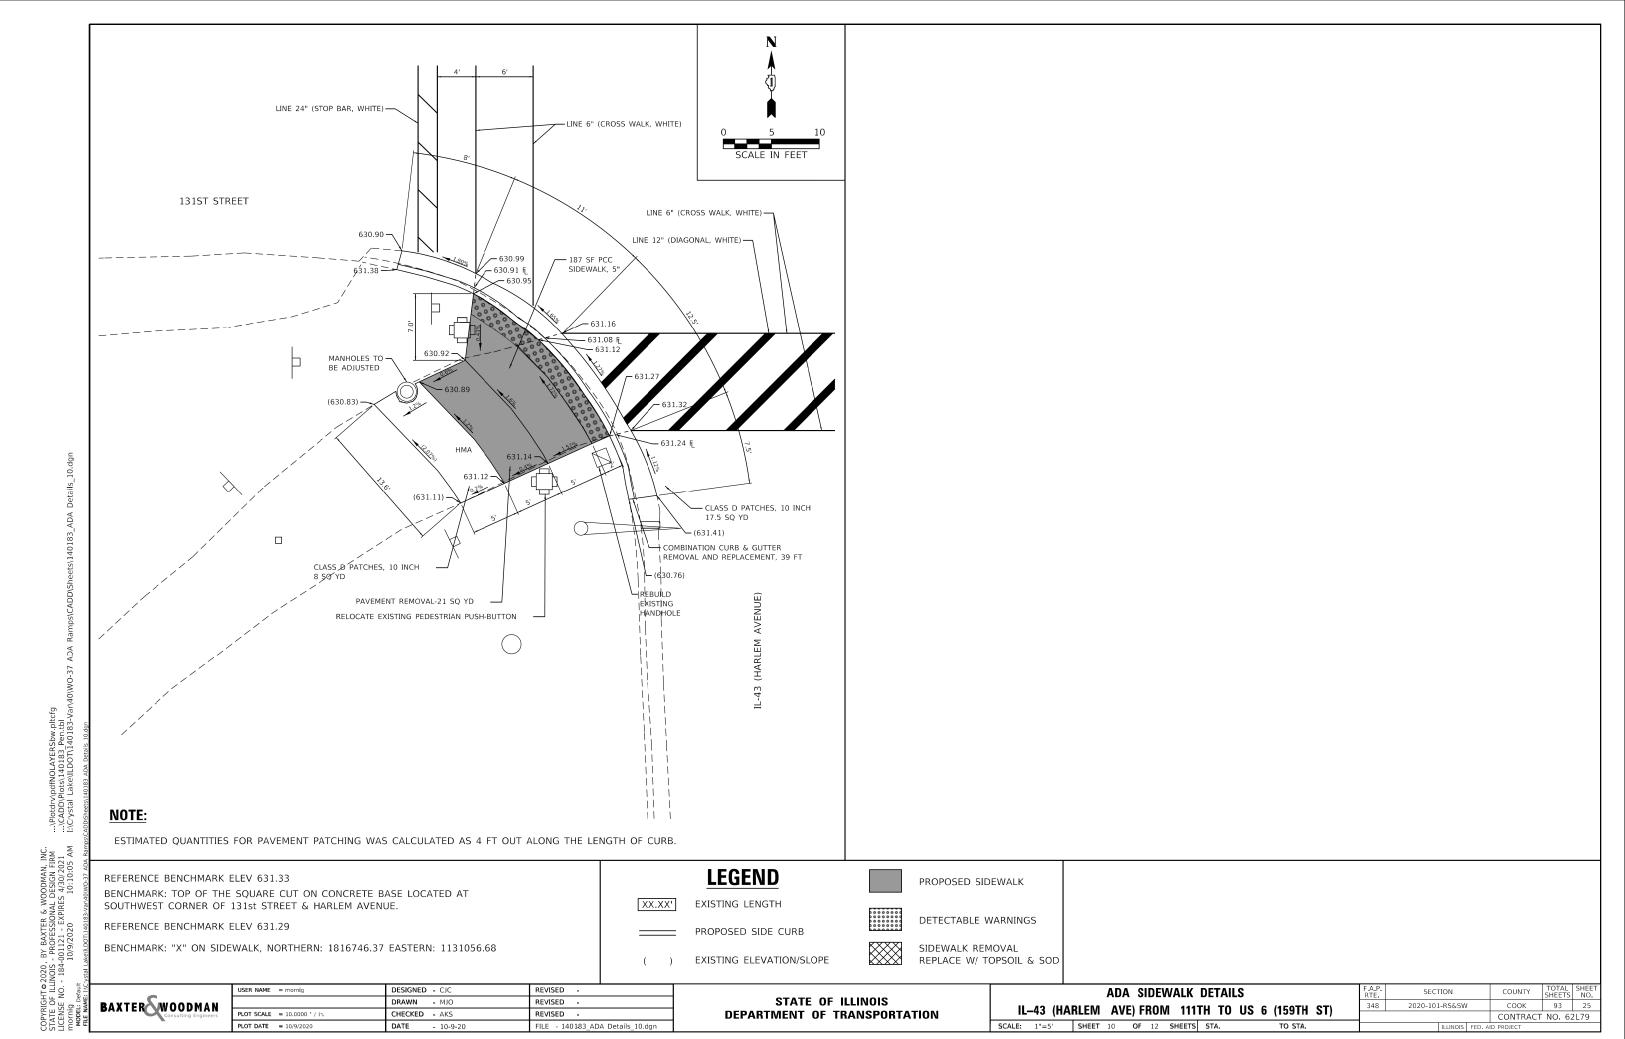
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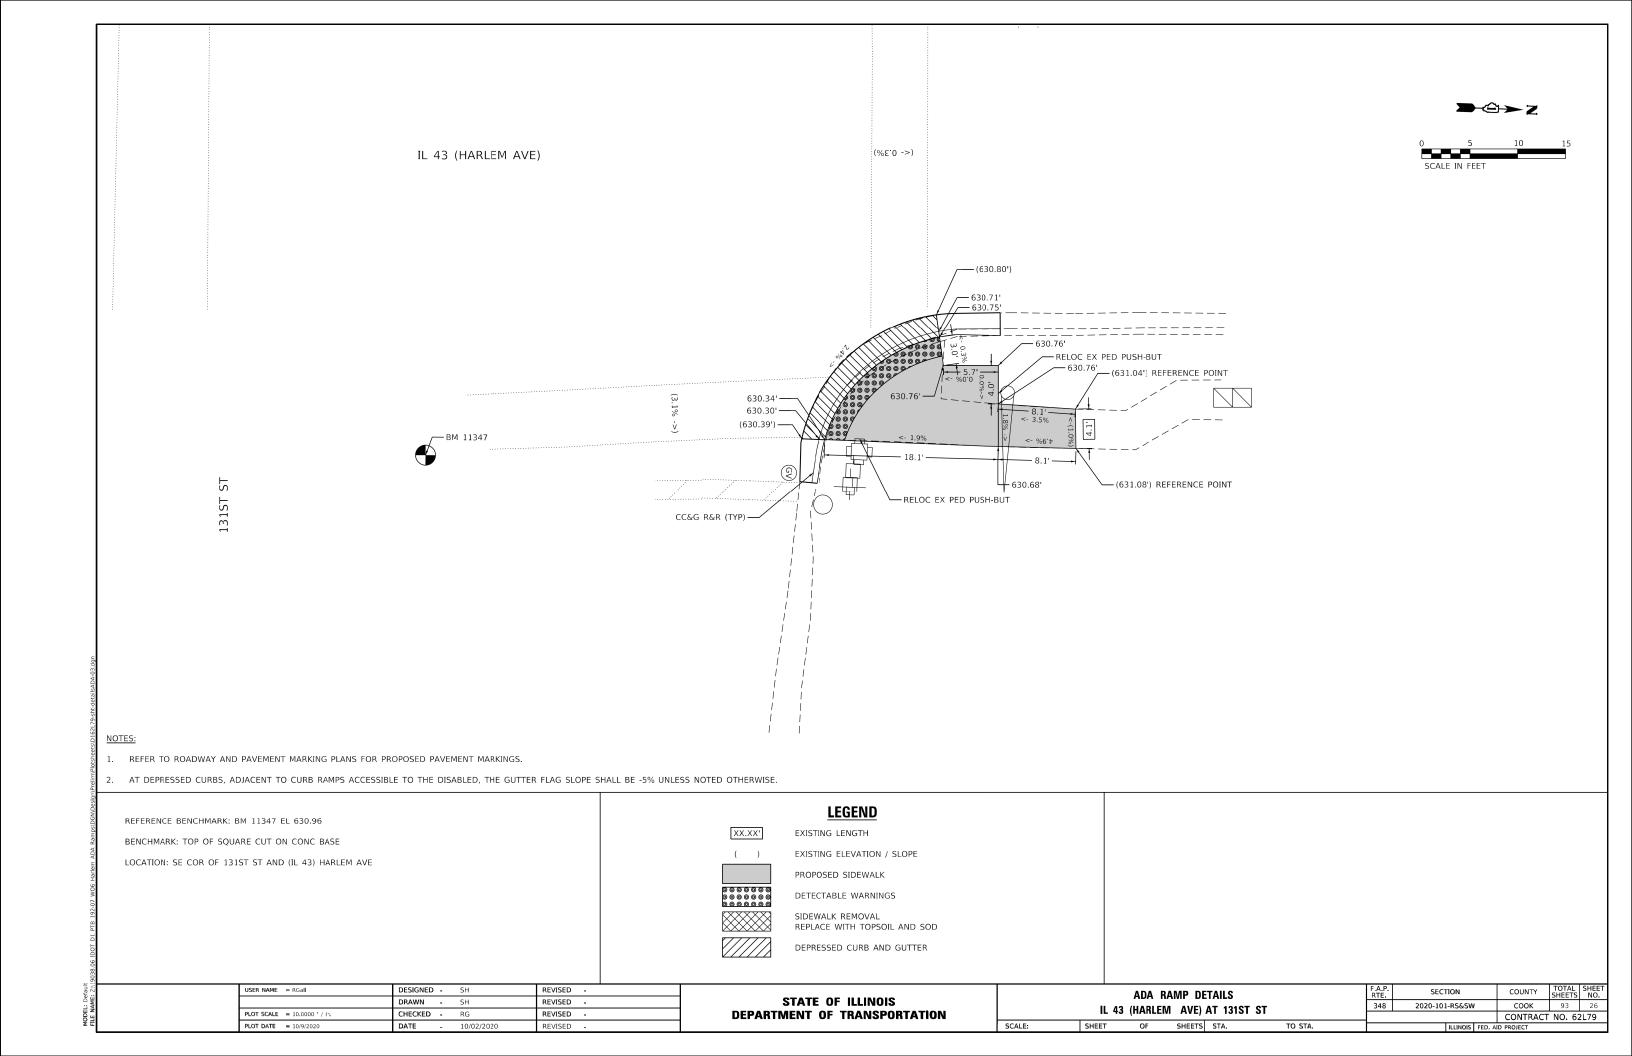
REFERENCE BENCHMARK ELEV 723.05

SOUTHWEST CORNER OF 157th STREET & HARLEM AVENUE.








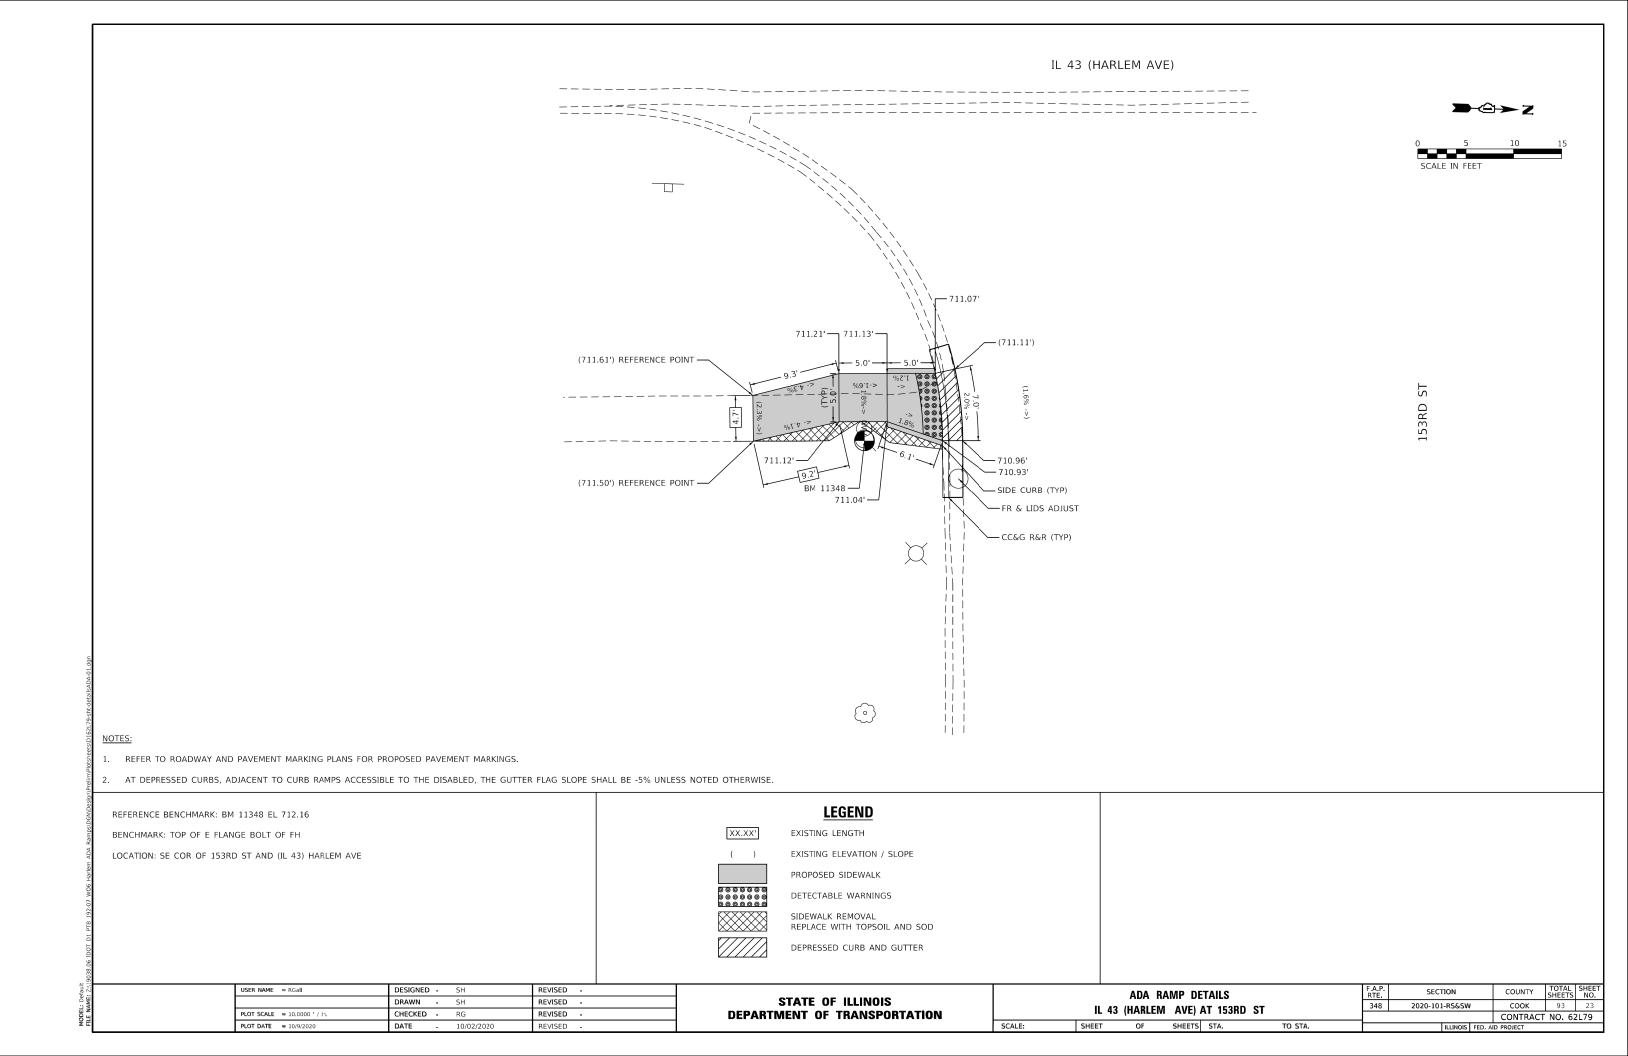



BAXTER WOODMAN Consulting Engineers

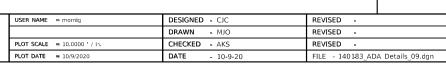



|| | || | || |

(624.17)

(623.70) - 623.57

– 623.70 F **(**623.78)

£ 623.70

IL-43 (HARLEM AVENUE)

FS

EXISTING LENGTH

XX.XX'

PROPOSED SIDE CURB EXISTING ELEVATION/SLOPE





DETECTABLE WARNINGS

SIDEWALK REMOVAL REPLACE W/ TOPSOIL & SOD

STATE	OF	ILLINOIS
DEPARTMENT	0F	TRANSPORTATION

ADA SIDEWALK DETAILS		SECTION	COUNTY	TOTAL SHEETS	0,
IL-43 (HARLEM AVE) FROM 111TH TO US 6 (159TH ST)	348	2020-101-RS&SW	соок	93	
IL-43 (MANLLIN AVE) INDIN 11111 10 03 0 (13311 31)			CONTRACT	NO. 62	21
SCALE: 1"=5' SHEET 9 OF 12 SHEETS STA. TO STA.		ILLINOIS FED. /	AID PROJECT		_

 \bigcirc <u> 623.66</u> 623.76 623.67 -COMBINATION CURB & GUTTER REMOVAL AND REPLACEMENT, 60 FT 623.85 - CATCH BASINS (622.49) -TO BE ADJUSTED (622.01) -623.74 FL — **-** 623.87 CLASS D PATCHES, 10 INCH -623.79 - 27 SQ YD W. ISHNALA DRIVE

NOTE:


ESTIMATED QUANTITIES FOR PAVEMENT PATCHING WAS CALCULATED AS 4 FT OUT ALONG THE LENGTH OF CURB.


238 SF SIDEWALK REMOVAL -260 SF PCC SIDEWALK, 5"

(·)

REFERENCE BENCHMARK ELEV 623.90 BENCHMARK: TOP OF THE SQUARE CUT ON CONCRETE BASE LOCATED AT SOUTHWEST CORNER OF W. ISHNALA DRIVE & HARLEM AVENUE.

REFERENCE BENCHMARK ELEV 624.02 BENCHMARK: "X" ON SIDEWALK, NORTHERN: 1818478.78 EASTERN: 1130994.75

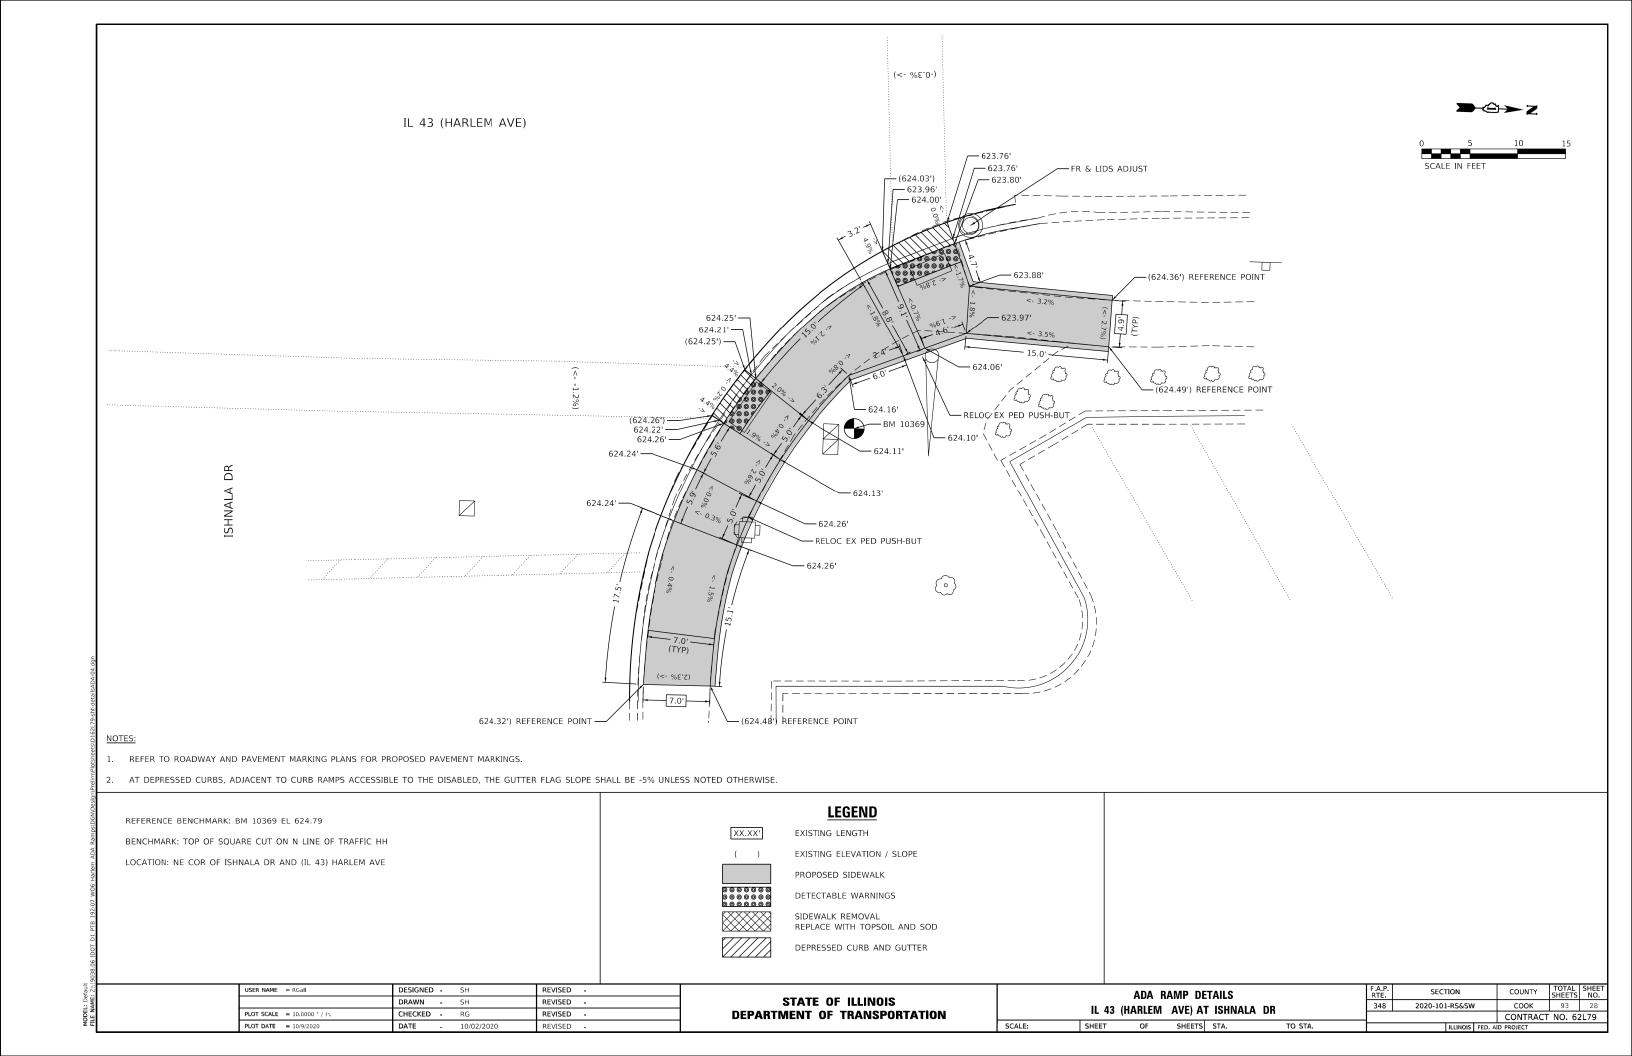

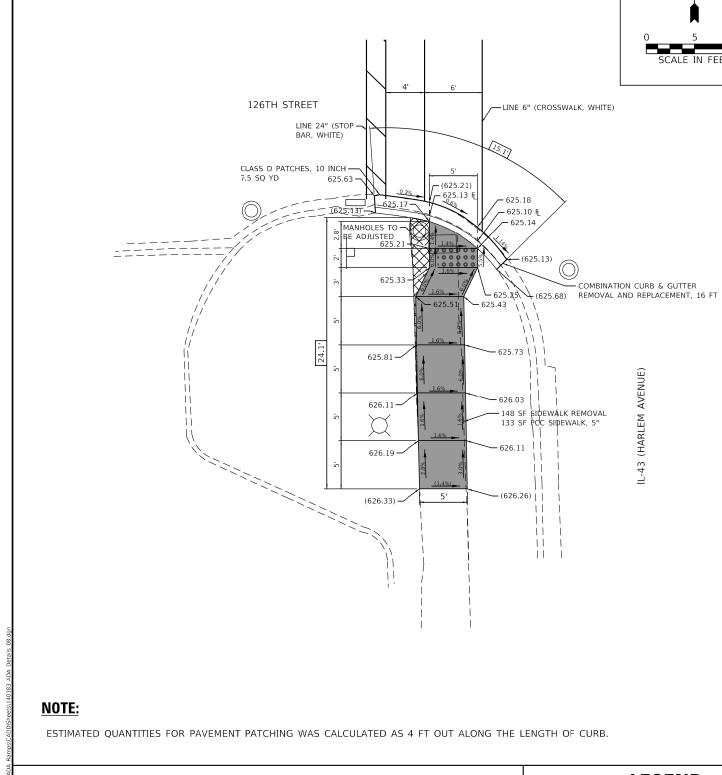

REFERENCE BENCHMARK ELEV 625.52

BENCHMARK: TOP OF THE EAST ANTENNA FLANGE BOLT OF FIRE HYDRANT LOCATED AT SOUTHWEST CORNER OF 126th STREET & HARLEM AVENUE.

REFERENCE BENCHMARK ELEV 626.28

BENCHMARK: "X" ON SIDEWALK, NORTHERN: 1820061.61 EASTERN: 1130928.36

LEGEND

EXISTING LENGTH



EXISTING ELEVATION/SLOPE

PROPOSED SIDEWALK



DETECTABLE WARNINGS

SIDEWALK REMOVAL REPLACE W/ TOPSOIL & SOD

BAXTER WOODMAN Consulting Engineers

USER NAME = mornig	DESIGNED - CJC	REVISED -
	DRAWN - MJO	REVISED -
PLOT SCALE = 10.0000 ' / in.	CHECKED - AKS	REVISED -
PLOT DATE = 10/9/2020	DATE - 10-9-20	FILE - 140183_ADA Details_08.dgn


STATE OF ILLINOIS **DEPARTMENT OF TRANSPORTATION**

	ADA SIDEWALK DETAILS	F.A.P. RTE	SECTION
II_/13 /HAR	LEM AVE) FROM 111TH TO US 6 (159TH ST)	348	2020-101-RS&SW
IL-43 (IIAII	· · · · · · · · · · · · · · · · · · ·		
SCALE: 1"=5'	SHEET 8 OF 12 SHEETS STA. TO STA.		ILLINOIS

COUNTY TOTAL SHEETS NO.
COOK 93 29

CONTRACT NO. 62L79

IL 43 (HARLEM AVE)

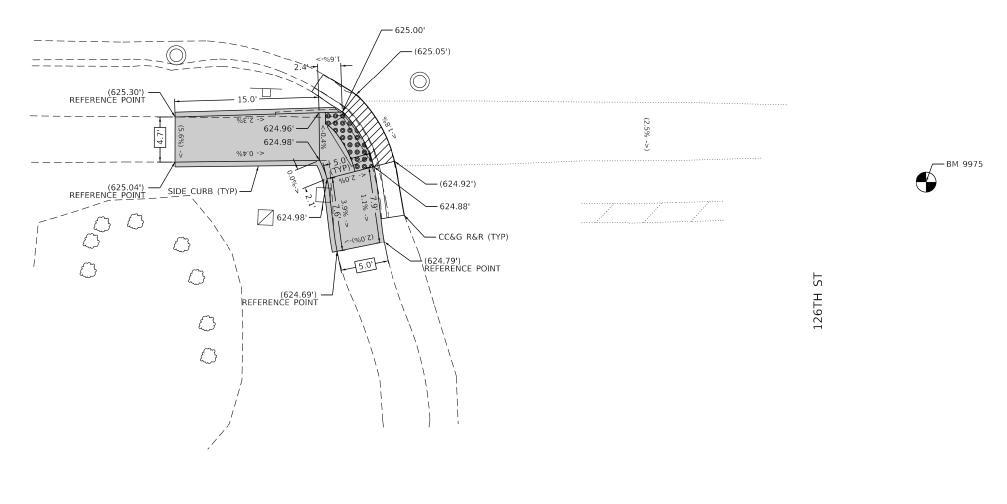

NOTES:

- 1. REFER TO ROADWAY AND PAVEMENT MARKING PLANS FOR PROPOSED PAVEMENT MARKINGS.
- 2. AT DEPRESSED CURBS, ADJACENT TO CURB RAMPS ACCESSIBLE TO THE DISABLED, THE GUTTER FLAG SLOPE SHALL BE -5% UNLESS NOTED OTHERWISE.

REFERENCE BENCHMARK: BM 9975 EL 625.52

BENCHMARK: TOP OF E ANTENNA FLANGE BOLT OF FH

LOCATION: NE COR OF 126TH ST AND (IL 43) HARLEM AVE

CONTROL OF 126TH ST AND (IL 43) HARLEM AVE

LOCATION: NE COR OF 126TH ST AND (IL 43) HARLEM AVE

CONTROL OF 126TH ST AND (IL 43) HARLEM AVE

CONTROL OF 126TH ST AND (IL 43) HARLEM AVE

CONTROL OF 126TH ST AND (IL 43) HARLEM AVE

CONTROL OF 126TH ST AND (IL 43) HARLEM AVE

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CONTROL OF 126TH ST AND (IL 43) HARLEM AVE

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CONTROL OF 126TH ST AND (IL 43) HARLEM AVE

CONTR


USER NAME = RGall	DESIGNED	-	SH	REVISED	-
	DRAWN	-	SH	REVISED	-
PLOT SCALE = 10.0000 ' / in.	CHECKED	-	RG	REVISED	-
PLOT DATE = 10/9/2020	DATE	_	10/02/2020	REVISED	-

STATE 0	F ILLINOIS
DEPARTMENT OF	TRANSPORTATION

IL 43 (HARLEM AVE) AT 126TH ST 348 2020-101-RS&SW COOK 93 30	ADA RAMP DETAII	F.A.P. RTE	SECTION	COUNTY	TOTAL SHEETS			
CONTRACT NO. 62L79	II 43 /HARIEM AVE\ AT 1	348	2020-101-RS&SW	соок	93	30		
SCALE: SHEET OF SHEETS STA. TO STA. JILLINGIS LEED, AID PROJECT	IL 43 (HARLEW AVE) AT			CONTRACT	NO. 62	2L79		
TEATTON TEATTON	SCALE: SHEET OF SHEETS STA	TO STA.	ILLINOIS FED. AID PROJECT					





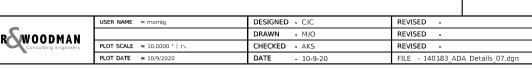



EXISTING LENGTH

PROPOSED SIDE CURB

EXISTING ELEVATION/SLOPE

PROPOSED SIDEWALK

DETECTABLE WARNINGS

SIDEWALK REMOVAL REPLACE W/ TOPSOIL & SOD

STATE OF ILLINOIS

				ADA	SID	EW	/ALK	DE.	TAIL	.S				
IL-	-43	(HA	RLEM	AVE)	FR	0M	111	TH	T0	US	6	(159TH	ST)	
CALE	1.11	E1	CHEET	7 /	OF 1	2	CHEETC	CT/	۸.			TO CTA		

F.A.P. RTE	SECT	ΠΟN	COUNTY	TOTAL SHEETS	SHEET NO.		
348	2020-101	1	СООК	31			
			CONTRACT NO. 62L79				
		ILLINOIS	FED. A	ID PROJECT			

- 133 SF SIDEWALK REMOVAL 133 SF POC/ SIDEWALK, 5"

(627.44)

CLASS D PATCHES, 10 INCH 7 SQ YD

- MANHOLES TO / BE ADJUSTED //

- 627.63 - 627.53

627.45 627.41 FL

(628.43) -

628.19 **-**

628.11

627.91-

627.52 —

DEPARTMENT OF TRANSPORTATION

125TH STREET NOTE:

COMBINATION CURB & GUTTER REMOVAL-AND REPLACEMENT, 16 FT -

ESTIMATED QUANTITIES FOR PAVEMENT PATCHING WAS CALCULATED AS 4 FT OUT ALONG THE LENGTH OF CURB.

REFERENCE BENCHMARK ELEV 628.67

BENCHMARK: TOP OF THE WEST ANTENNA FLANGE BOLT OF FIRE HYDRANT LOCATED AT SOUTHWEST CORNER OF 125th STREET & HARLEM AVENUE.

REFERENCE BENCHMARK ELEV 628.22

BENCHMARK: "X" ON SIDEWALK, NORTHERN: 1820800.88 EASTERN: 1130899.45

BAXTER WOODMAN Consulting Engineers

USER NAME = RGall DESIGNED - SH REVISED -DRAWN - SH REVISED -PLOT SCALE = 10.0000 ' / in. CHECKED - RG REVISED -PLOT DATE = 10/9/2020

STATE OF ILLINOIS **DEPARTMENT OF TRANSPORTATION**

ADA RAMP DETAILS IL 43 (HARLEM AVE) AT 125TH ST SHEET OF SHEETS STA.

SCALE:

348

TO STA.

COUNTY TOTAL SHEET NO.

COOK 93 32 SECTION 2020-101-RS&SW CONTRACT NO. 62L79

REFERENCE BENCHMARK: BM 9653 EL 627.96 BENCHMARK: TOP OF E ANTENNA FLANGE BOLT OF FH LOCATION: NE COR OF 125TH ST AND (IL 43) HARLEM AVE


LEGEND XX.XX' EXISTING LENGTH EXISTING ELEVATION / SLOPE PROPOSED SIDEWALK 0000000 DETECTABLE WARNINGS SIDEWALK REMOVAL REPLACE WITH TOPSOIL AND SOD DEPRESSED CURB AND GUTTER


2. AT DEPRESSED CURBS, ADJACENT TO CURB RAMPS ACCESSIBLE TO THE DISABLED, THE GUTTER FLAG SLOPE SHALL BE -5% UNLESS NOTED OTHERWISE.


1. REFER TO ROADWAY AND PAVEMENT MARKING PLANS FOR PROPOSED PAVEMENT MARKINGS.


IL 43 (HARLEM AVE)


626.95' 626.91 626.99'--(627.55') REFEENCE POINT 626.64' ÿ FR & LIDS ADJUST -<- %9.£ 626.72'-626.76' --- — (627.39') REFERENCE POINT - SIDE CURB (TYP) VALVE BOX ADJ-BM 9653-CC&G R&R (TYP) -(625.63') -(625.66') — (626.11') —

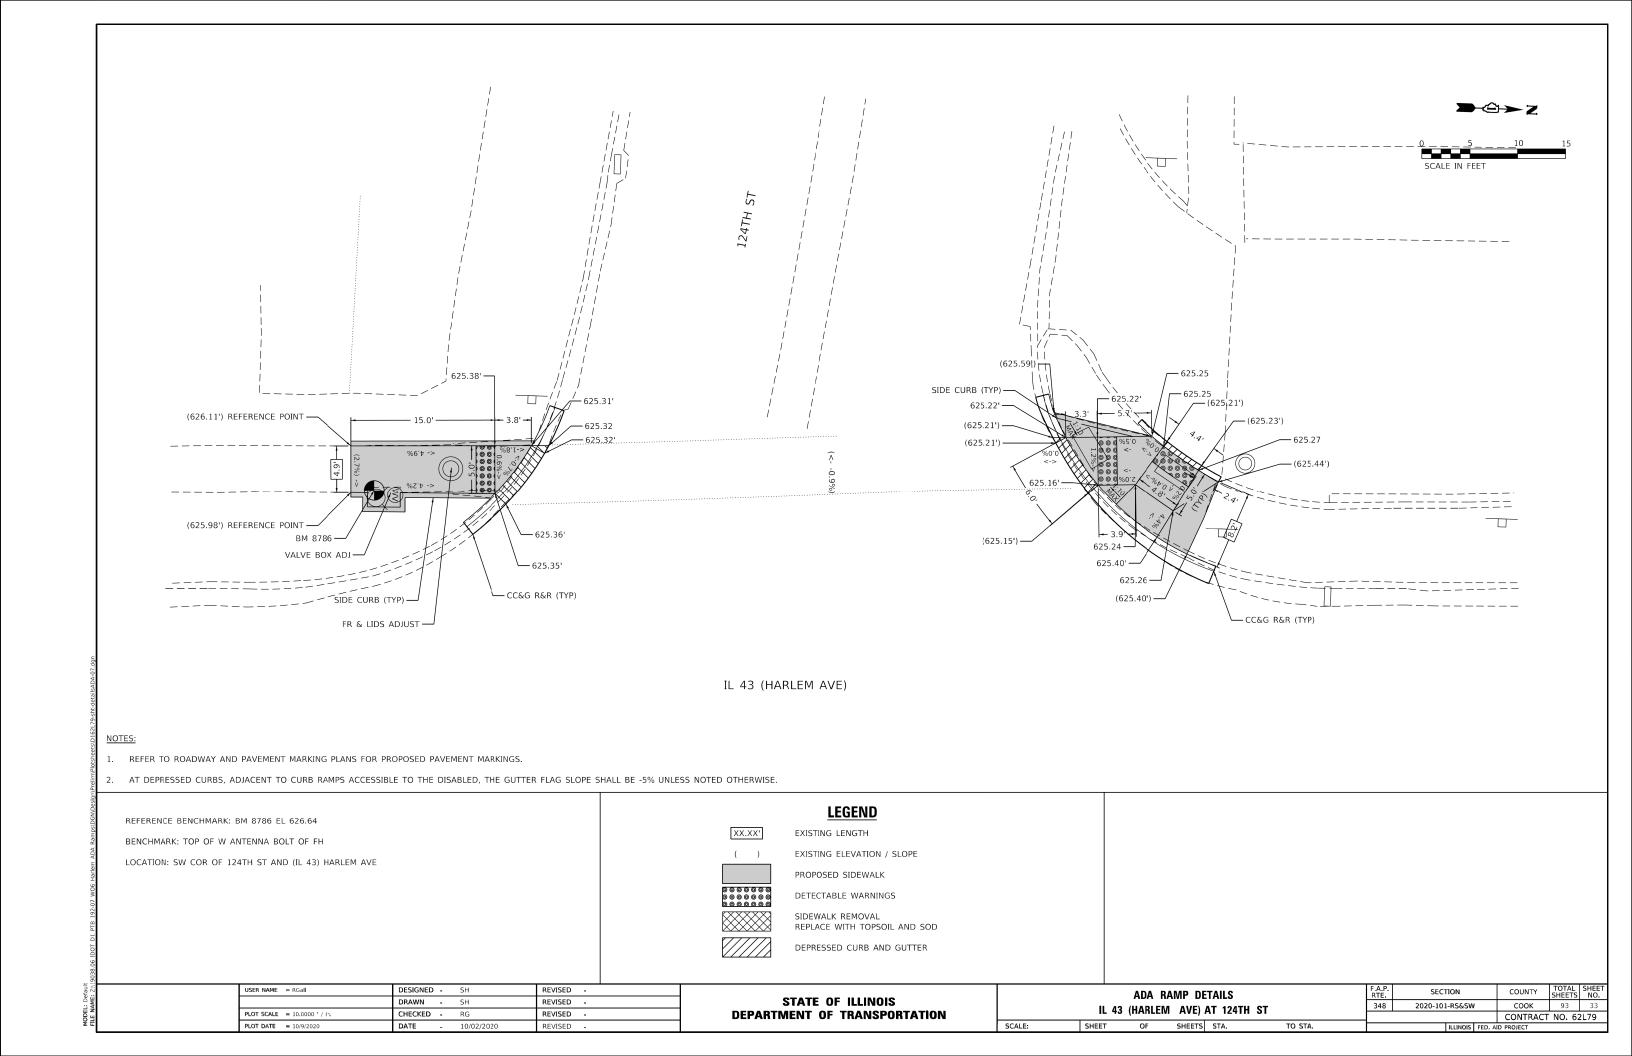

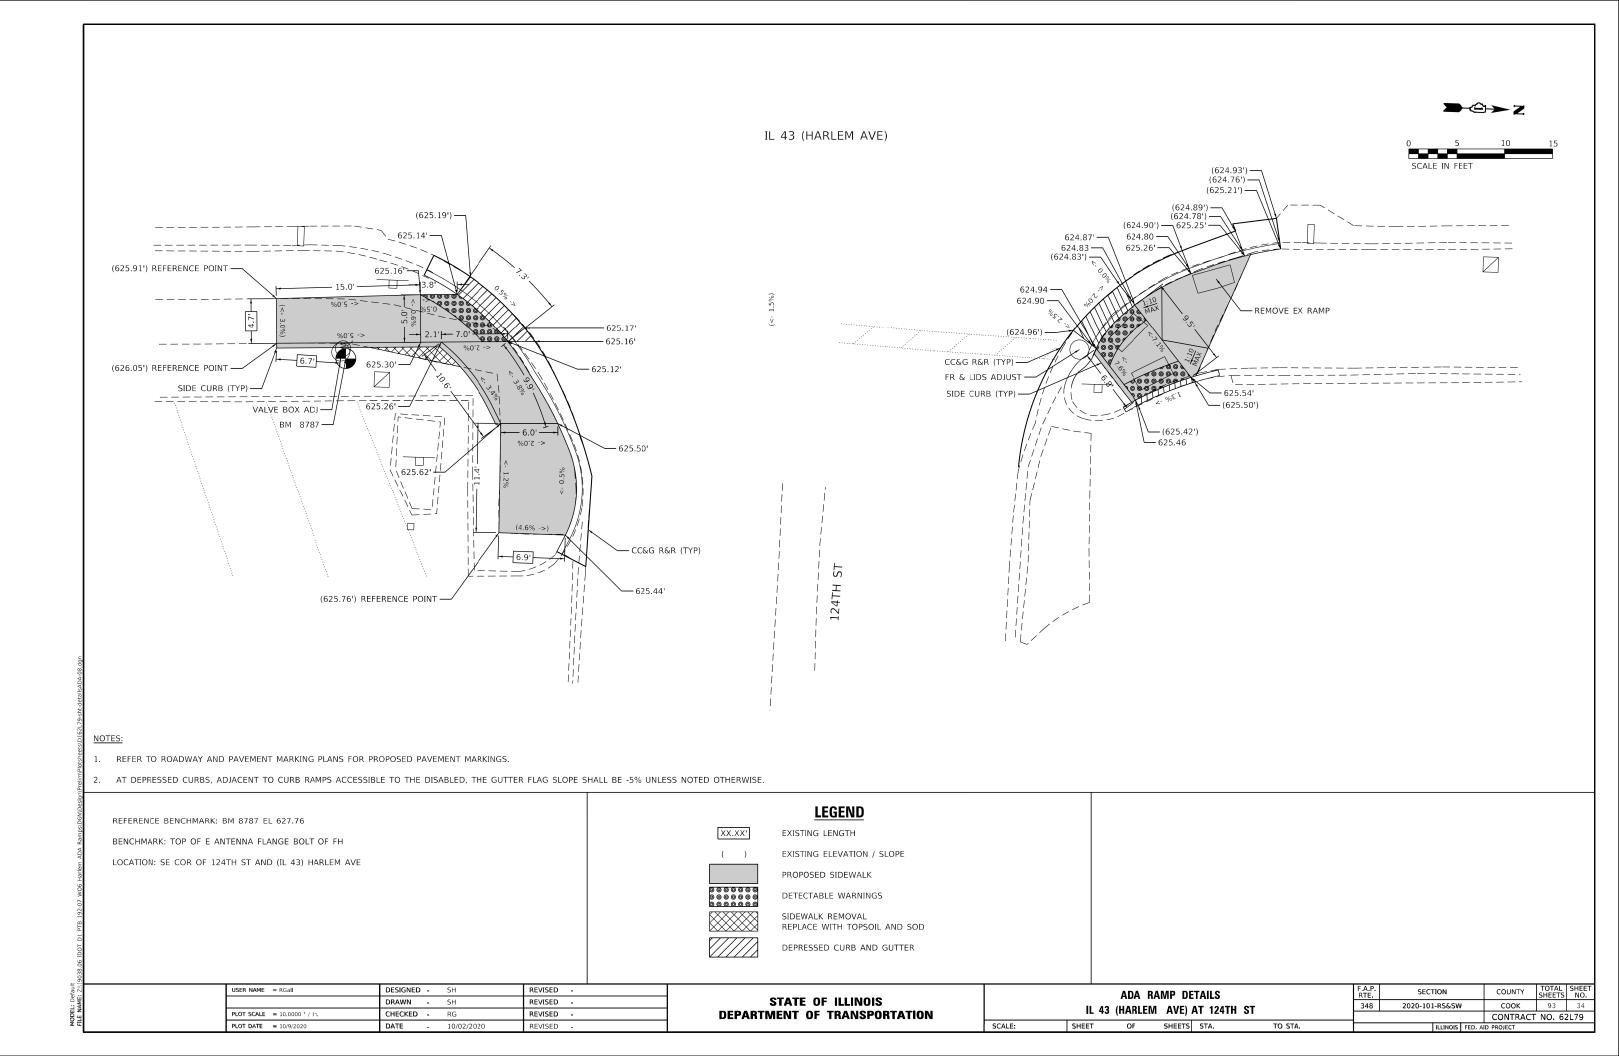

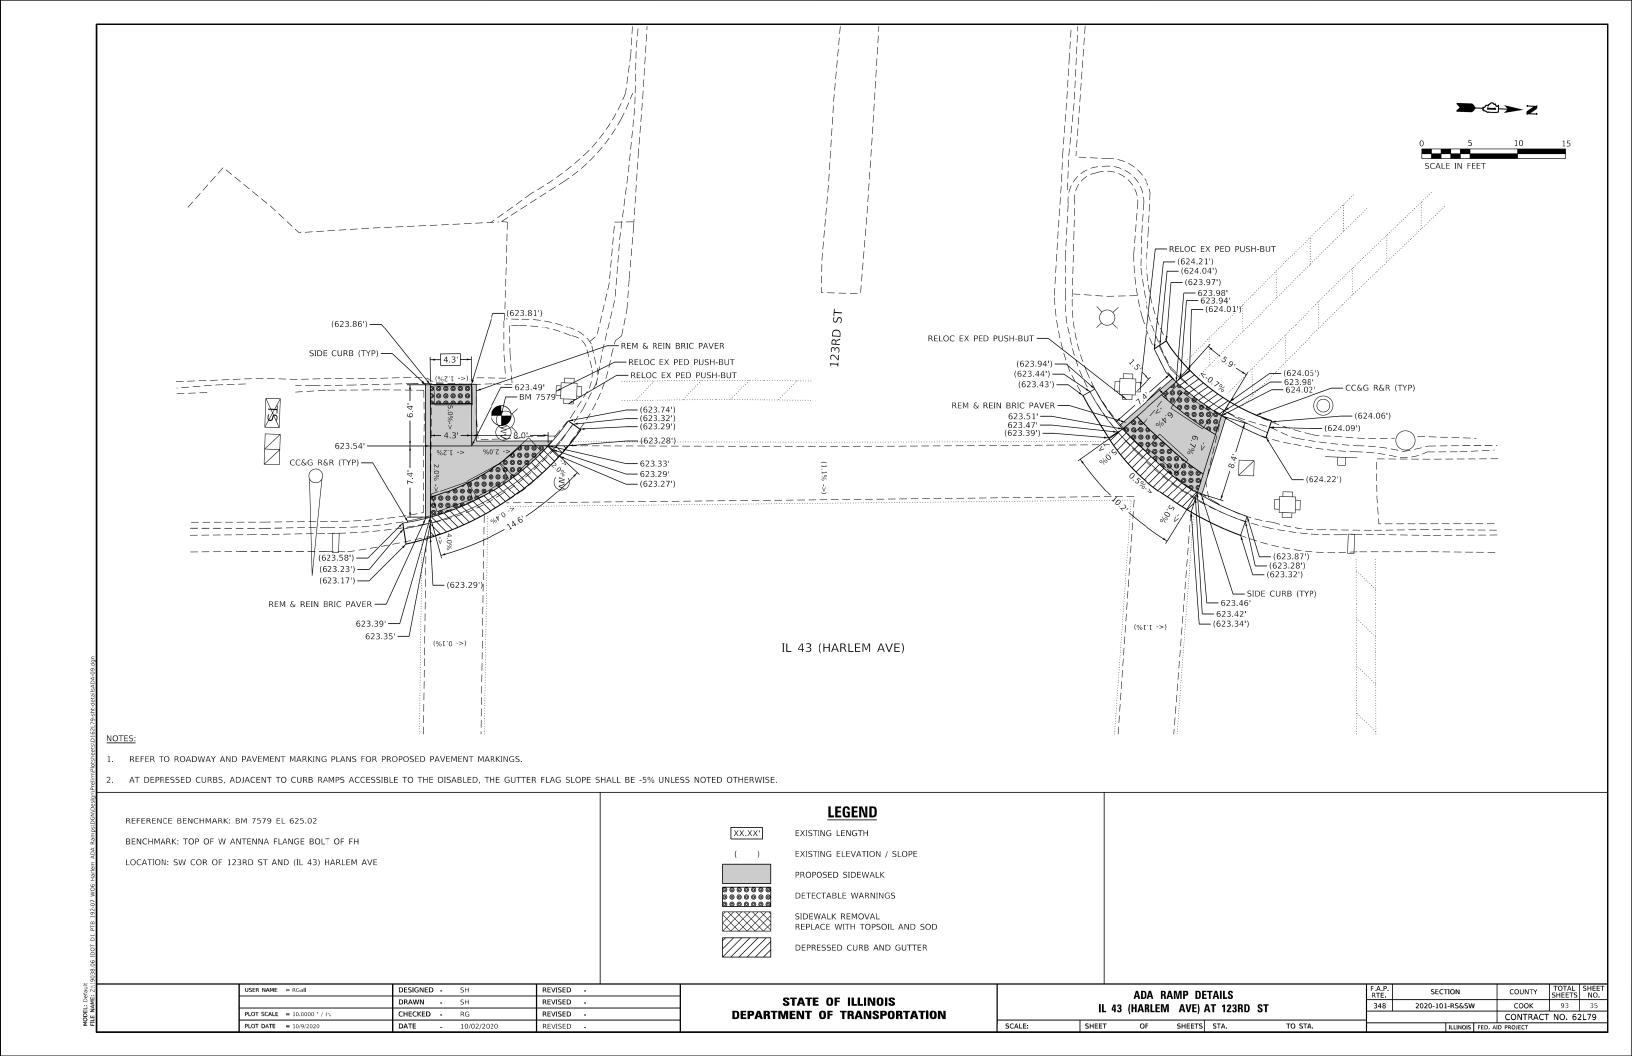


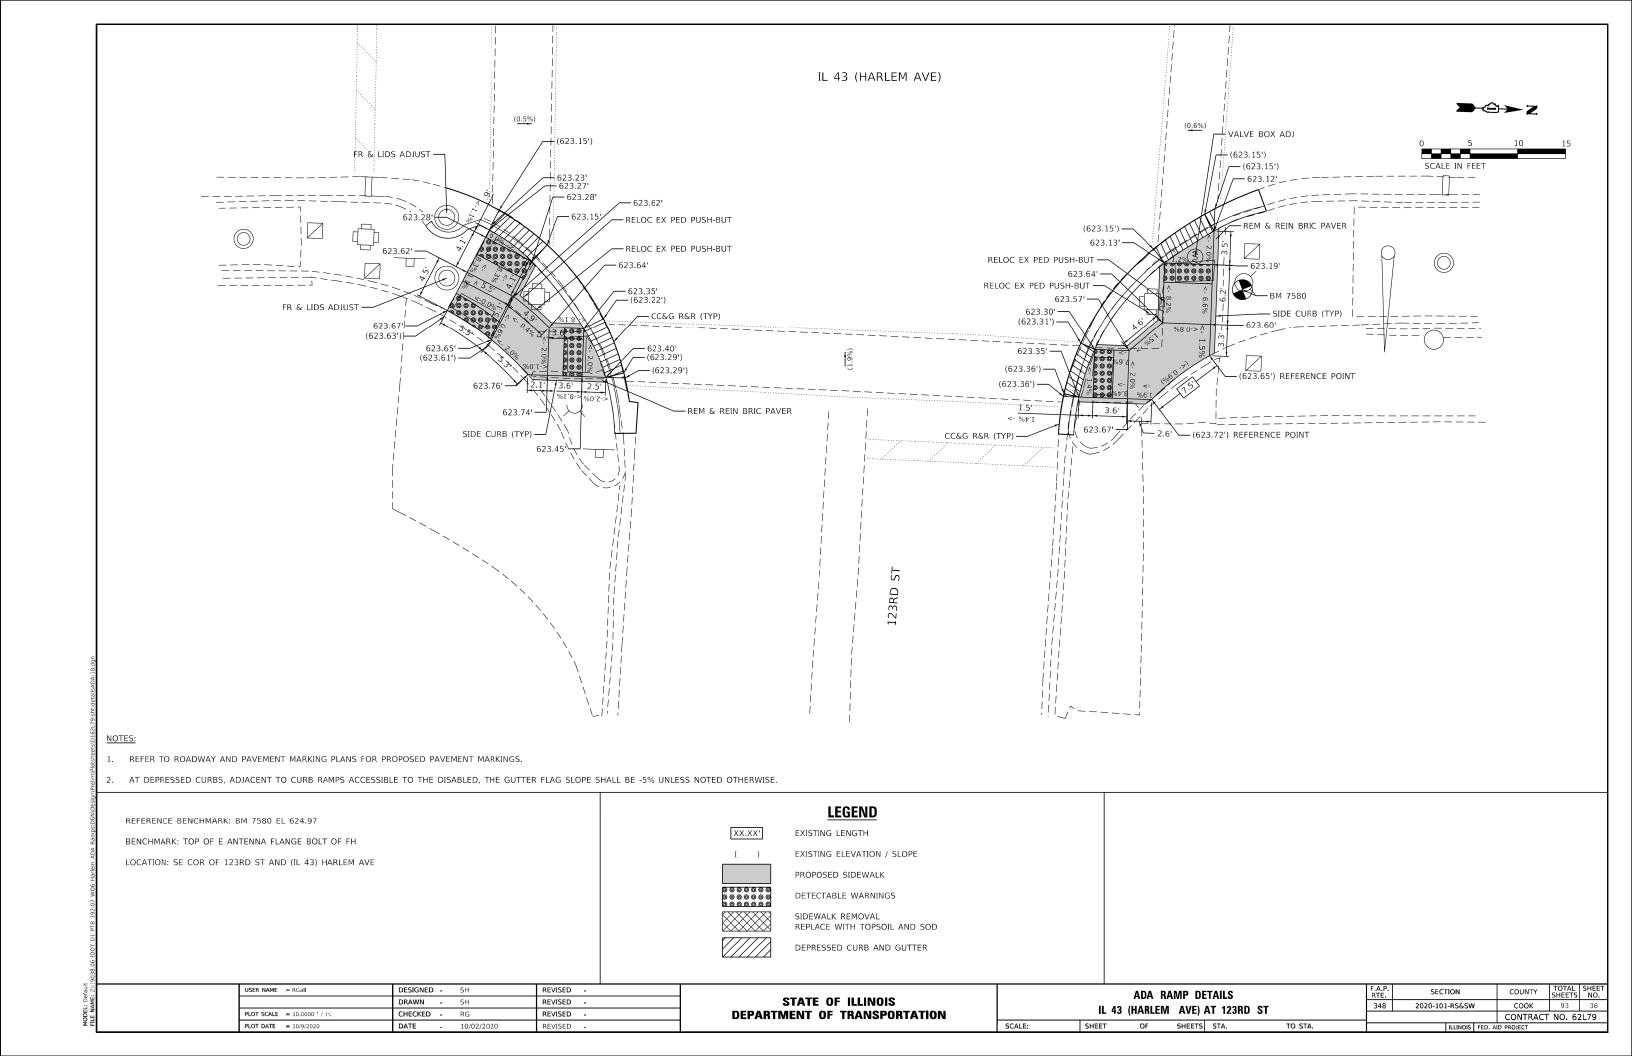

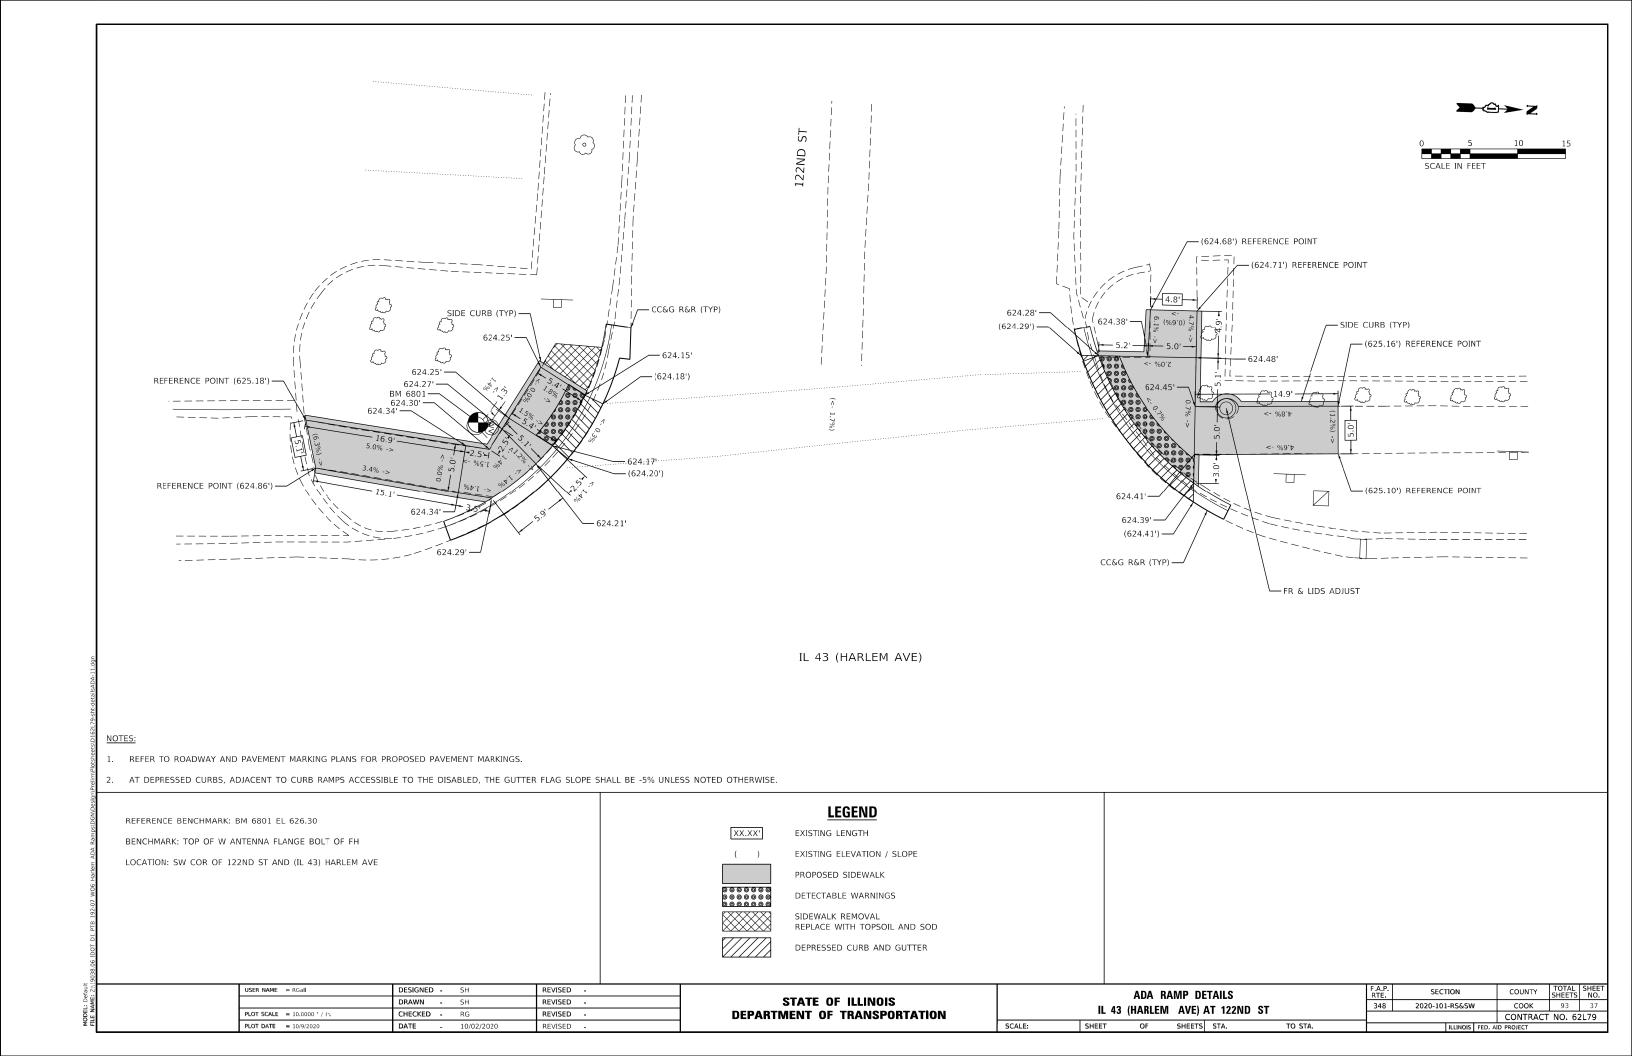





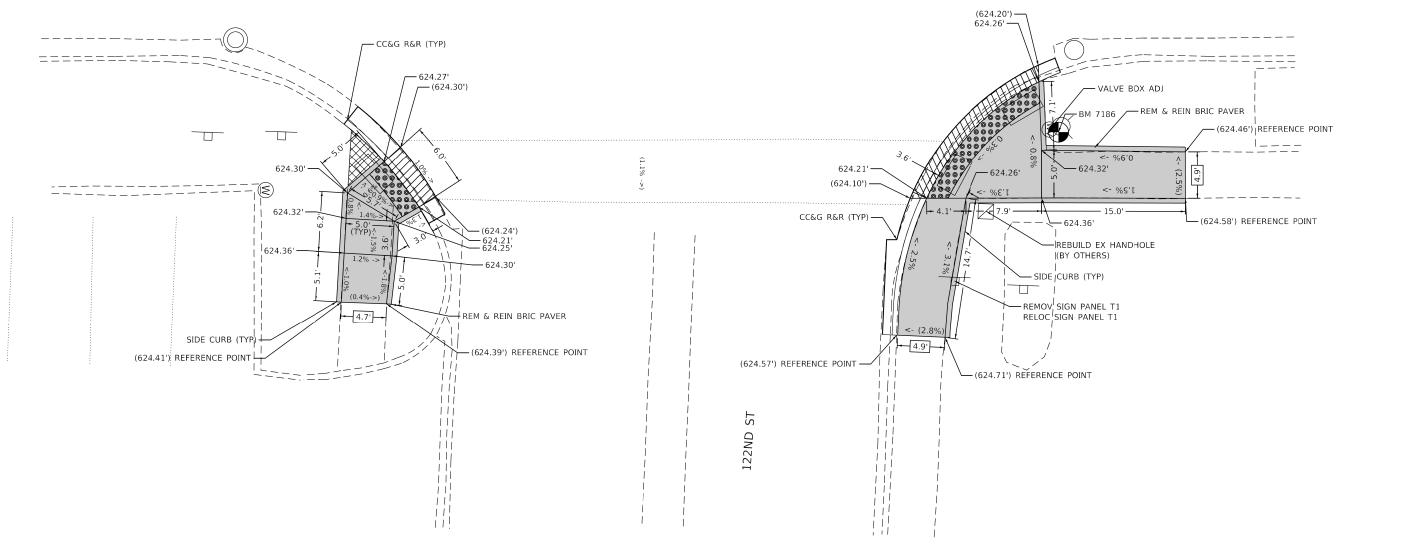

NOTES:

- 1. REFER TO ROADWAY AND PAVEMENT MARKING PLANS FOR PROPOSED PAVEMENT MARKINGS.
- 2. AT DEPRESSED CURBS, ADJACENT TO CURB RAMPS ACCESSIBLE TO THE DISABLED, THE GUTTER FLAG SLOPE SHALL BE -5% UNLESS NOTED OTHERWISE.

REFERENCE BENCHMARK: BM 7186 EL 626.08

BENCHMARK: TOP OF E ANTENNA FLANGE BOLT OF FH

LOCATION: NE COR OF 122ND ST AND (IL 43) HARLEM AVE

LOCATION: NE COR OF 122ND ST AND (IL 43) HARLEM AVE

PROPOSED SIDEWALK

PROPOSED SIDEWALK

DETECTABLE WARNINGS

SIDEWALK REMOVAL


REPLACE WITH TOPSOIL AND SOD

DEPRESSED CURB AND GUTTER

USER NAME = RGall	DESIGNED - SH	REVISED -
	DRAWN - SH	REVISED -
PLOT SCALE = 10.0000 ' / in.	CHECKED - RG	REVISED -
PLOT DATE = 10/9/2020	DATE - 10/02/2020	REVISED -

STATE (OF ILLINOIS
DEPARTMENT O	TRANSPORTATION

								F.A.P. SECTI			COUNTY	TOTAL SHEETS	SHEET NO.
	IL 43 (HARLEM AVE) AT 122ND ST						348	2020-101-RS&SW		соок	93	38	
L	IL 43 (MANLEIVI AVE) AT 1221VD 31										CONTRACT	NO. 62	L79
	SCALE:	SHEET	OF	SHEETS	STA.	TO STA.	ILLINOIS FED. AID PROJECT			D PROJECT			

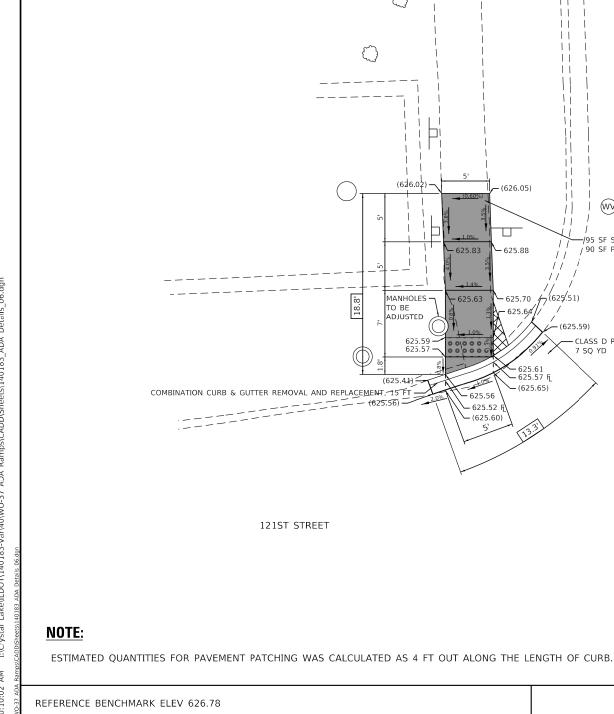

1.1 Τİ **625.70** (62**5**/.51) 625.64// **(**625.59) CLASS D PATCHES, 10 INCH 7 SQ YD 625.61 625.57 FL

BENCHMARK: TOP OF THE WEST FLANGE BOLT OF FIRE HYDRANT LOCATED AT SOUTHWEST CORNER OF 121th PLACE & HARLEM AVENUE.

REFERENCE BENCHMARK ELEV 626.04

BENCHMARK: "X" ON SIDEWALK, NORTHERN: 1823453.37 EASTERN: 1130803.89

LEGEND

EXISTING LENGTH



PROPOSED SIDEWALK



PROPOSED SIDE CURB

EXISTING ELEVATION/SLOPE



DETECTABLE WARNINGS

SIDEWALK REMOVAL REPLACE W/ TOPSOIL & SOD


BAXTER WOODMAN Consulting Engineers

USER NAME = mornig	DESIGNED - CJC	REVISED -
	DRAWN - MJO	REVISED -
PLOT SCALE = 10.0000 ' / in.	CHECKED - AKS	REVISED -
PLOT DATE = 10/9/2020	DATE - 10-9-20	FILE - 140183_ADA Details_06.dgn

STATE OF ILLINOIS **DEPARTMENT OF TRANSPORTATION**

ADA SIDEWALK DETAILS										
IL-	-43 (HA	RLEM	AVE)	FRO	M 111	111TH TO			(159TH	ST)
SCALE:	1"=5'	SHEET	6 ()F 12	SHEETS	STA.			TO STA.	

F.A.P. RTE	SECT	ION		COUNTY	TOTAL SHEETS	SHEET NO.	
348	2020-101	-RS&SW	1	соок	93	39	
			CONTRACT NO. 62L79				
		ILLINOIS	ID PROJECT				

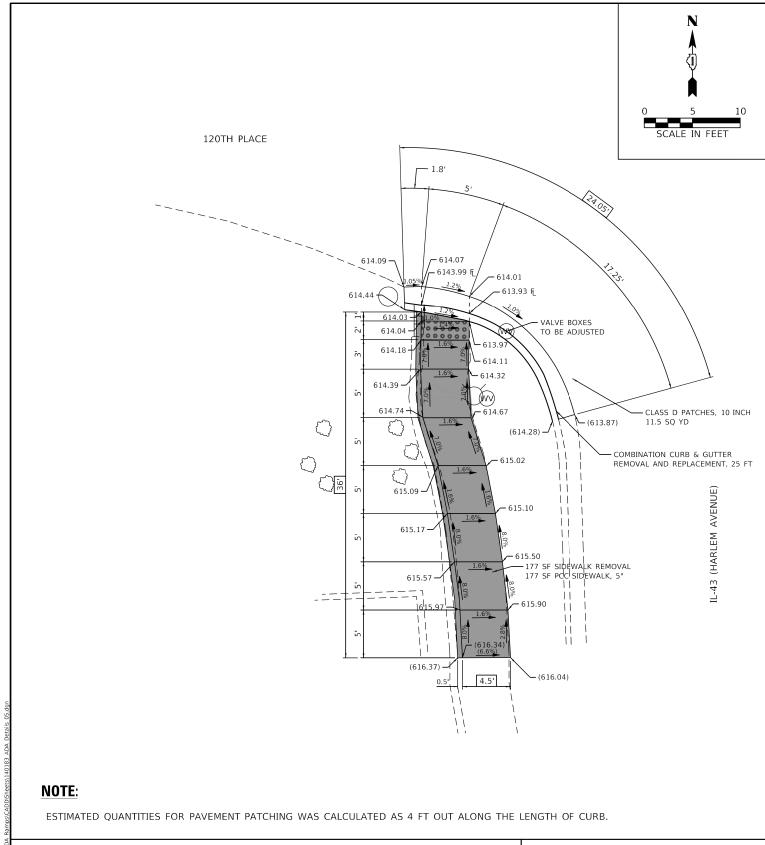

USER NAME = mornig DESIGNED - KGC DRAWN - MJO PLOT SCALE = 10.0000 ' / in CHECKED - AKS PLOT DATE = 10/9/2020 DATE

LEGEND

EXISTING LENGTH

PROPOSED SIDE CURB

EXISTING ELEVATION/SLOPE



PROPOSED SIDEWALK



DETECTABLE WARNINGS

SIDEWALK REMOVAL REPLACE W/ TOPSOIL & SOD

STATE OF ILLINOIS **DEPARTMENT OF TRANSPORTATION**

ADA SIDEWALK DETAILS SECTION COUNTY SHEETS NO.

COOK 93 40 2020-101-RS&SW IL-43 (HARLEM AVE) FROM 111TH TO US 6 (159TH ST) CONTRACT NO. 62L79 SCALE: 1"=5' SHEET 5 OF 12 SHEETS STA.

BENCHMARK: TOP OF THE WEST ANTENNA FLANGE BOLT OF FIRE HYDRANT LOCATED AT SOUTHWEST CORNER OF 120th STREET & HARLEM AVENUE.


REFERENCE BENCHMARK ELEV 615.65

REFERENCE BENCHMARK ELEV 616.32

BENCHMARK: "X" ON SIDEWALK, NORTHERN: 1824032.28 EASTERN: 1130783.61

BAXTER WOODMAN Consulting Engineers

REVISED -REVISED -REVISED -FILE - 140183_ADA Details_05.dgn

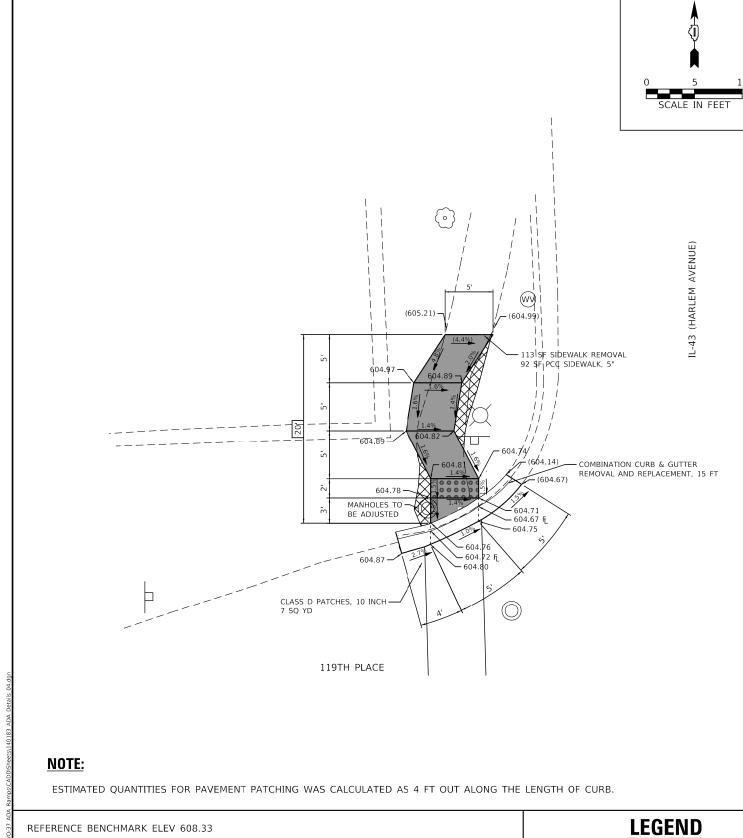

119TH PLACE LINE 24" (STOP BAR, WHITE) -606.00 - 605.96 605.92 FL (606.37) - CLASS D PATCHES, 10 INCH 6.5 SQ YD - COMBINATION CURB & GUTTER REMOVAL AND REPLACEMENT, 14 FT — 130 SF SIDEWALK REMOVAL 130 SF PCC SIDEWALK, 5" 606.95 -(607.16) (607.39) -

REFERENCE BENCHMARK ELEV 608.33

BENCHMARK: TOP OF THE WEST ANTENNA FLANGE BOLT OF FIRE HYDRANT LOCATED AT SOUTHWEST CORNER OF 119th PLACE & HARLEM AVENUE.

REFERENCE BENCHMARK ELEV 605.46

BENCHMARK: "X" ON SIDEWALK, NORTHERN: 1824442.11 EASTERN: 1130767.12

EXISTING LENGTH



EXISTING ELEVATION/SLOPE

PROPOSED SIDEWALK



DETECTABLE WARNINGS

SIDEWALK REMOVAL REPLACE W/ TOPSOIL & SOD REFERENCE BENCHMARK ELEV 608.33

BENCHMARK: TOP OF THE WEST ANTENNA FLANGE BOLT OF FIRE HYDRANT LOCATED AT SOUTHWEST CORNER OF 119th PLACE & HARLEM AVENUE.

REFERENCE BENCHMARK ELEV 605.46

BENCHMARK: "X" ON SIDEWALK, NORTHERN: 1824442.11 EASTERN: 1130767.12


BAXTER WOODMAN


USER NAME = mornig	DESIGNED - CJC	REVISED -
	DRAWN - MJO	REVISED -
PLOT SCALE = 10.0000 ' / in.	CHECKED - AKS	REVISED -
PLOT DATE = 10/9/2020	DATE - 10-9-20	FILE - 140183_ADA Details_04.dgn


STATE OF ILLINOIS **DEPARTMENT OF TRANSPORTATION**

	ADA SIDEWALK DETAILS										
IL-	IL-43 (HARLEM AVE) FROM 111TH TO US 6 (159TH ST)										
SCALE:	1"=5'	SHEET	4 (OF	12	SHEETS	STA.			TO STA.	

F.A.P. RTE.	SECT	ION		COUNTY	TOTAL SHEETS	SHEET NO.
348	2020-101	-RS&SW	1	СООК	93	41
				CONTRACT	NO. 62	2L79
		ILLINOIS	FED. A	ID PROJECT		

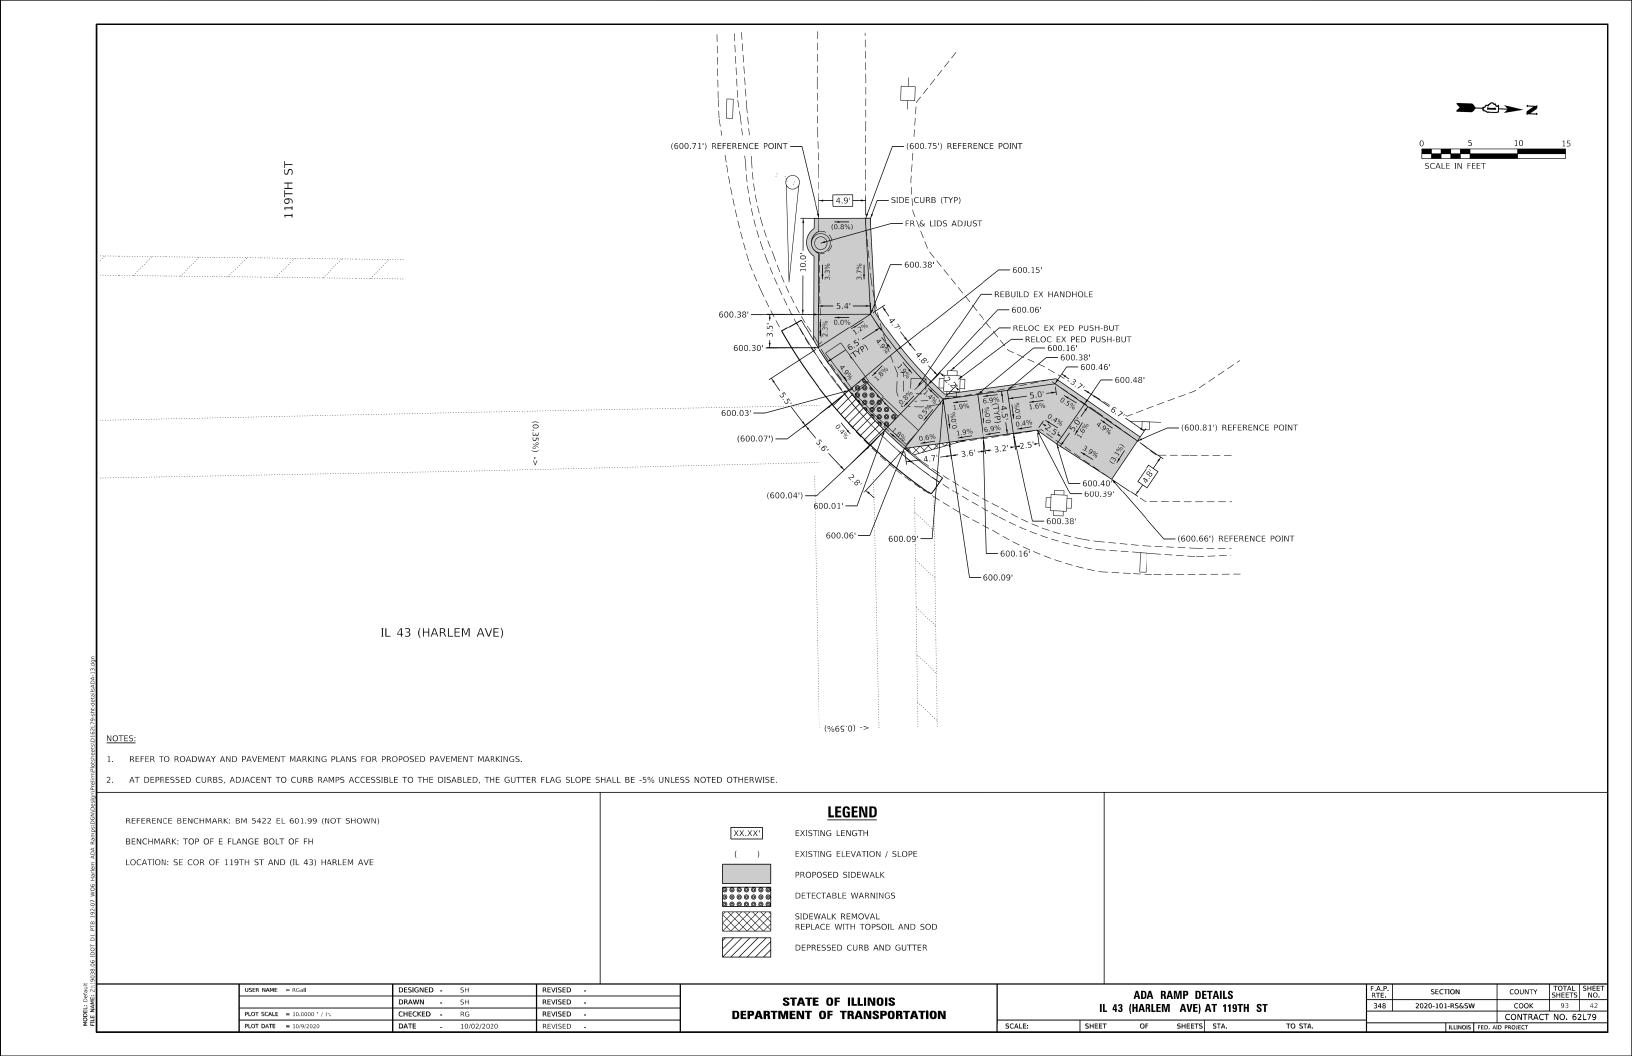


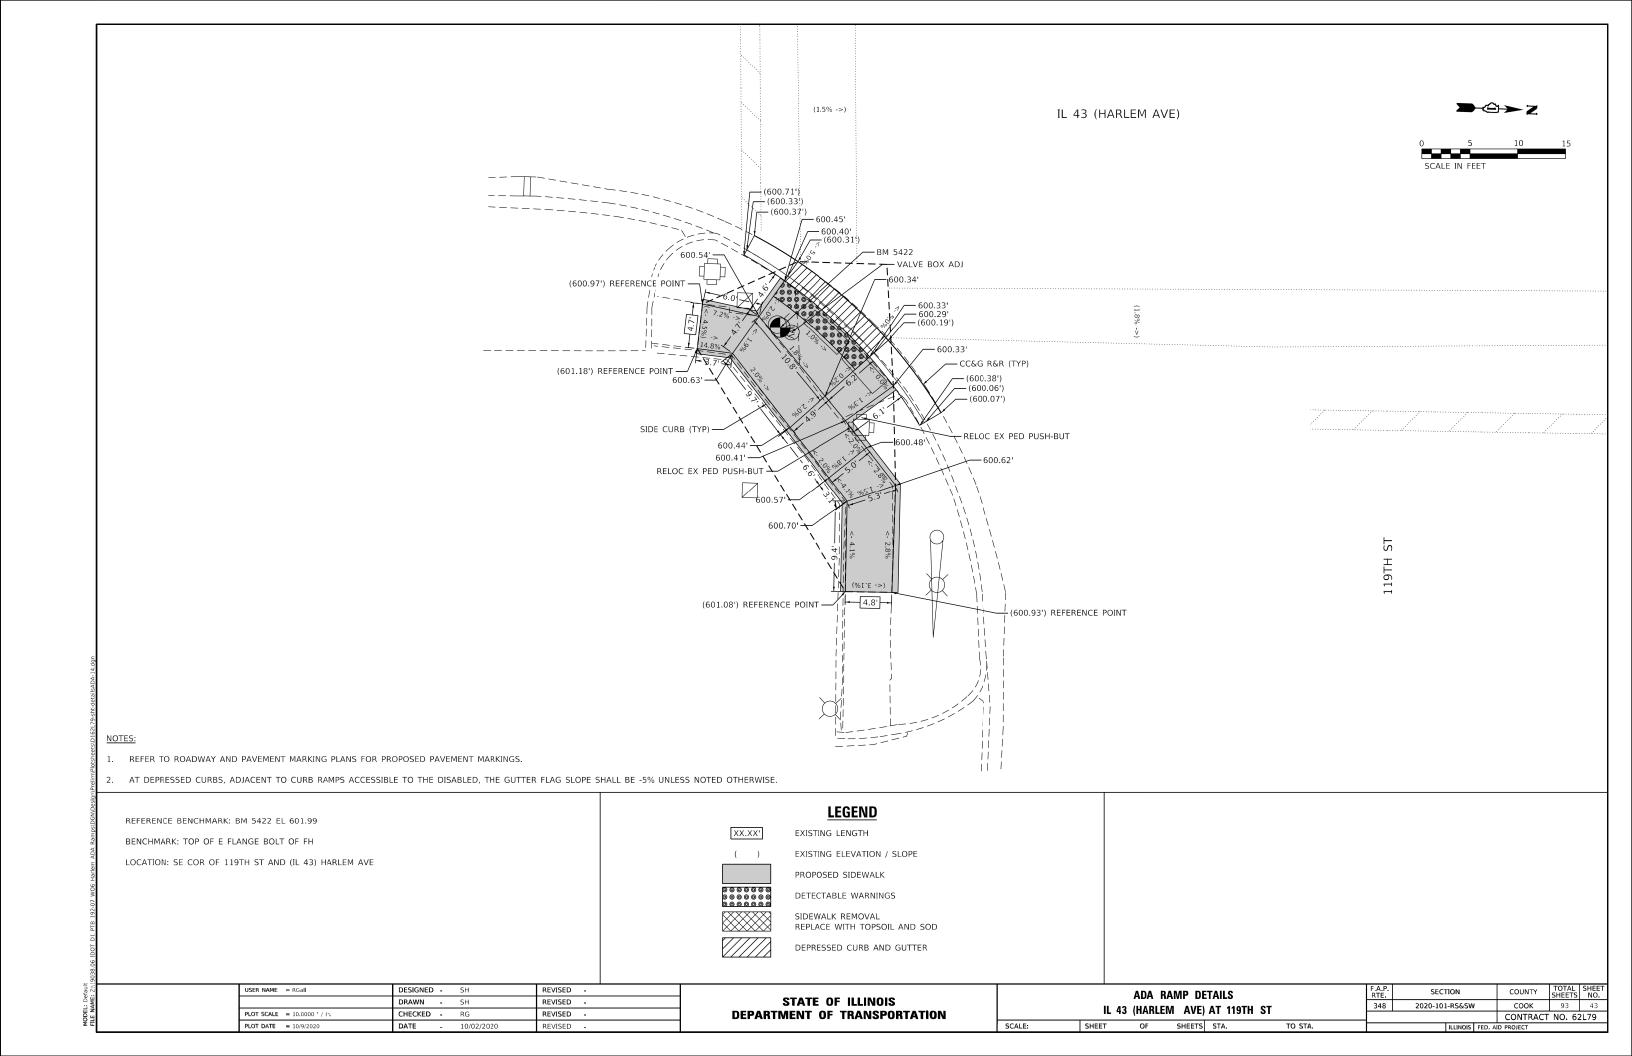

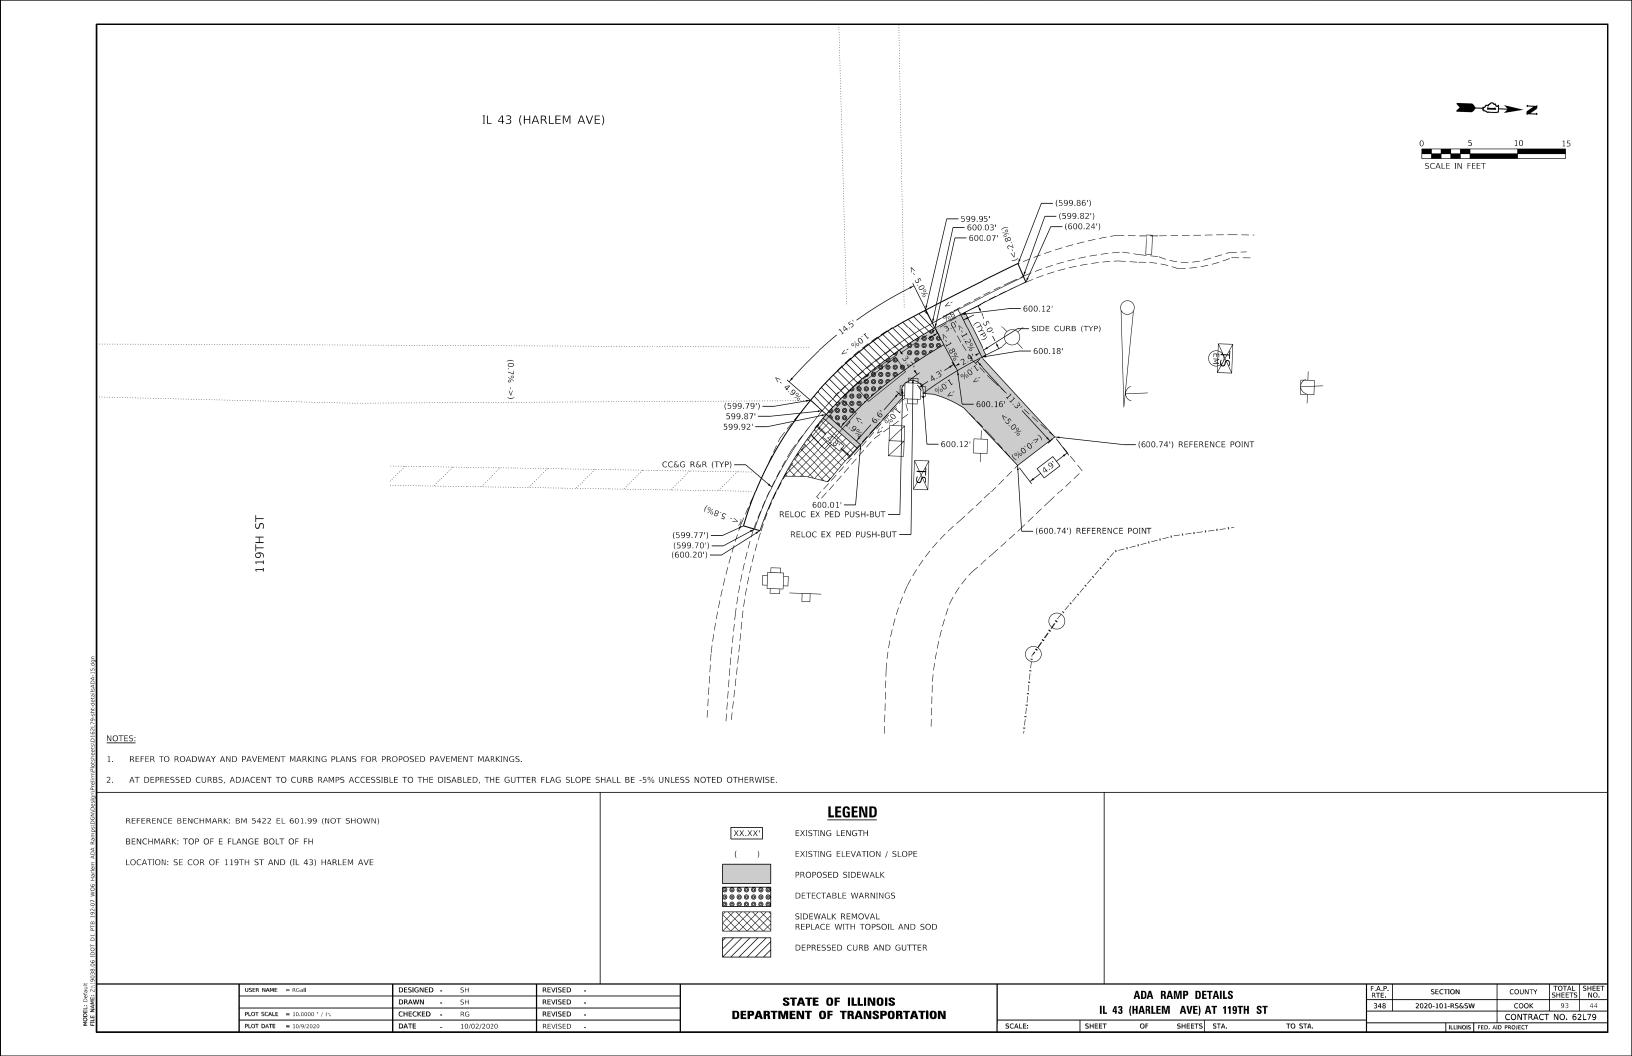



IL 43 (HARLEM AVE)

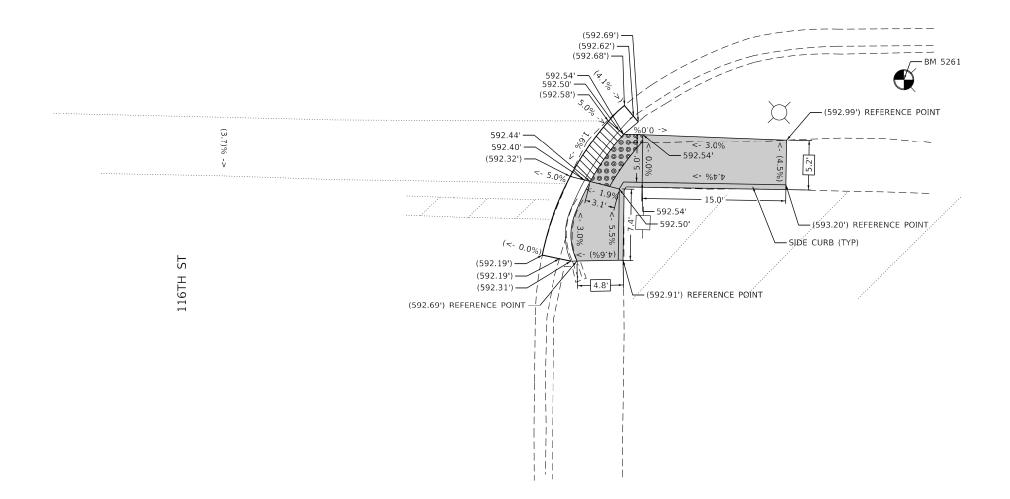

NOTES:

- 1. REFER TO ROADWAY AND PAVEMENT MARKING PLANS FOR PROPOSED PAVEMENT MARKINGS.
- 2. AT DEPRESSED CURBS, ADJACENT TO CURB RAMPS ACCESSIBLE TO THE DISABLED, THE GUTTER FLAG SLOPE SHALL BE -5% UNLESS NOTED OTHERWISE.

REFERENCE BENCHMARK: BM 5261 EL 595.33

BENCHMARK: TOP OF E FLANGE BOLT OF FH

LOCATION: NE COR OF 116TH ST AND (IL 43) HARLEM AVE

LOCATION: NE COR OF 116TH ST AND (IL 43) HARLEM AVE

PROPOSED SIDEWALK

PROPOSED SIDEWALK

DETECTABLE WARNINGS

SIDEWALK REMOVAL
REPLACE WITH TOPSOIL AND SOD

DEPRESSED CURB AND GUTTER

USER	R NAME = RGall	DESIGNED	-	SH	REVISED	-
		DRAWN	-	SH	REVISED	-
PLOT	SCALE = 10.0000 ' / in.	CHECKED	-	RG	REVISED	-
PLOT	DATE = 10/9/2020	DATE	_	10/02/2020	REVISED	_

STATE OI	F ILLINOIS
DEPARTMENT OF	TRANSPORTATION

		F.A.P. RTE. SECTION				COUNTY	TOTAL SHEETS	SHEET NO.					
	IL 43 (HARLEM AVE) AT 116TH ST							348 2020-101-RS&SW			соок	93	45
											CONTRACT	NO. 62	2L79
	SCALE:	SHEET	OF	SHEETS	STA.	TO STA.			ILLINOIS	FED. AIC	PROJECT		

STATE OF ILLINOIS **DEPARTMENT OF TRANSPORTATION**

CONTRACT NO. 62L79 OF SHEETS STA. TO STA. SHEET

--- (593.69') --- (594.17')

<- %ε'8 — 12.2' –

4.6'

- 593.70

- 594.81

-(595.48') REFERENCE POINT

— (594.49') REFERENCE POINT

(594.71') REFERENCE POINT

593.64'-

593.55' -

593.51' -

(593.55') -

∐ ¦ 593.60' ·

593.50'

(595.34') REFERENCE POINT -

(593.51')

(593.44') — (593.41') —

(593.81').—

REFERENCE BENCHMARK: BM 5261 EL 595.33 (NOT SHOWN) BENCHMARK: TOP OF E FLANGE BOLT OF FH LOCATION: NE COR OF 116TH ST AND (IL 43) HARLEM AVE

LEGEND XX.XX' EXISTING LENGTH EXISTING ELEVATION / SLOPE PROPOSED SIDEWALK 0000000 DETECTABLE WARNINGS

SIDEWALK REMOVAL REPLACE WITH TOPSOIL AND SOD

DEPRESSED CURB AND GUTTER

	ADA RAMP DETAILS	F.A.P. RTE.	SECTION	COUNTY	TOTAL SHEETS	SHEET NO.
	II 43 (HARIEM AVE) AT 115 PI	348	2020-101-RS&SW	соок	93	46

(594.31') REFERENCE POINT

(594.40') REFERENCE POINT -

1. REFER TO ROADWAY AND PAVEMENT MARKING PLANS FOR PROPOSED PAVEMENT MARKINGS.

43 (HARLEM A	VE)
--------------	-----

ΙL

--- (593.68')

> - 593.57' 593.47'

.... 593.51'

— (594.61') R∉FERENCE POINT

FR & GRATES ADJUST

- CC&G R&R (TYP)

593.65'

- 5.0'-(TYP)

4.9'


| (%6.0->)


(3)


%S'S -> 593.67—


(594.70') REFERENCE POINT -


2. AT DEPRESSED CURBS, ADJACENT TO CURB RAMPS ACCESSIBLE TO THE DISABLED, THE GUTTER FLAG SLOPE SHALL BE -5% UNLESS NOTED OTHERWISE.

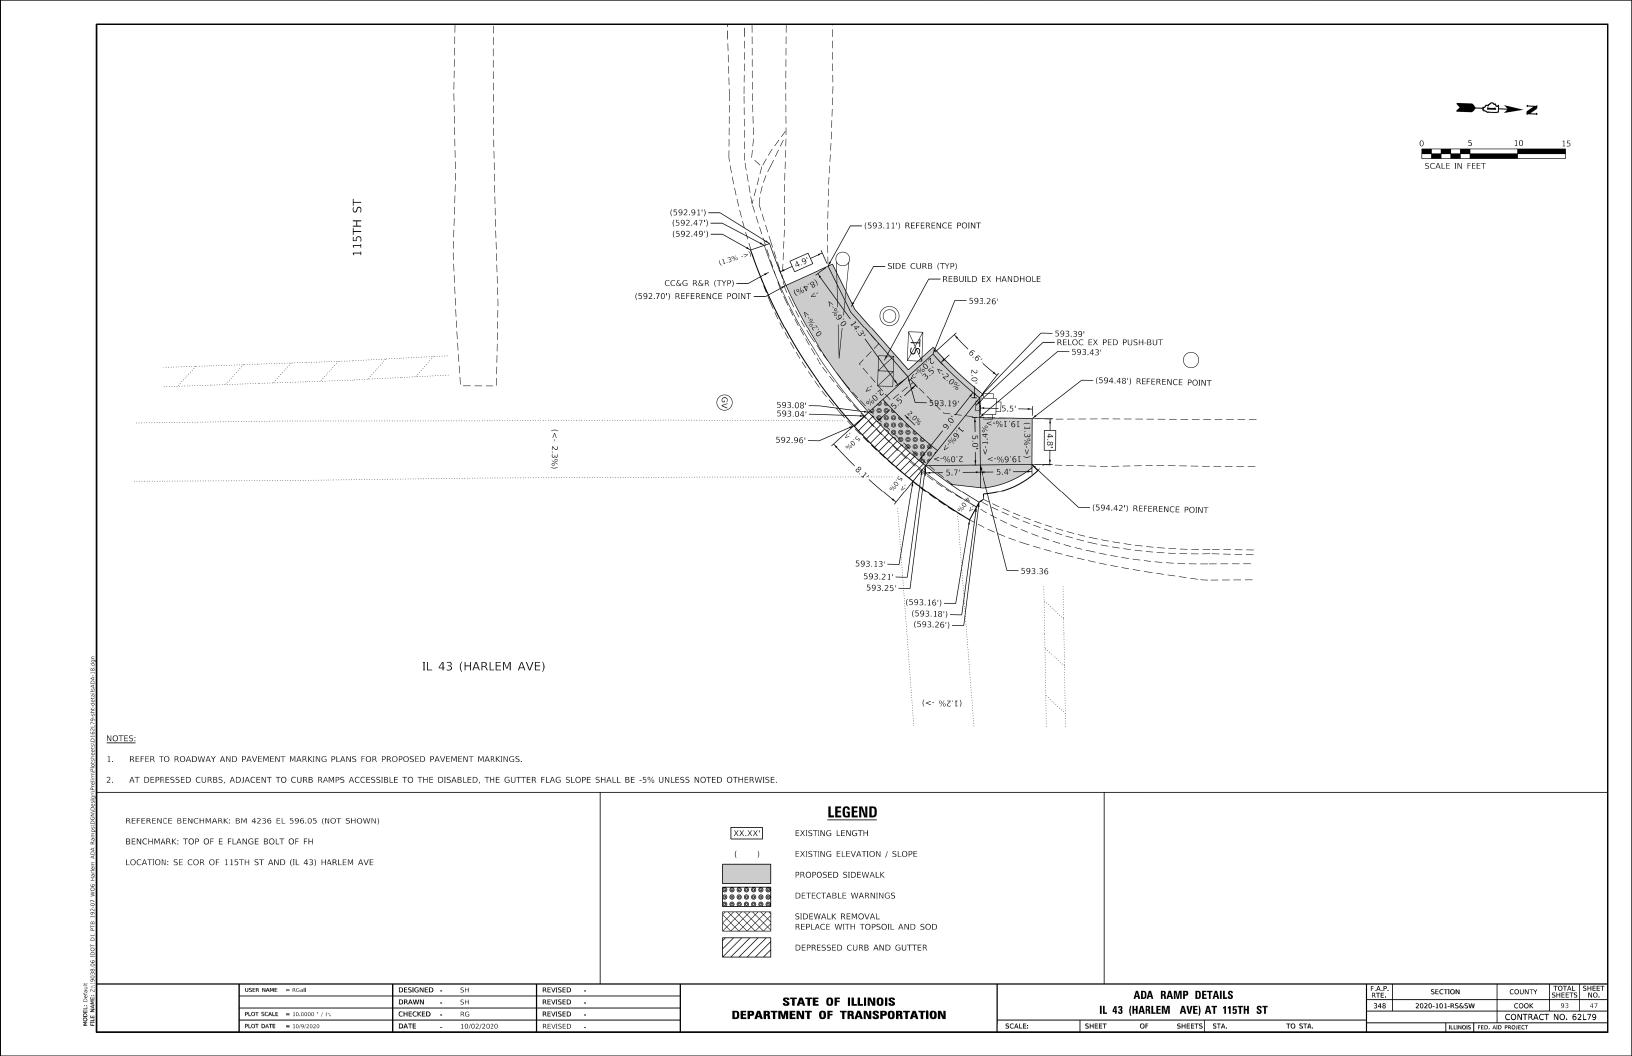


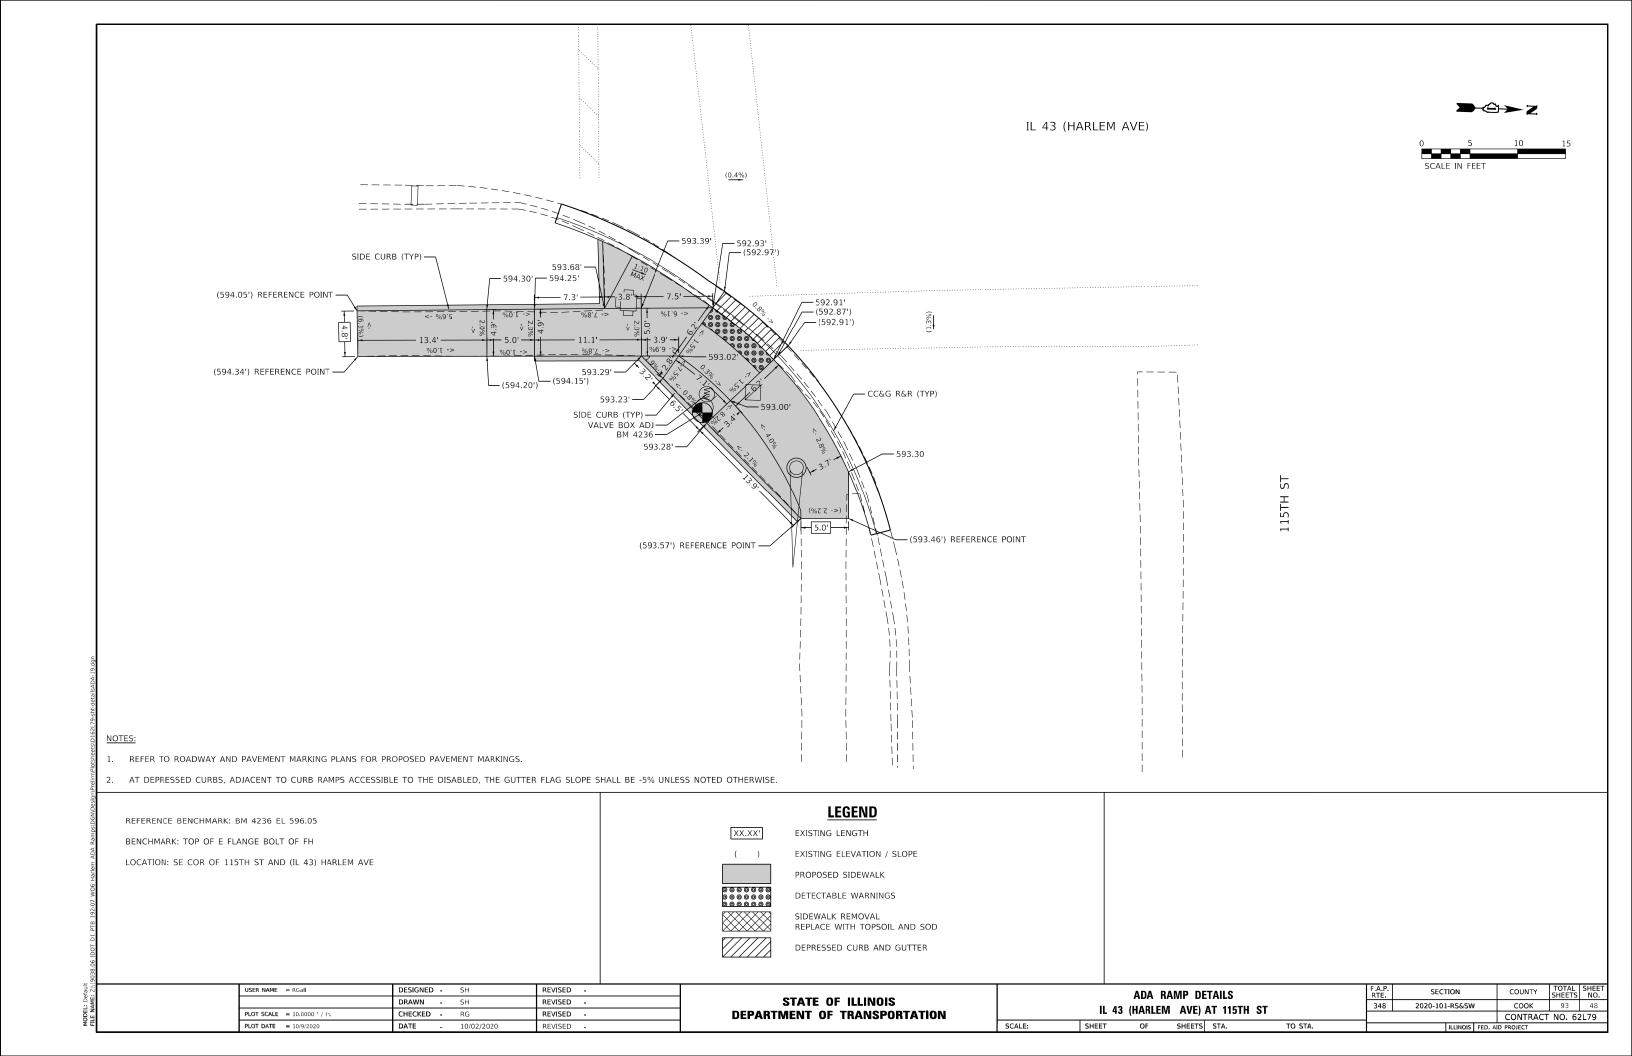

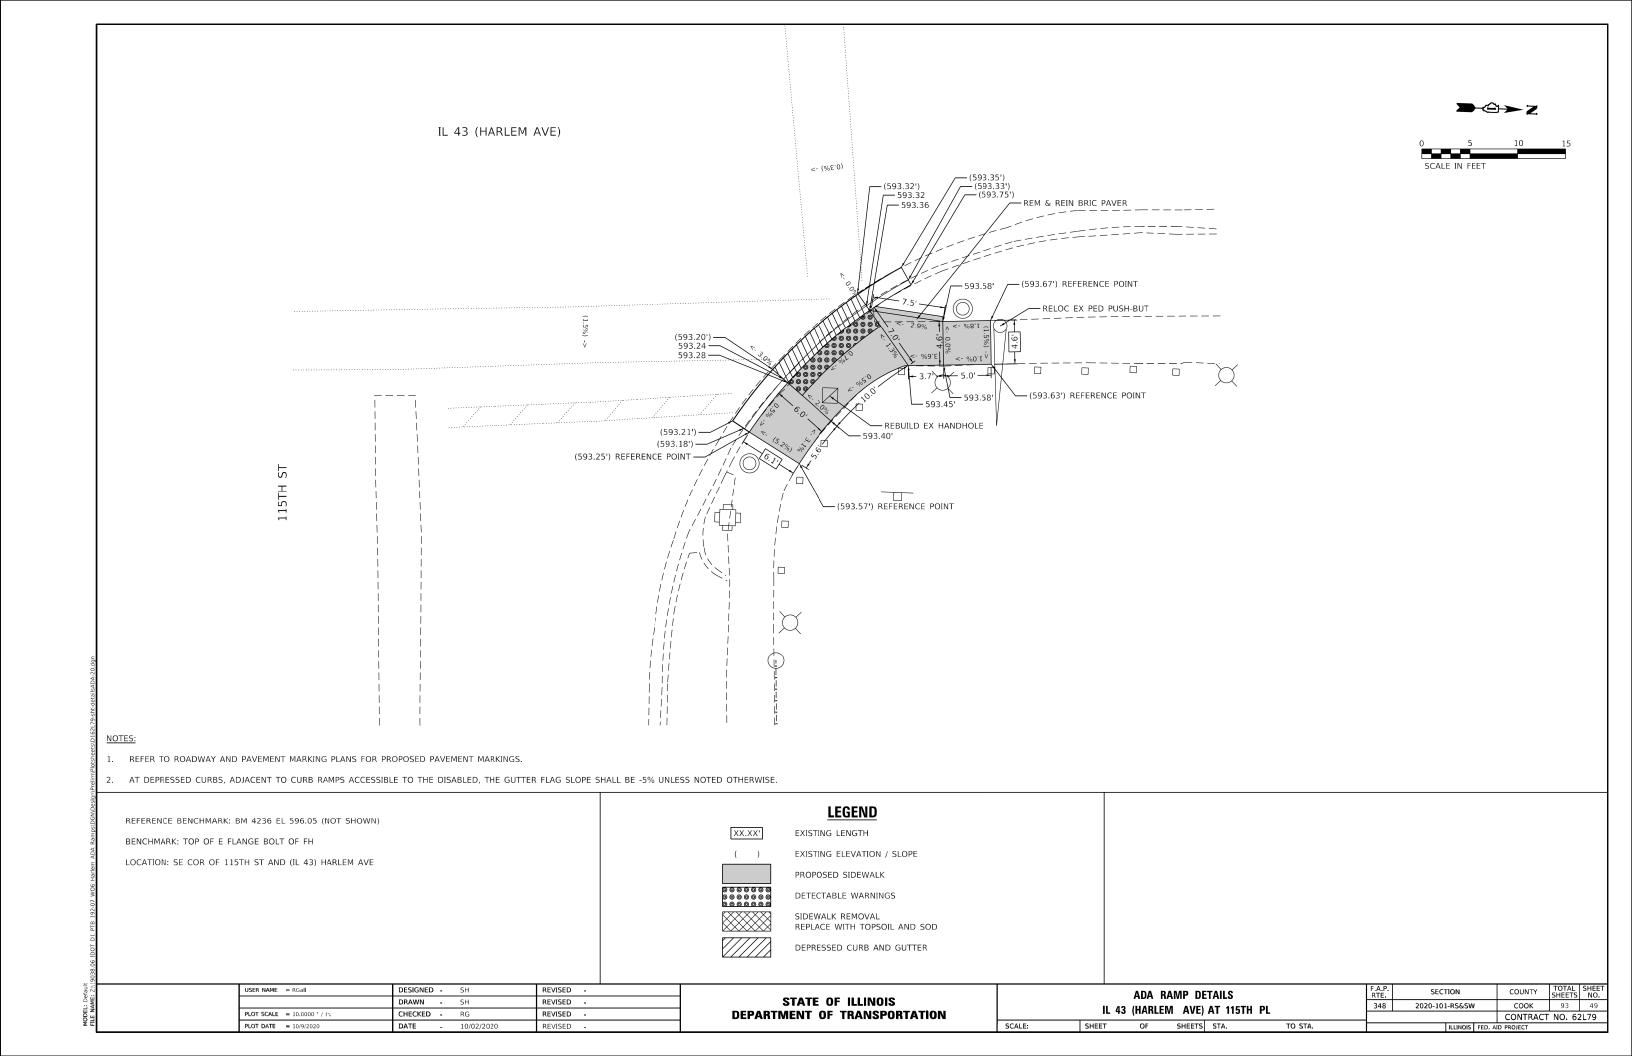

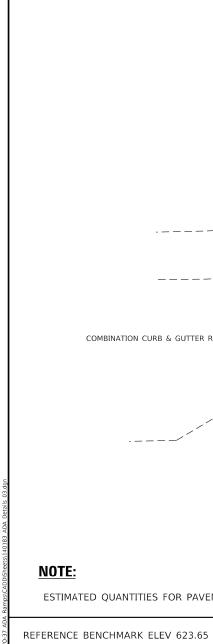

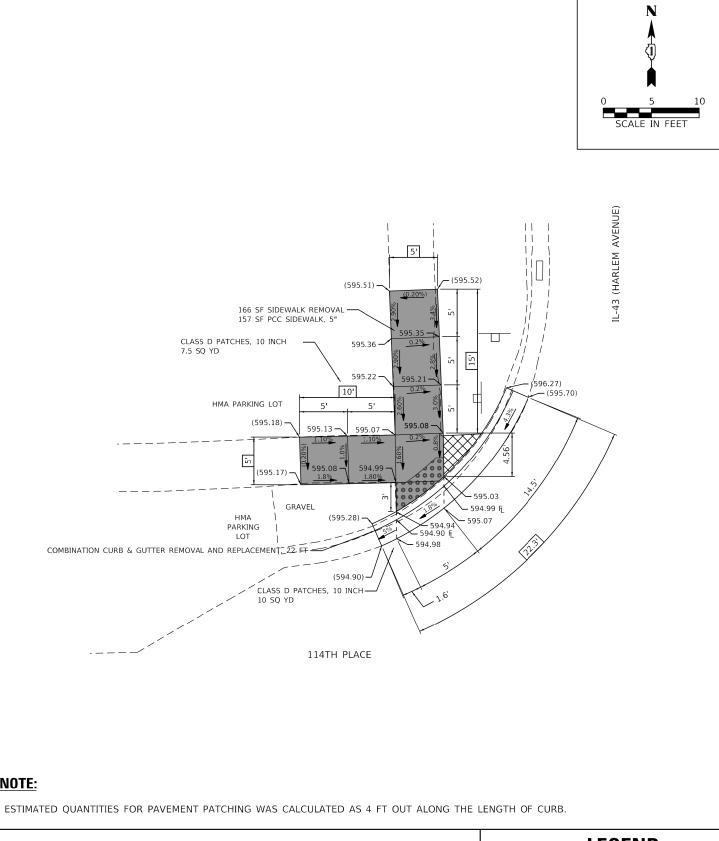

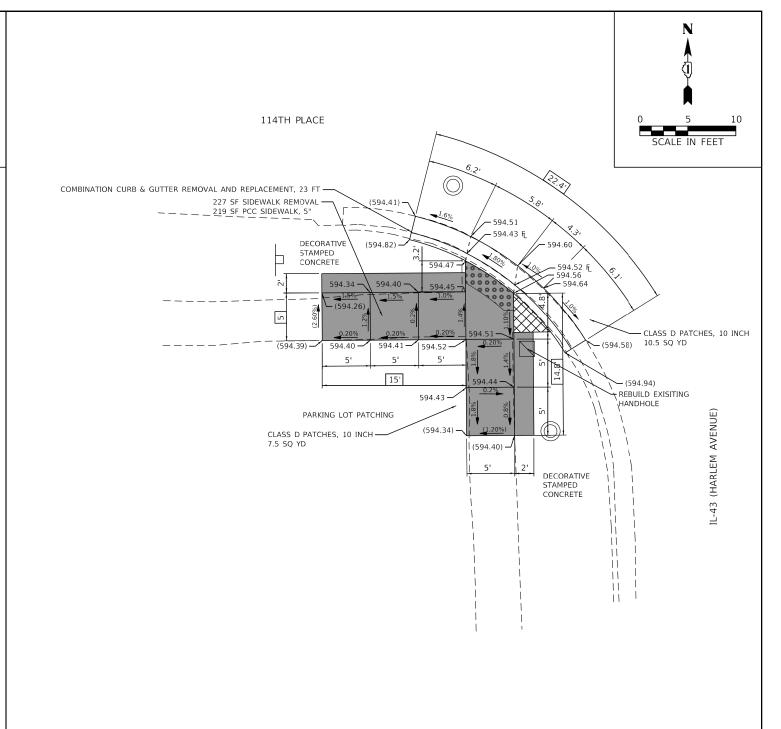

BENCHMARK: TOP OF THE EAST FLANGE BOLT OF FIRE HYDRANT LOCATED AT SOUTHWEST CORNER OF 112th PLACE & HARLEM AVENUE.


REFERENCE BENCHMARK ELEV 595.46

BENCHMARK: "X" ON SIDEWALK, NORTHERN: 1827764.61 EASTERN: 1130647.71

LEGEND

EXISTING LENGTH

PROPOSED SIDE CURB EXISTING ELEVATION/SLOPE

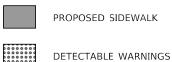

SIDEWALK REMOVAL REPLACE W/ TOPSOIL & SOD REFERENCE BENCHMARK ELEV 623.65

BENCHMARK: TOP OF THE EAST FLANGE BOLT OF FIRE HYDRANT LOCATED AT SOUTHWEST CORNER OF 112th PLACE & HARLEM AVENUE.

REFERENCE BENCHMARK ELEV 594.40

BENCHMARK: "X" ON SIDEWALK, NORTHERN: 1827683.05 EASTERN: 1130651.37

BAXTER WOODMAN

USER NAME = mornig	DESIGNED - AKS	REVISED -
	DRAWN - MJO	REVISED -
PLOT SCALE = 10.0000 ' / in.	CHECKED - CJC	REVISED -
PLOT DATE = 10/9/2020	DATE - 10-9-20	FILE - 140183_ADA Details_03.dgn


STATE OF ILLINOIS **DEPARTMENT OF TRANSPORTATION**

	ADA SIDEWALK DETAILS									
L-	IL-43 (HARLEM AVE) FROM 111TH TO US 6 (159TH ST)									
SCALE:	1"=5'	SHEET	3 C)F 12	SHEETS	STA.		TO STA.		

ADA SIDEWALK DETAILS	F.A.P. RTE	SECTION	COUNTY	TOTAL SHEETS	SHEET NO.
M AVE) FROM 111TH TO US 6 (159TH ST)	348	2020-101-RS&SW	соок	93	50
W AVE THOW TITH TO US U (1991) ST			CONTRACT	NO. 62	2L79
ET 3 OF 12 SHEETS STA. TO STA.		ILLINOIS FE	D. AID PROJECT		

IL 43 (HARLEM AVE)



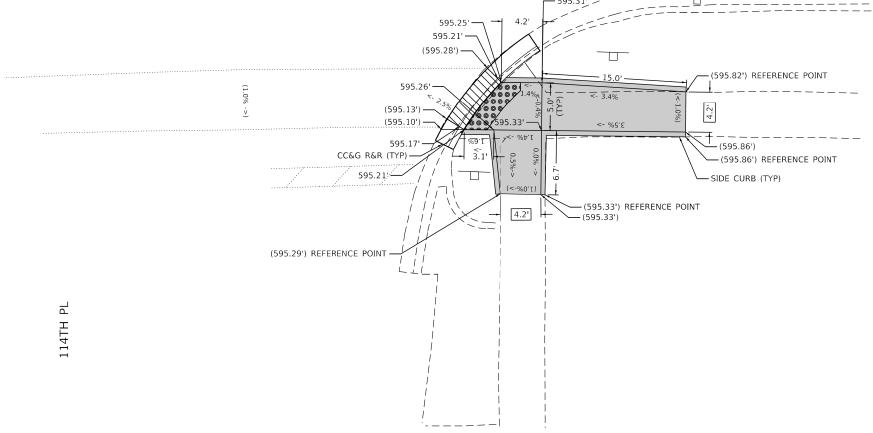

NOTES:

1. REFER TO ROADWAY AND PAVEMENT MARKING PLANS FOR PROPOSED PAVEMENT MARKINGS.

USER NAME = RGall

PLOT SCALE = 10.0000 ' / in.

PLOT DATE = 10/9/2020

2. AT DEPRESSED CURBS, ADJACENT TO CURB RAMPS ACCESSIBLE TO THE DISABLED, THE GUTTER FLAG SLOPE SHALL BE -5% UNLESS NOTED OTHERWISE.

DESIGNED - SH

DRAWN - SH

DATE

CHECKED - RG

REFERENCE BENCHMARK: BM 3116 EL 606.53 (NOT SHOWN)

BENCHMARK: TOP OF S FLANGE BOLT OF FH

LOCATION: SE COR OF 114TH ST AND (IL 43) HARLEM AVE

COMMON SE COR OF 114TH ST AND (IL 43) HARLEM AVE

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REVISED -

REVISED -


REVISED -

REVISED

STAT	E 01	F ILLINOIS
DEPARTMENT	OF	TRANSPORTATION


SCALE:

	ADA RAMP DETAILS IL 43 (HARLEM AVE) AT 114TH PL					F.A.P. RTE.	SECTION	COUNTY	TOTAL SHEETS	SHEET NO.	
						348	348 2020-101-RS&SW		93	51	
	IL .	13 (IIAIIEEIVI	745	A1 117111	· •			CONTRACT NO. 62L79			
	SHEET	OF	SHEETS	STA.	TO STA.		ILLINOIS FEE	AID PROJECT	ID PROJECT		

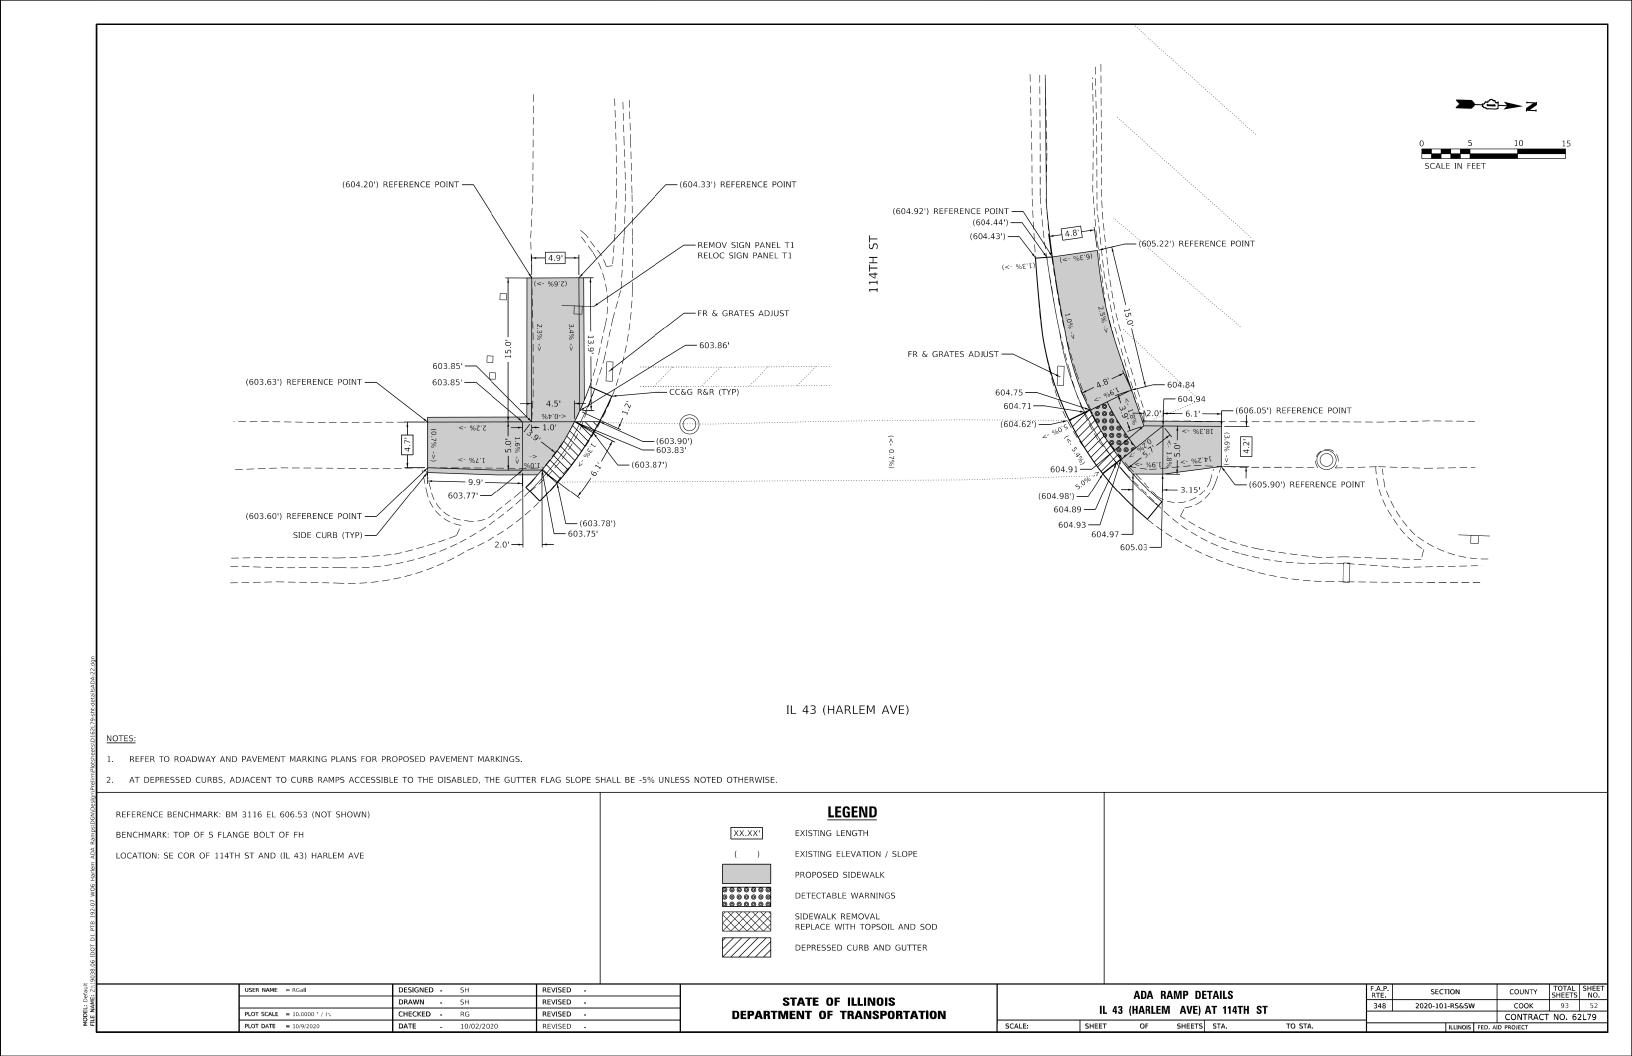





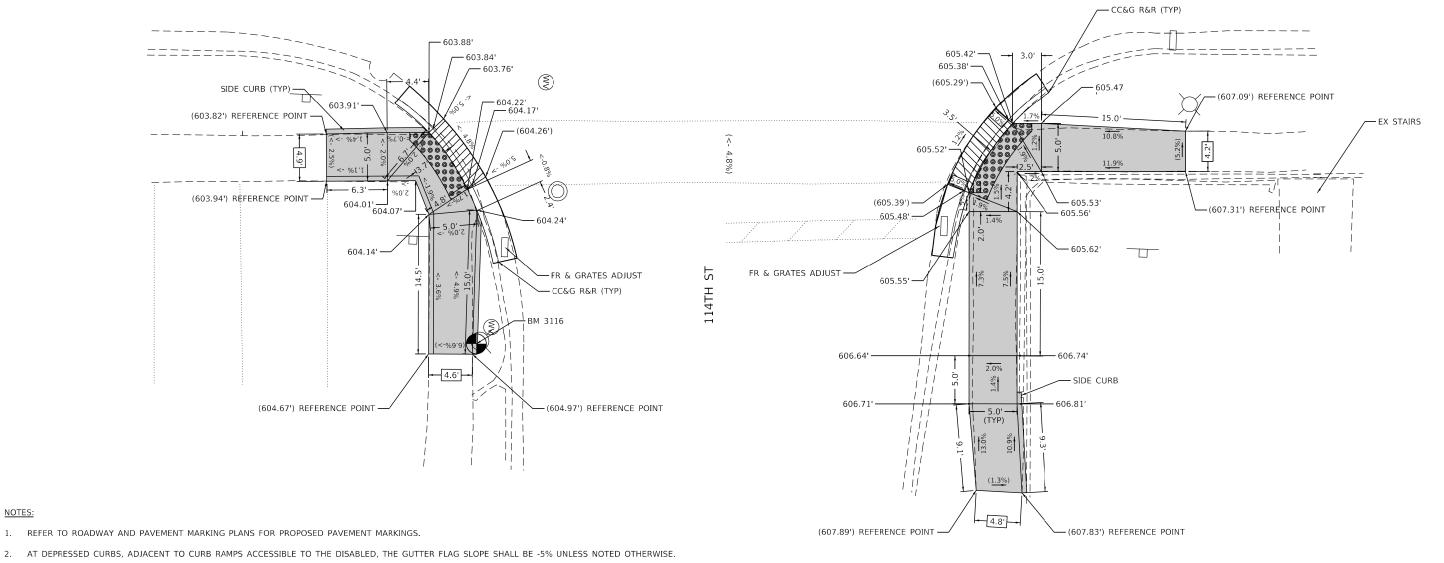

LEGEND REFERENCE BENCHMARK: BM 3116 EL 606.53 BENCHMARK: TOP OF S FLANGE BOLT OF FH XX.XX' EXISTING LENGTH EXISTING ELEVATION / SLOPE LOCATION: SE COR OF 114TH ST AND (IL 43) HARLEM AVE PROPOSED SIDEWALK DETECTABLE WARNINGS SIDEWALK REMOVAL REPLACE WITH TOPSOIL AND SOD DEPRESSED CURB AND GUTTER


USER NAME = RGall DESIGNED - SH REVISED -DRAWN -REVISED -PLOT SCALE = 10.0000 ' / in. CHECKED - RG REVISED -PLOT DATE = 10/9/2020


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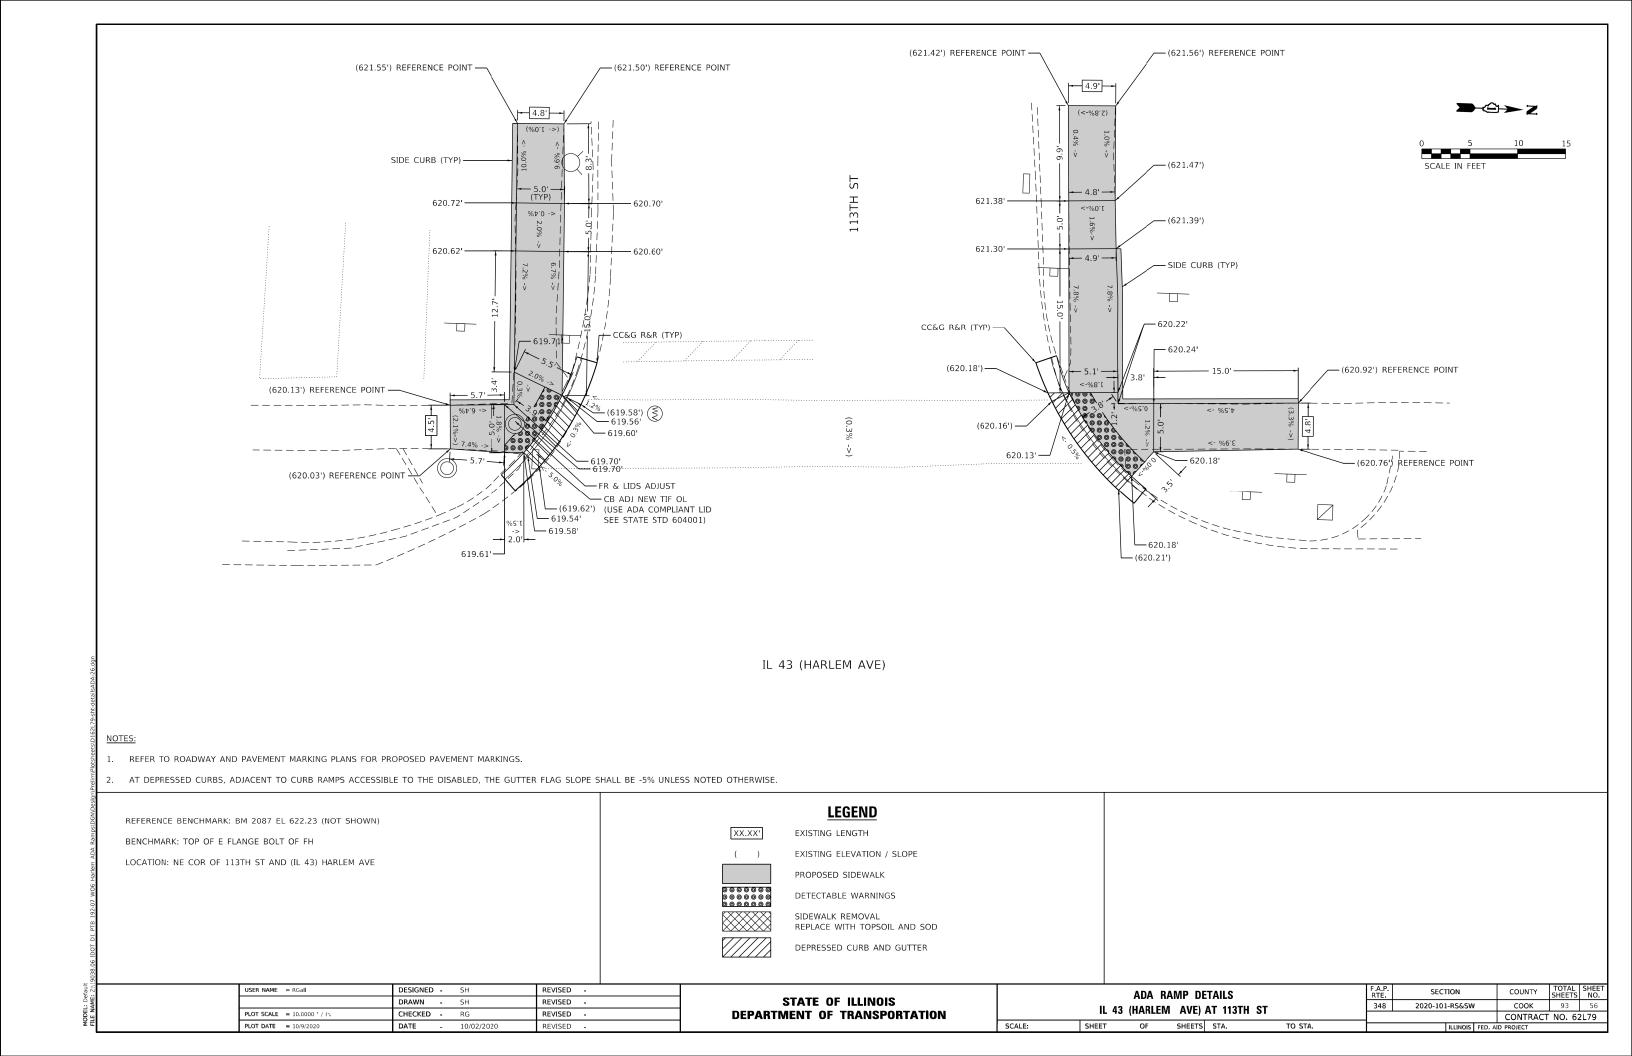
STATE OF ILLINOIS **DEPARTMENT OF TRANSPORTATION**

COUNTY TOTAL SHEET NO.

COOK 93 53 SECTION ADA RAMP DETAILS 348 2020-101-RS&SW IL 43 (HARLEM AVE) AT 114TH ST CONTRACT NO. 62L79 SCALE: SHEET OF SHEETS STA. TO STA.




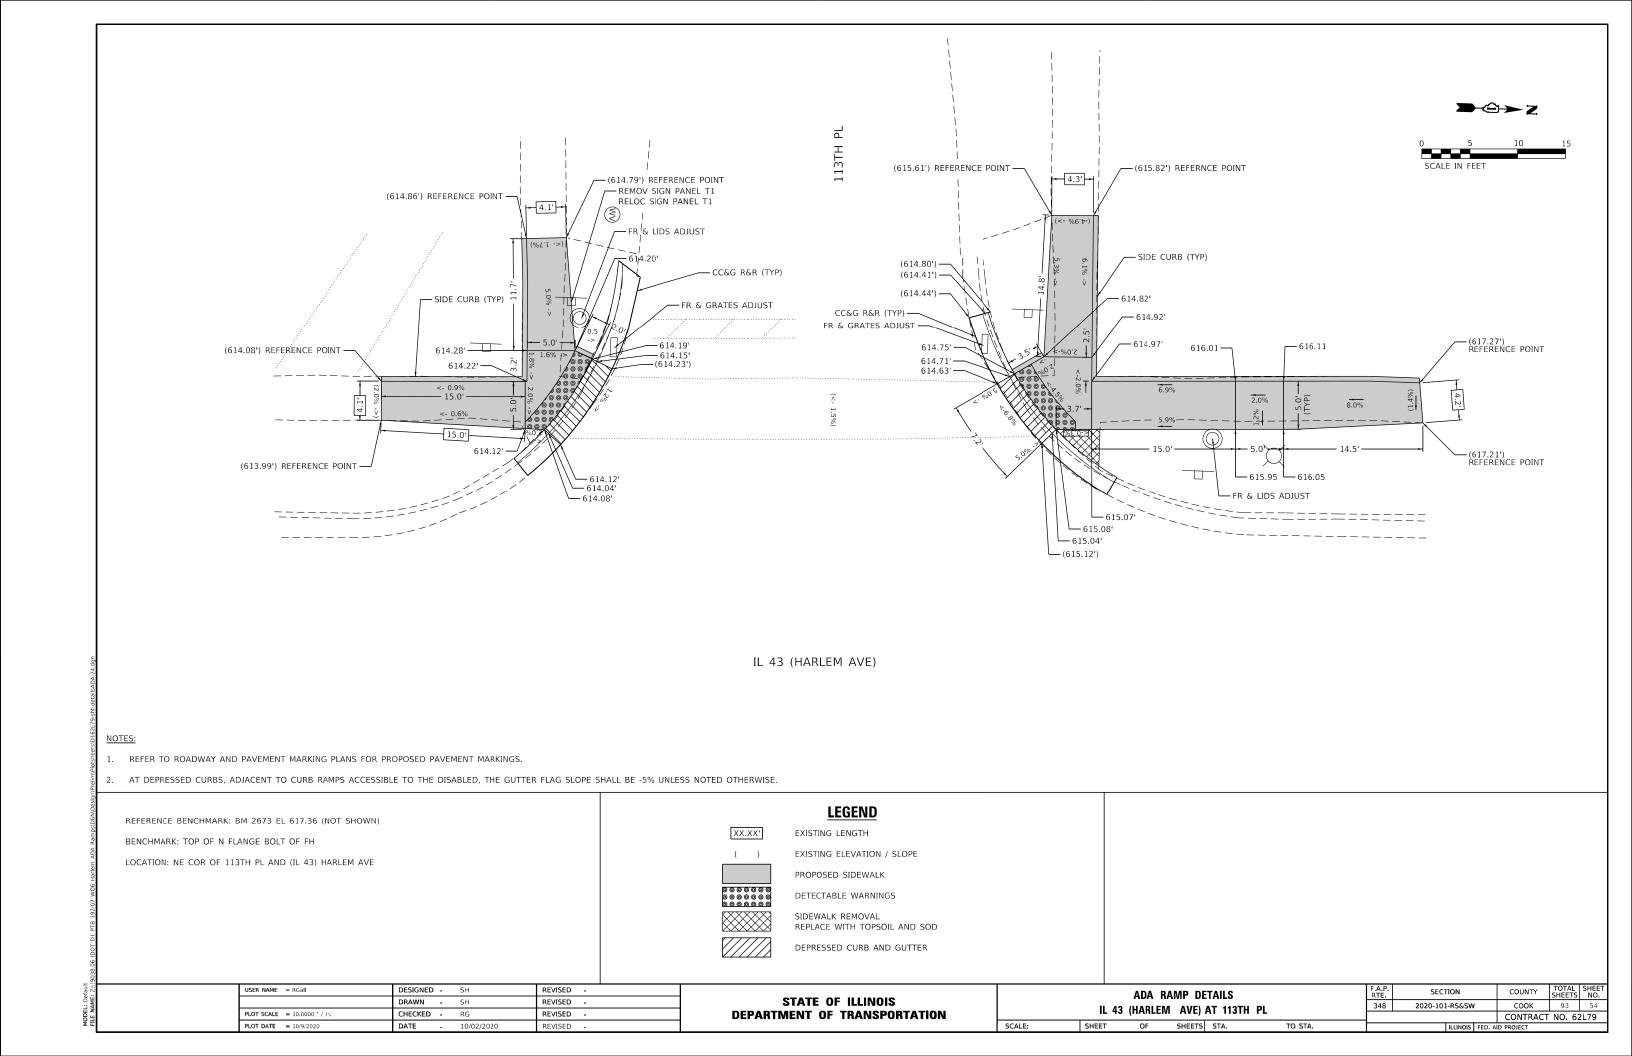

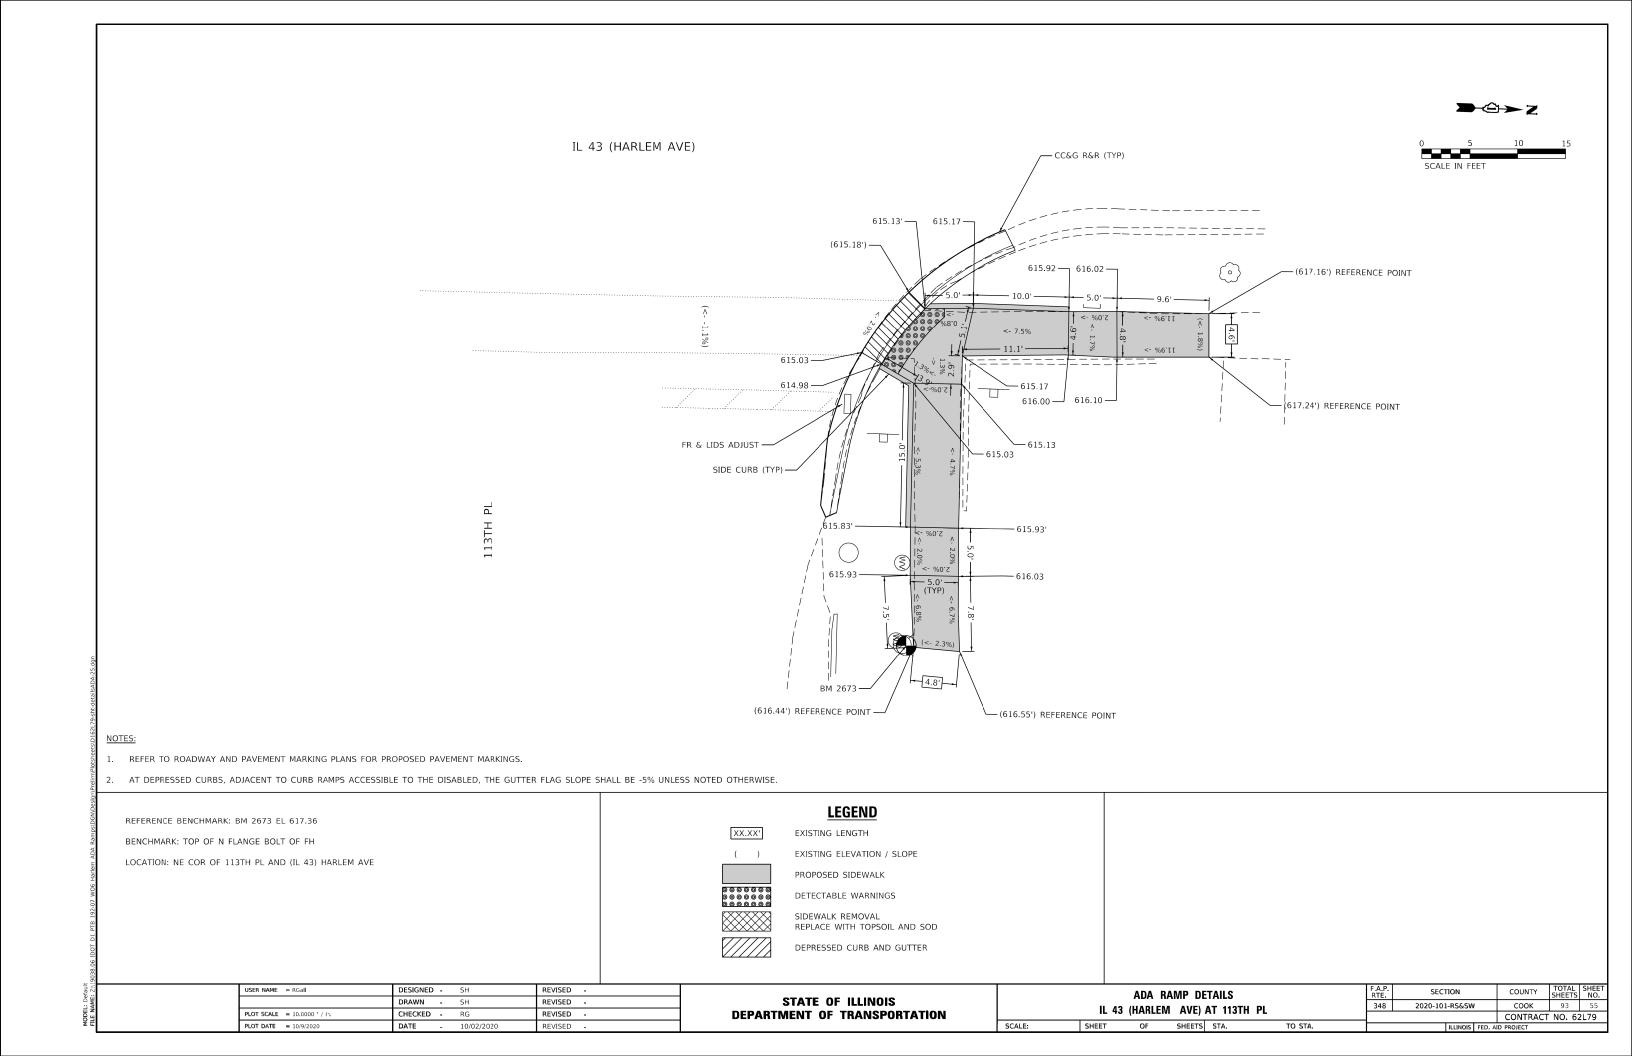

IL 43 (HARLEM AVE)



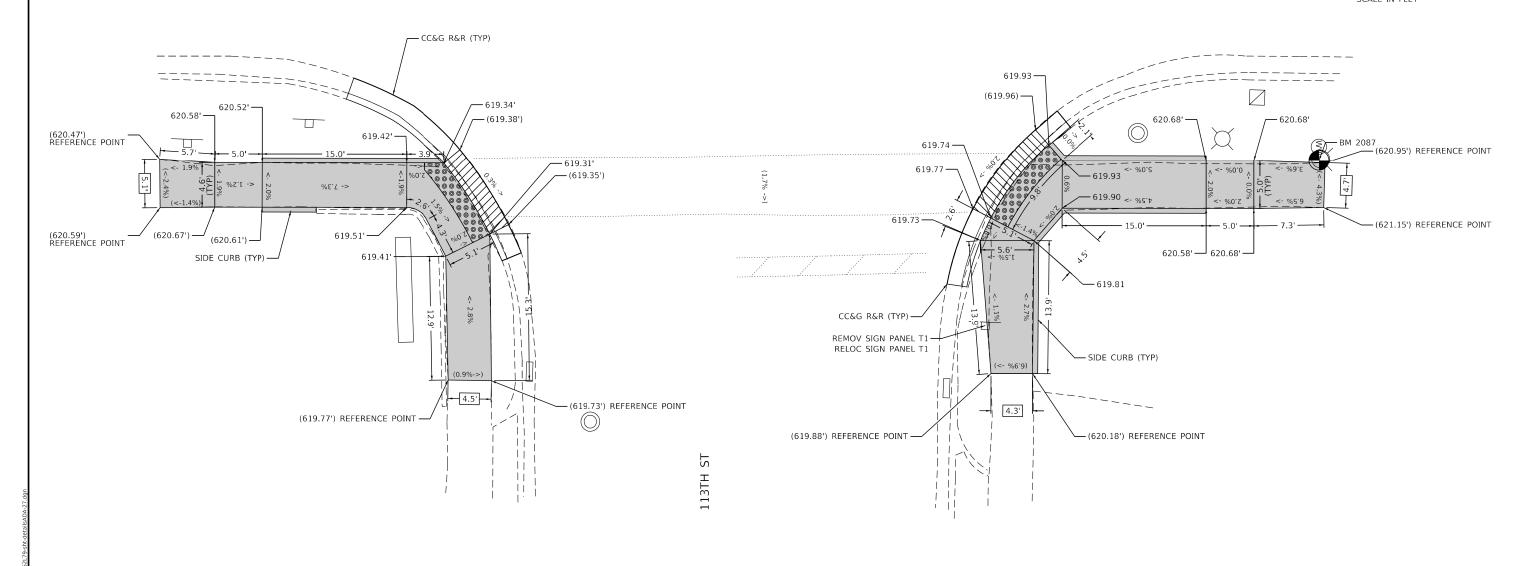

NOTES

- 1. REFER TO ROADWAY AND PAVEMENT MARKING PLANS FOR PROPOSED PAVEMENT MARKINGS.
- 2. AT DEPRESSED CURBS, ADJACENT TO CURB RAMPS ACCESSIBLE TO THE DISABLED, THE GUTTER FLAG SLOPE SHALL BE -5% UNLESS NOTED OTHERWISE.

REFERENCE BENCHMARK: BM 2087 EL 622.23

BENCHMARK: TOP OF E FLANGE BOLT OF FH

LOCATION: NE COR OF 113TH ST AND (IL 43) HARLEM AVE

PROPOSED SIDEWALK

PROPOSED SIDEWALK


DETECTABLE WARNINGS


SIDEWALK REMOVAL


REPLACE WITH TOPSOIL AND SOD

DEPRESSED CURB AND GUTTER

STATE OF ILLINOIS
DEPARTMENT OF TRANSPORTATION

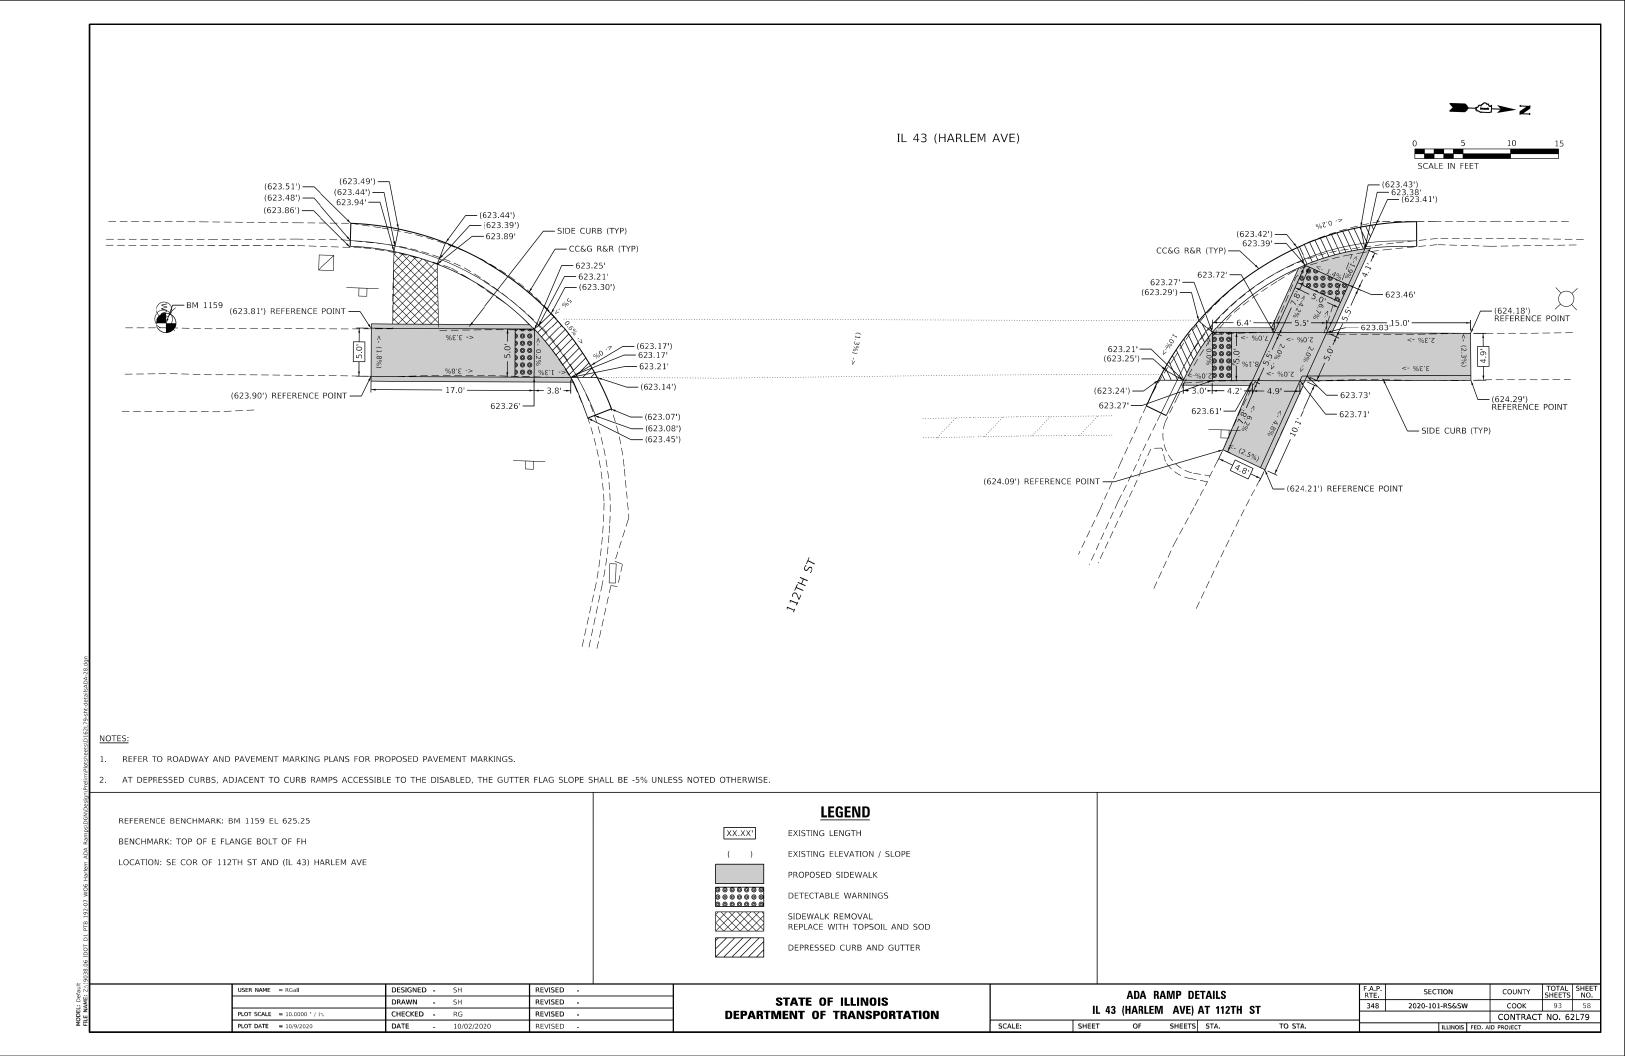

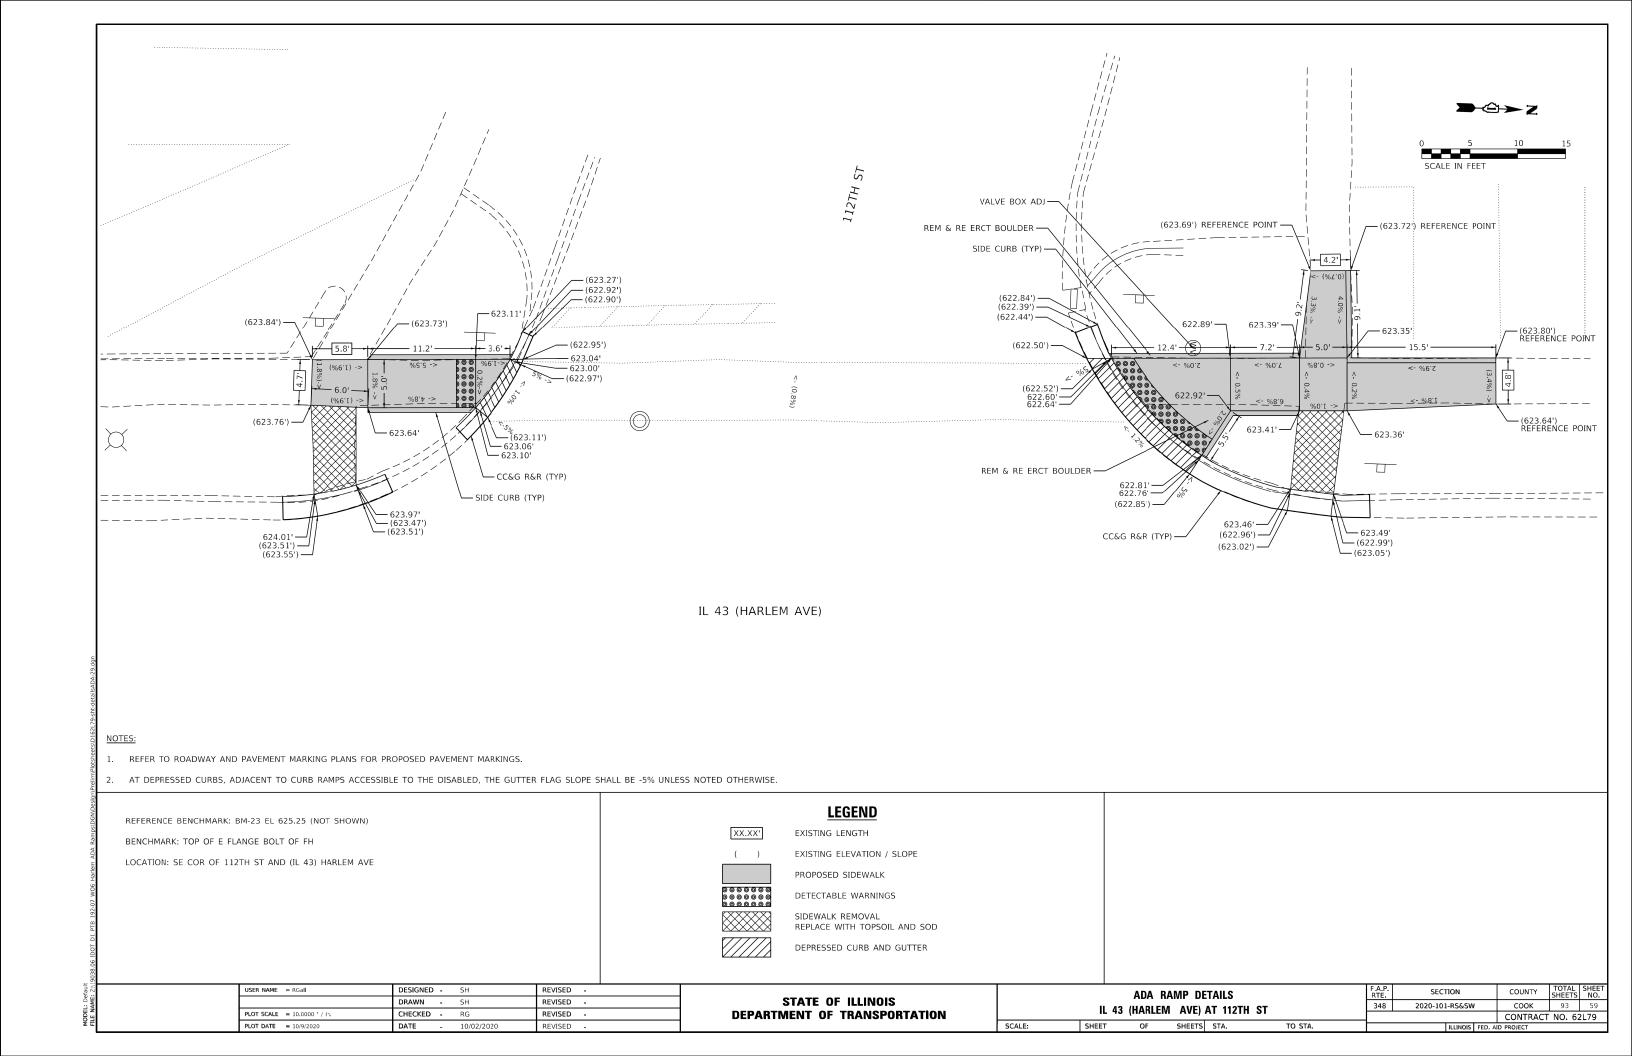

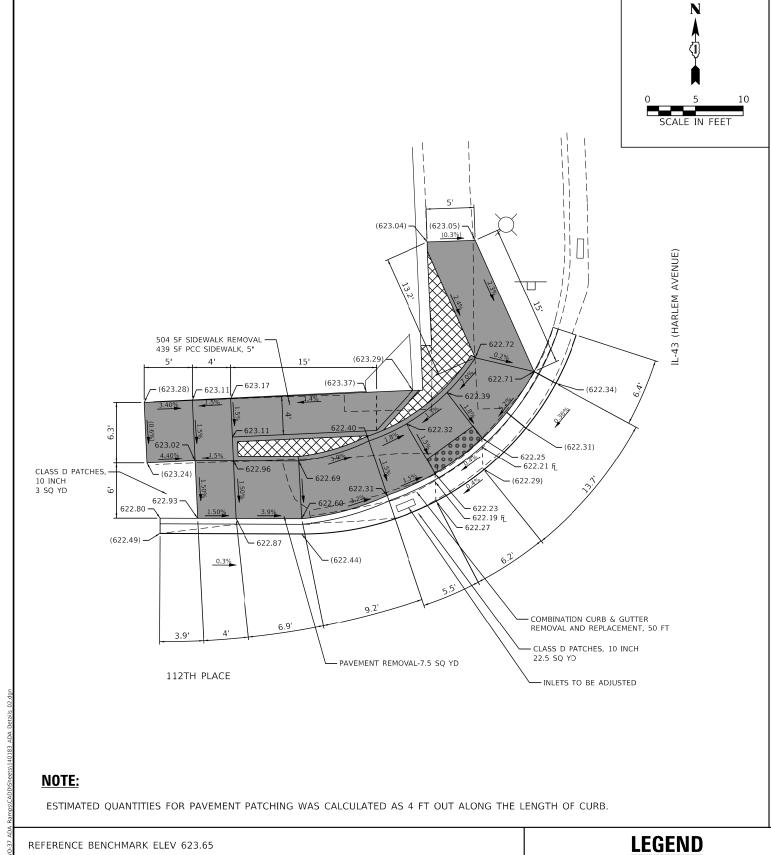

112TH PLACE (622.05) (622.37) **←** 622.00 F PAVERS - 622.04 REMOVE AND REINSTALL BRICK PAVERS, 30 SF – CLASS D PATCHES, 10 INCH 13 SQ YD 622.52 - 622.30 -(622.74) — VALVE BOXES
 TO BE ADJUSTED 622.08 - COMBINATION CURB & GUTTER REMOVAL AND REPLACEMENT, 29 FT 622.37 622.14 — (622.83) - 622.32 **— -** (**6**22.28) (622.49) 206 SF SIDEWALK REMOVAL 189 SF PCC SIDEWALK, 5"

REFERENCE BENCHMARK ELEV 623.65 BENCHMARK: TOP OF THE EAST FLANGE BOLT OF FIRE HYDRANT LOCATED AT SOUTHWEST CORNER OF 112th PLACE & HARLEM AVENUE. REFERENCE BENCHMARK ELEV 622.40

BENCHMARK: "X" ON SIDEWALK, NORTHERN: 1829074.65 EASTERN: 1130601.42

EXISTING LENGTH

PROPOSED SIDE CURB

EXISTING ELEVATION/SLOPE

PROPOSED SIDEWALK



DETECTABLE WARNINGS

SIDEWALK REMOVAL REPLACE W/ TOPSOIL & SOD REFERENCE BENCHMARK ELEV 623.65

BENCHMARK: TOP OF THE EAST FLANGE BOLT OF FIRE HYDRANT LOCATED AT SOUTHWEST CORNER OF 112th PLACE & HARLEM AVENUE.

REFERENCE BENCHMARK ELEV 622.42

BENCHMARK: "X" ON SIDEWALK, NORTHERN: 1829015.93 EASTERN: 1130602.06

BAXTER WOODMAN


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	DRAWN - MJO	REVISED -
PLOT SCALE = 10.0000 ' / in.	CHECKED - AKS	REVISED -
PLOT DATE = 10/9/2020	DATE - 10-9-20	FILE - 140183_ADA Details_02.dgn

STATE OF ILLINOIS **DEPARTMENT OF TRANSPORTATION**

	F.A.P. RTE	SECTIO				
IL-43 (H.	ARLEM	AVE) FROM	111TH TO	US 6 (159TH ST)	348	2020-101-RS
SCALE: 1"=5'	SHEET 2	OF 12	SHEETS STA.	TO STA.	_	ILL

COOK 93 60 RS&SW CONTRACT NO. 62L79

BAXTER WOODMAN Consulting Engineers

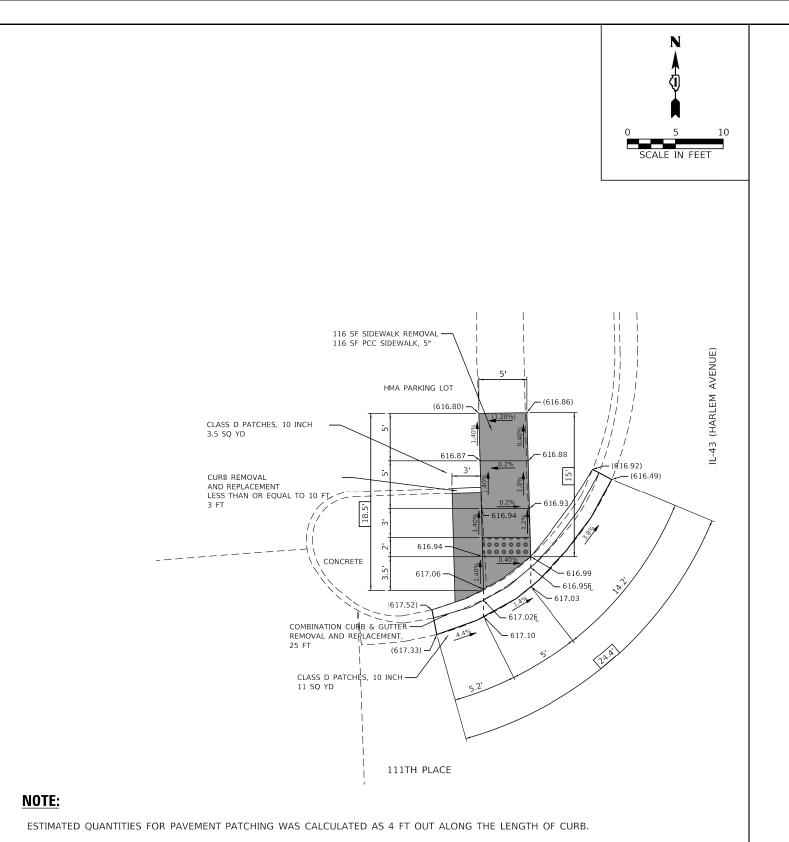

LEGEND

EXISTING LENGTH

PROPOSED SIDE CURB

PROPOSED SIDEWALK



DETECTABLE WARNINGS

SIDEWALK REMOVAL REPLACE W/ TOPSOIL & SOD

EXISTING ELEVATION/SLOPE

STATE OF ILLINOIS

ADA SIDEWALK DETAILS												
IL-43 (HARLEM AVE) FROM 111TH TO US 6 (159TH ST)												
SCALE:	1"=5'	SHEET	1 (OF	12	SHEETS	STA				TO STA.	


F.A.P. RTE	SECTIO	COUNTY	TOTAL SHEETS	SHEET NO.		
348	2020-101-RS&SW			COOK	93	61
				CONTRACT	NO. 62	2L79
	п	LLINOIS	EED. Al	ID PROJECT		


REFERENCE BENCHMARK ELEV 620.33 BENCHMARK: TOP OF THE SOUTH FLANGE BOLT OF FIRE HYDRANT LOCATED AT SOUTHWEST CORNER OF 111th PLACE & HARLEM AVENUE.

REFERENCE BENCHMARK ELEV 617.71 BENCHMARK: "X" ON SIDEWALK, NORTHERN: 1829740.84 EASTERN: 1130566.98


USER NAME = mornig DESIGNED - AKS REVISED -DRAWN - MJO REVISED -PLOT SCALE = 10.0000 ' / in CHECKED - CJC REVISED -FILE - 140183_ADA Details_01.dgn PLOT DATE = 10/9/2020 DATE


DEPARTMENT OF TRANSPORTATION

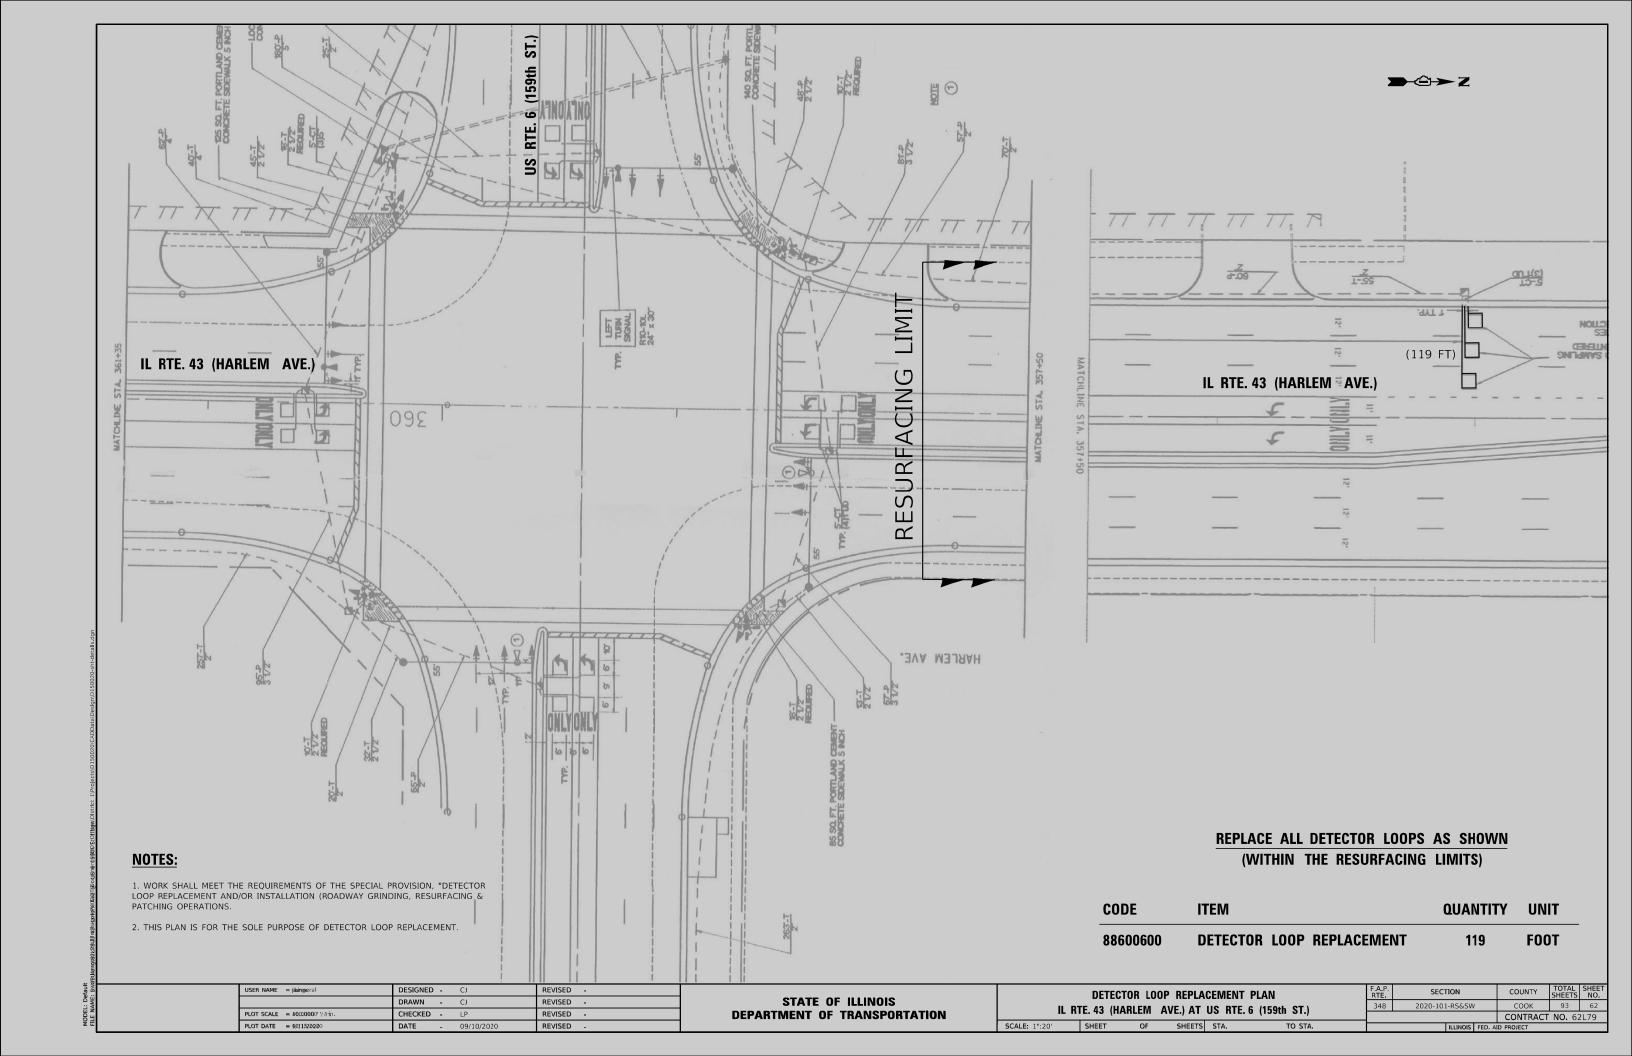


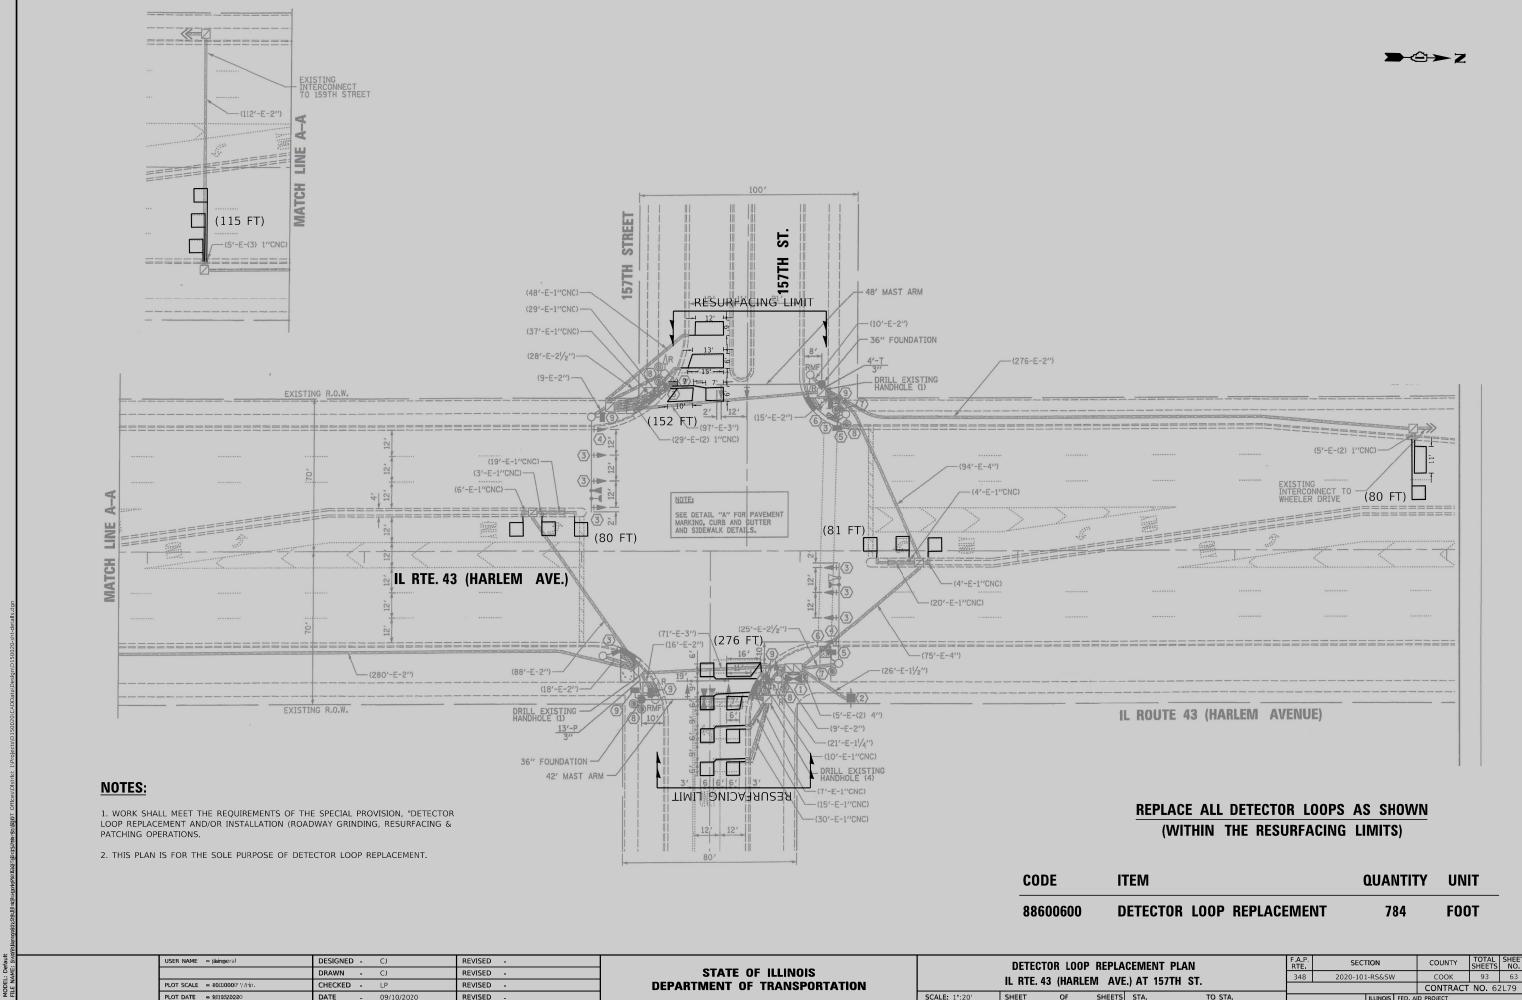



OF SHEETS STA.

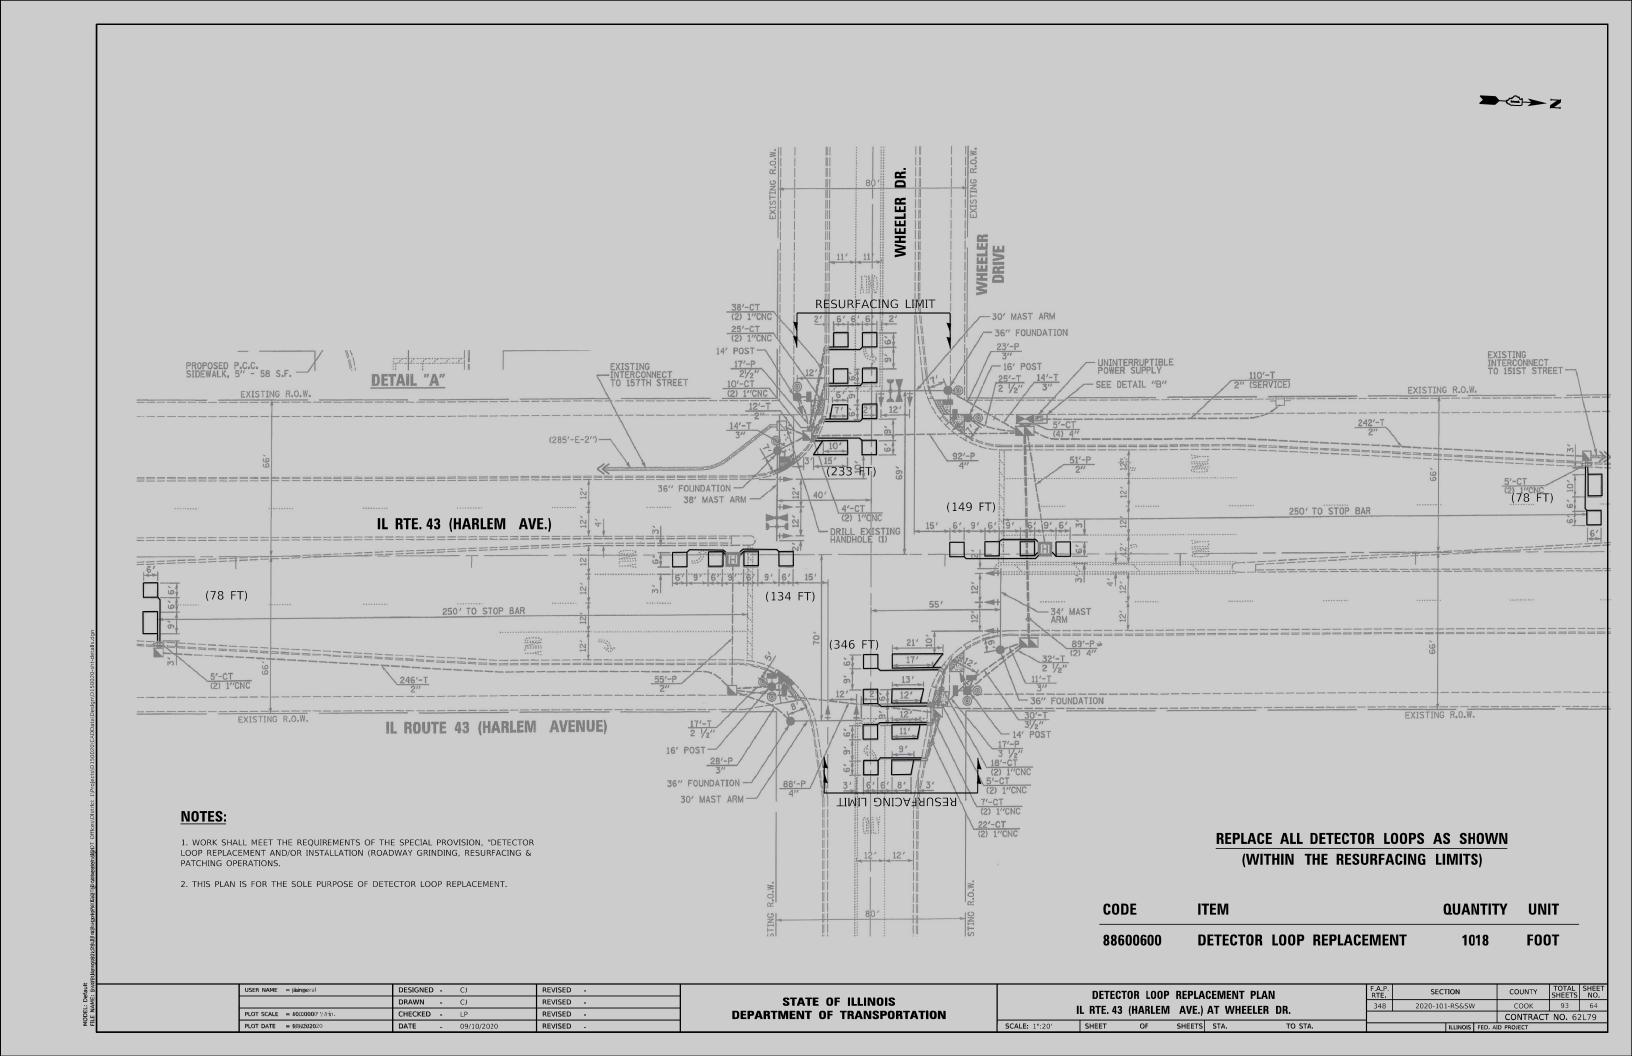


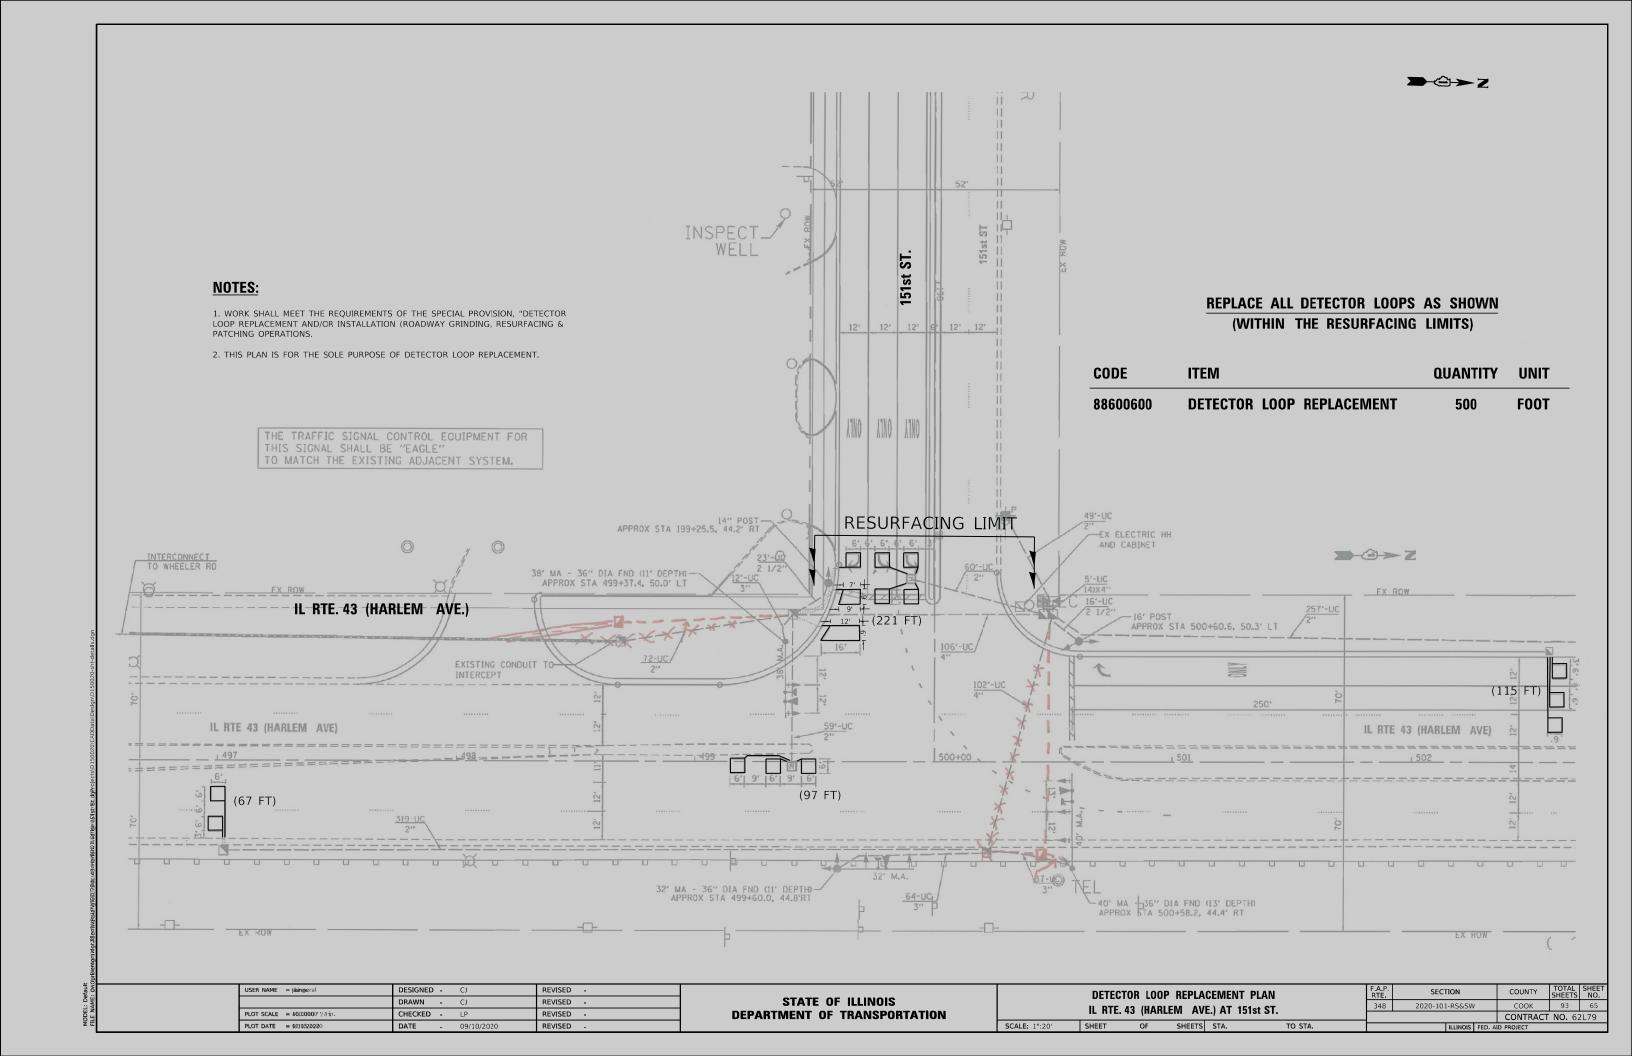

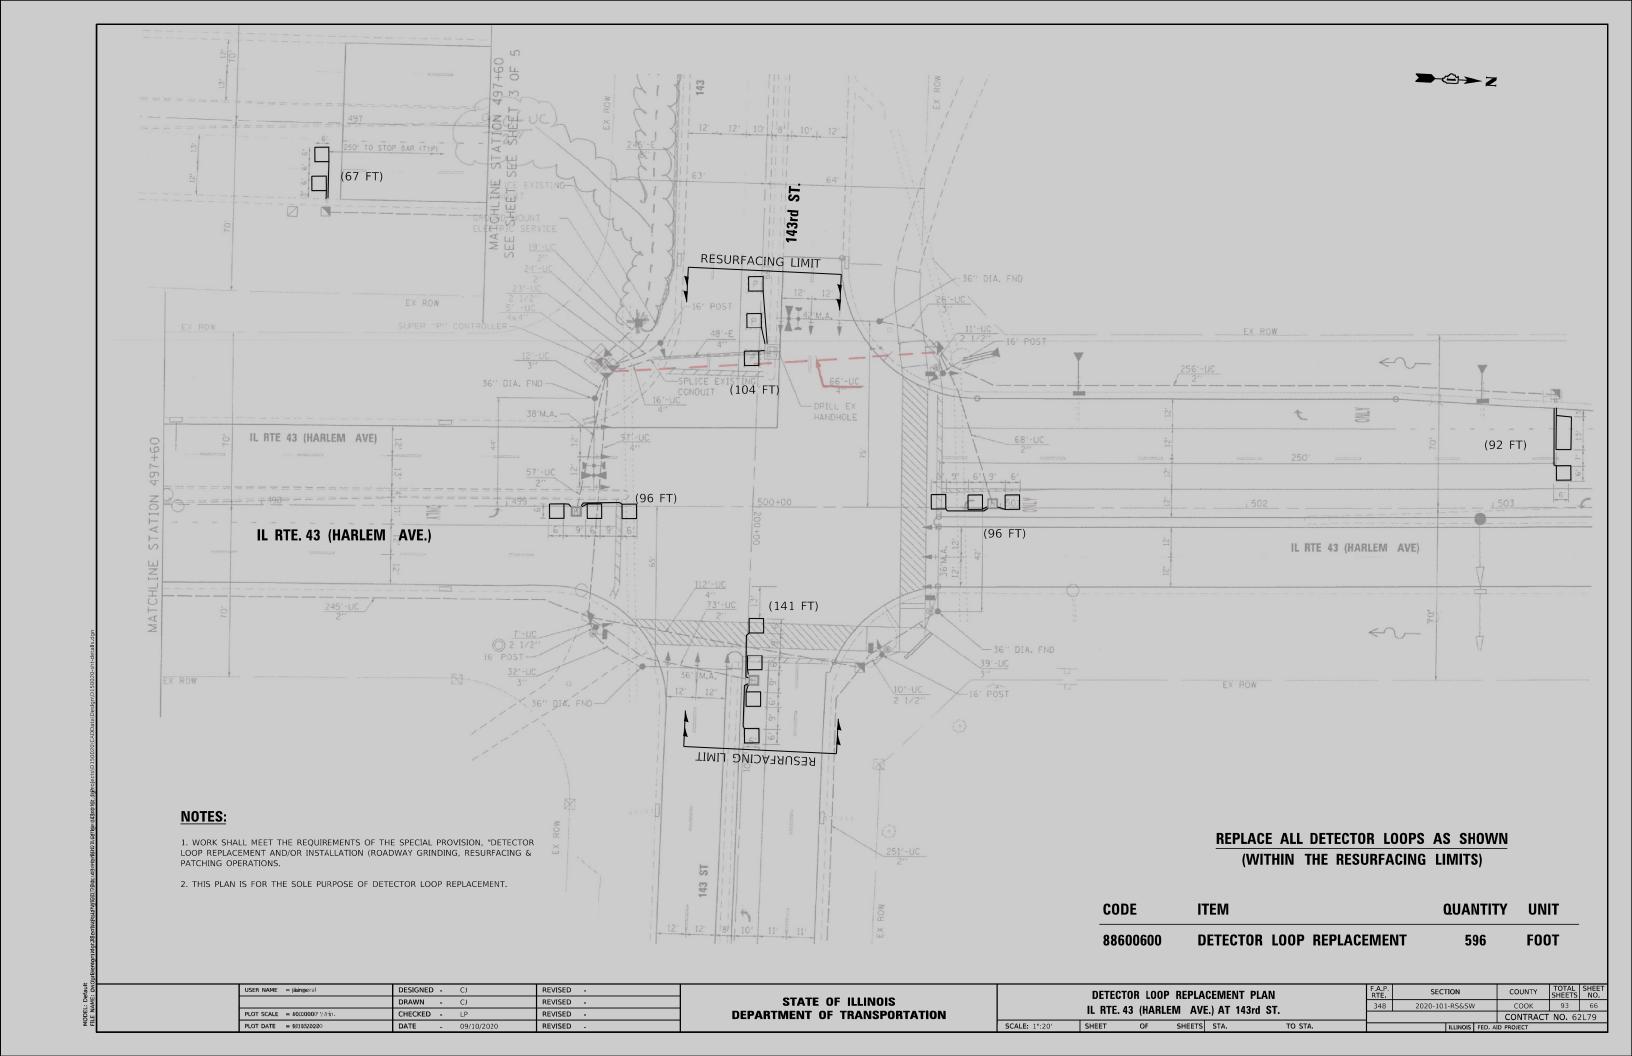

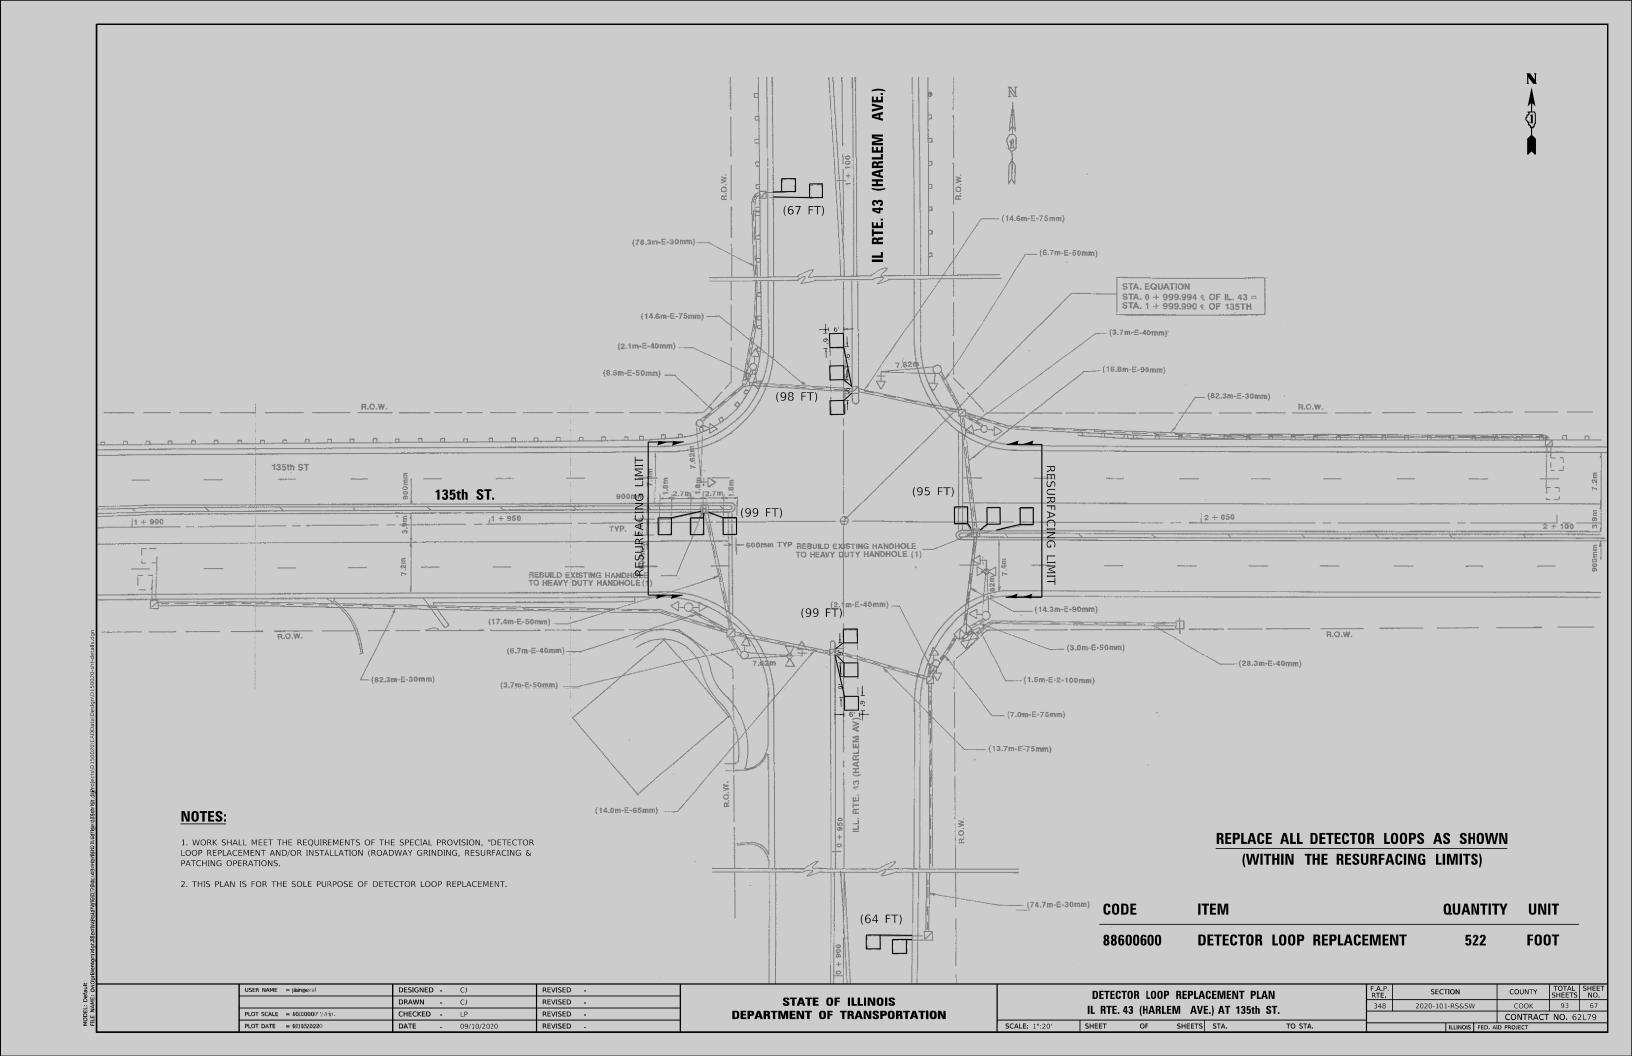

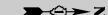

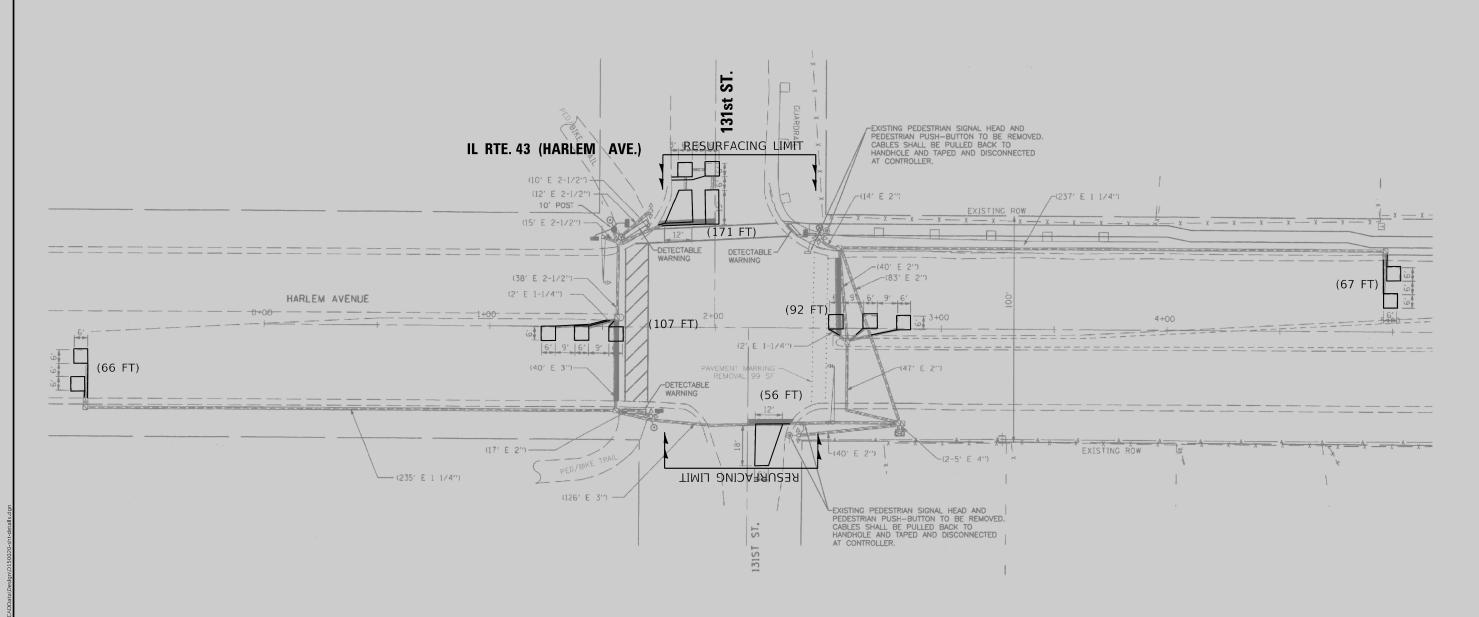

NOTES:


1. WORK SHALL MEET THE REQUIREMENTS OF THE SPECIAL PROVISION, "DETECTOR LOOP REPLACEMENT AND/OR INSTALLATION (ROADWAY GRINDING, RESURFACING & PATCHING OPERATIONS.

2. THIS PLAN IS FOR THE SOLE PURPOSE OF DETECTOR LOOP REPLACEMENT.


(WITHIN THE RESURFACING LIMITS)


CODE	ITEM	QUANTITY	UNIT
88600600	DETECTOR LOOP REPLACEMENT	559	FOOT


	USER NAME = şikingerəl	DESIGNED - CJ	REVISED -		DETECTOR LOOP REPLACEMENT PLAN					F.A.P. RTE	SECTION	COUNTY	TOTAL	SHEET	
		DRAWN - CJ	REVISED -	STATE OF ILLINOIS DEPARTMENT OF TRANSPORTATION					348	2020-101-RS&SW	соок	93	68		
	PLOT SCALE = 40000000' //inn.	CHECKED - LP	REVISED -		IL RTE. 43 (HARLEM AVE.) AT 131st ST.								CONTRACT NO. 62L79		
	PLOT DATE = 90105200200	DATE - 09/10/2020	REVISED -		SCALE: 1":20'	SHEET	OF	SHEETS	STA.	TO STA.		ILLINOIS FED, A	ID PROJECT		

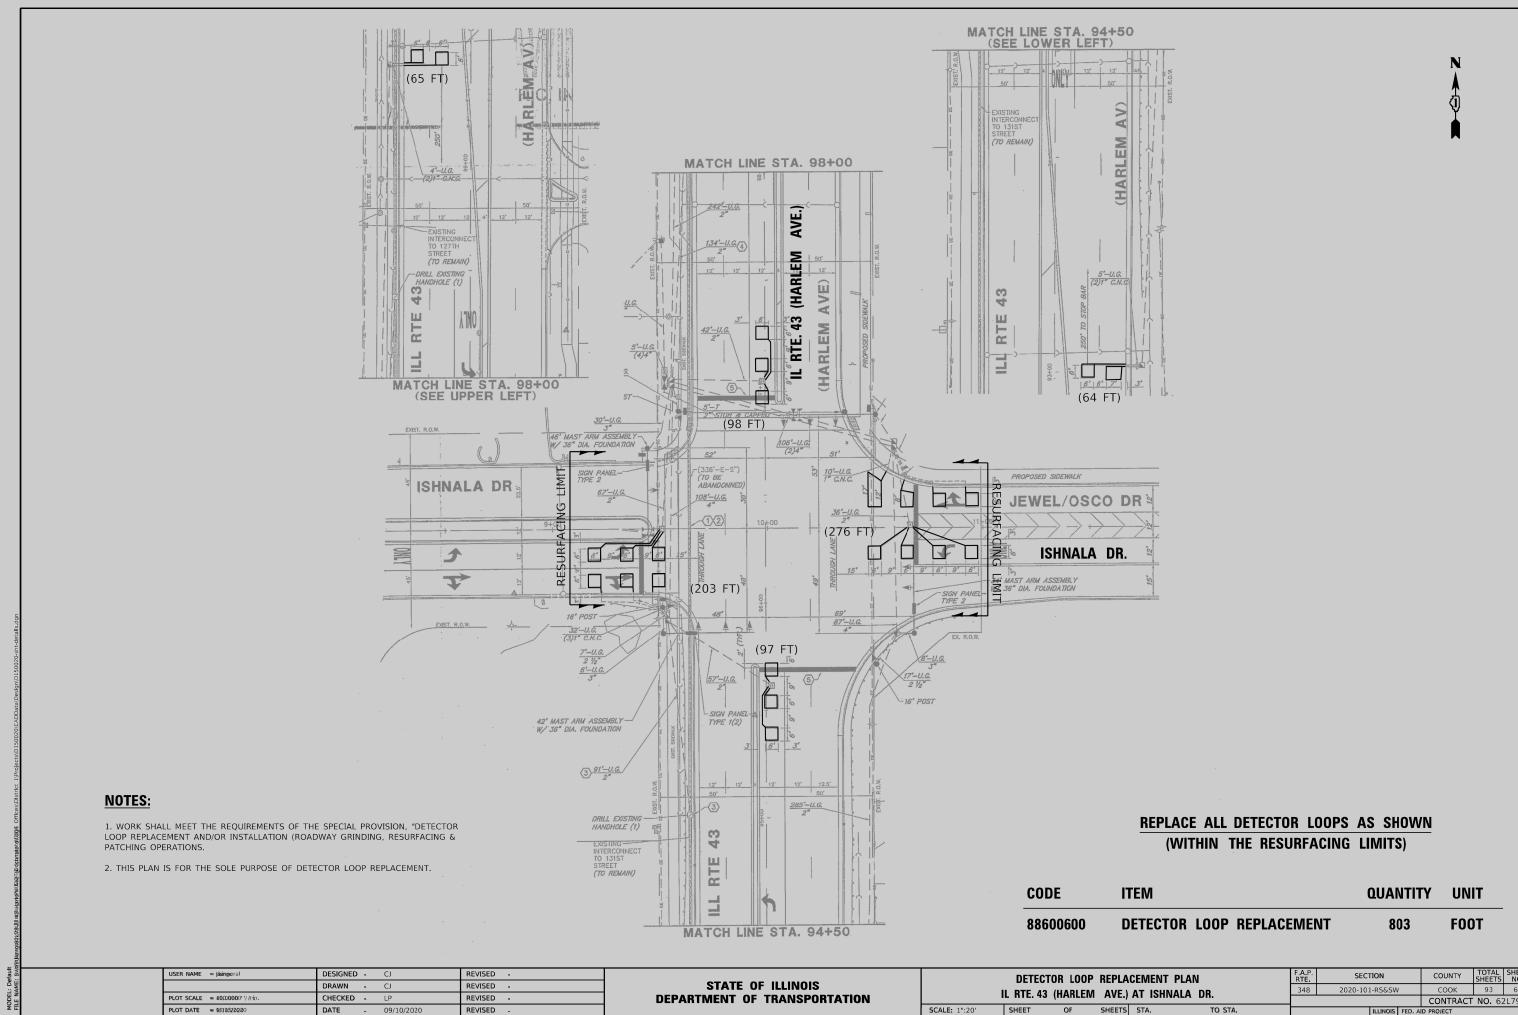



COOK 93 69 CONTRACT NO. 62L79

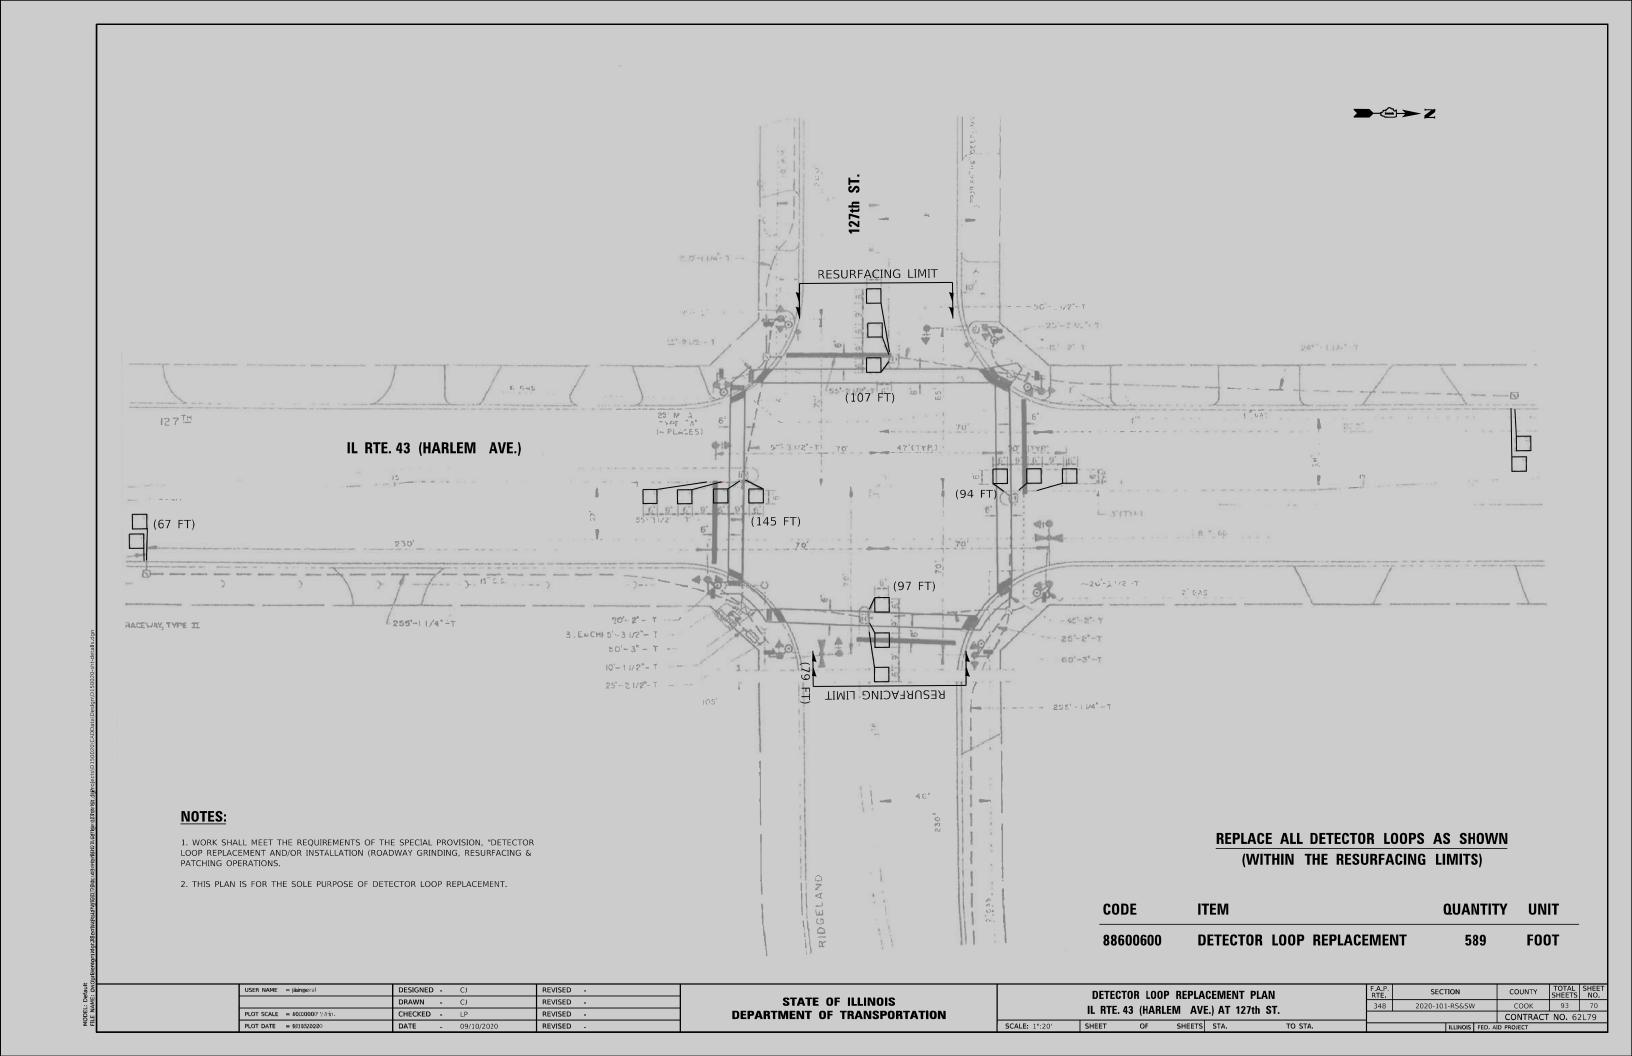


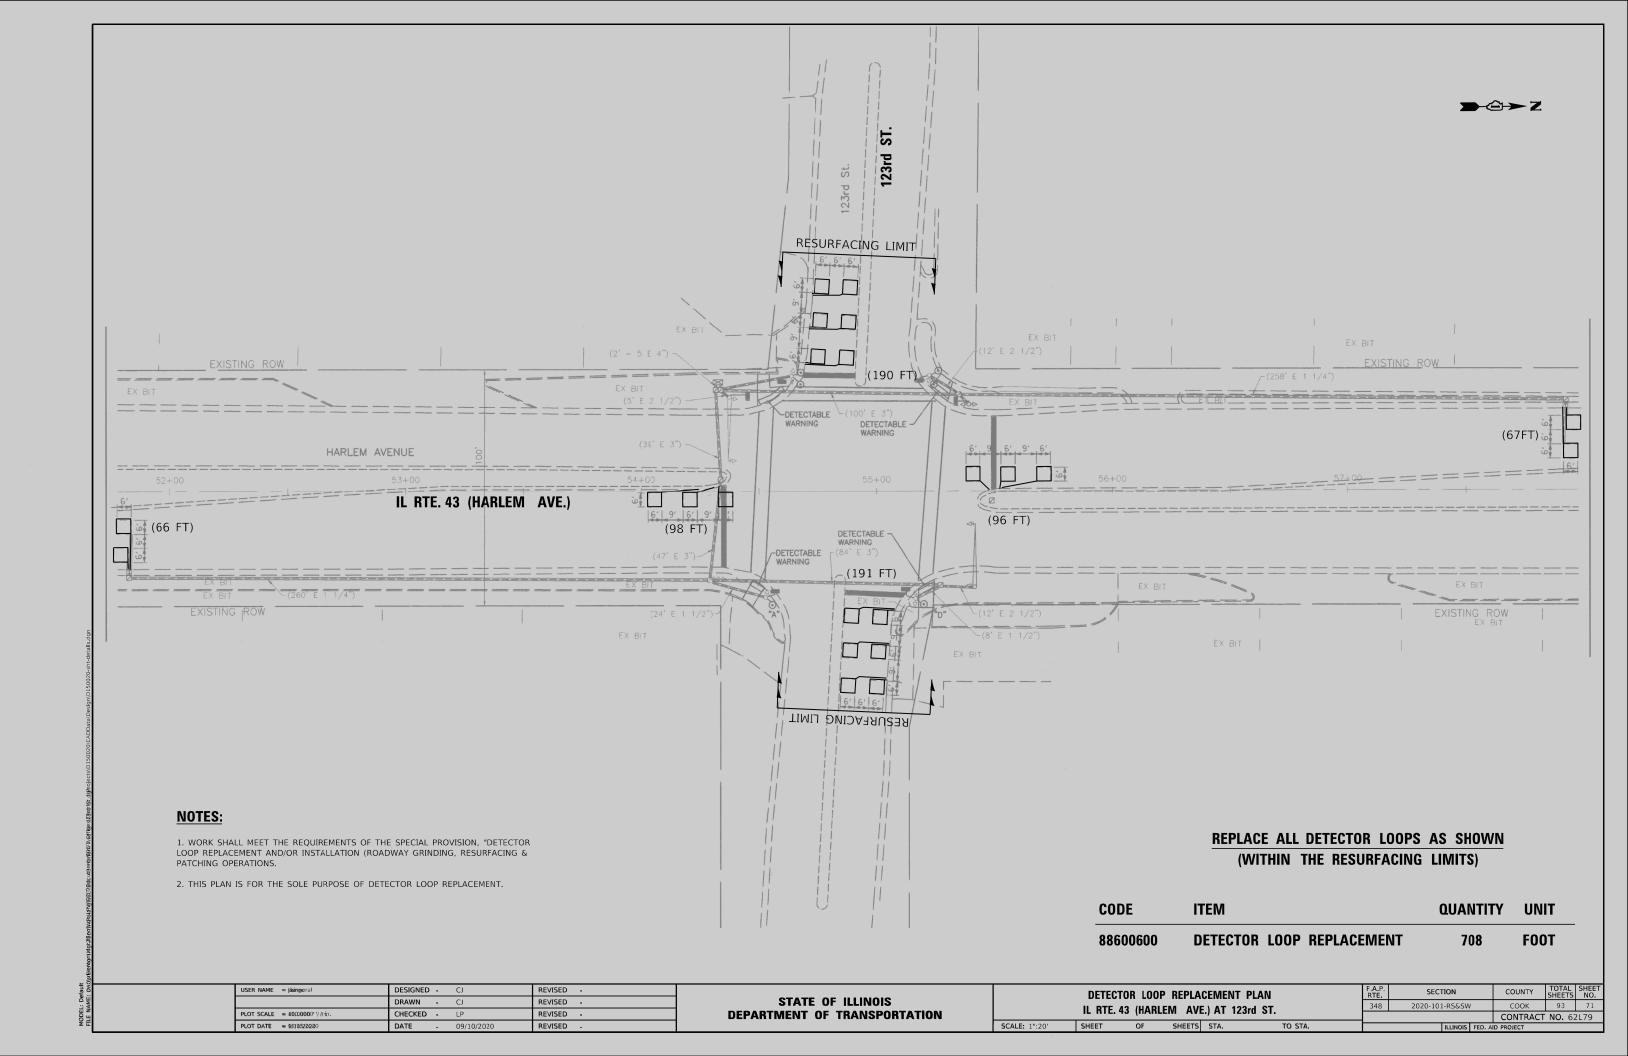


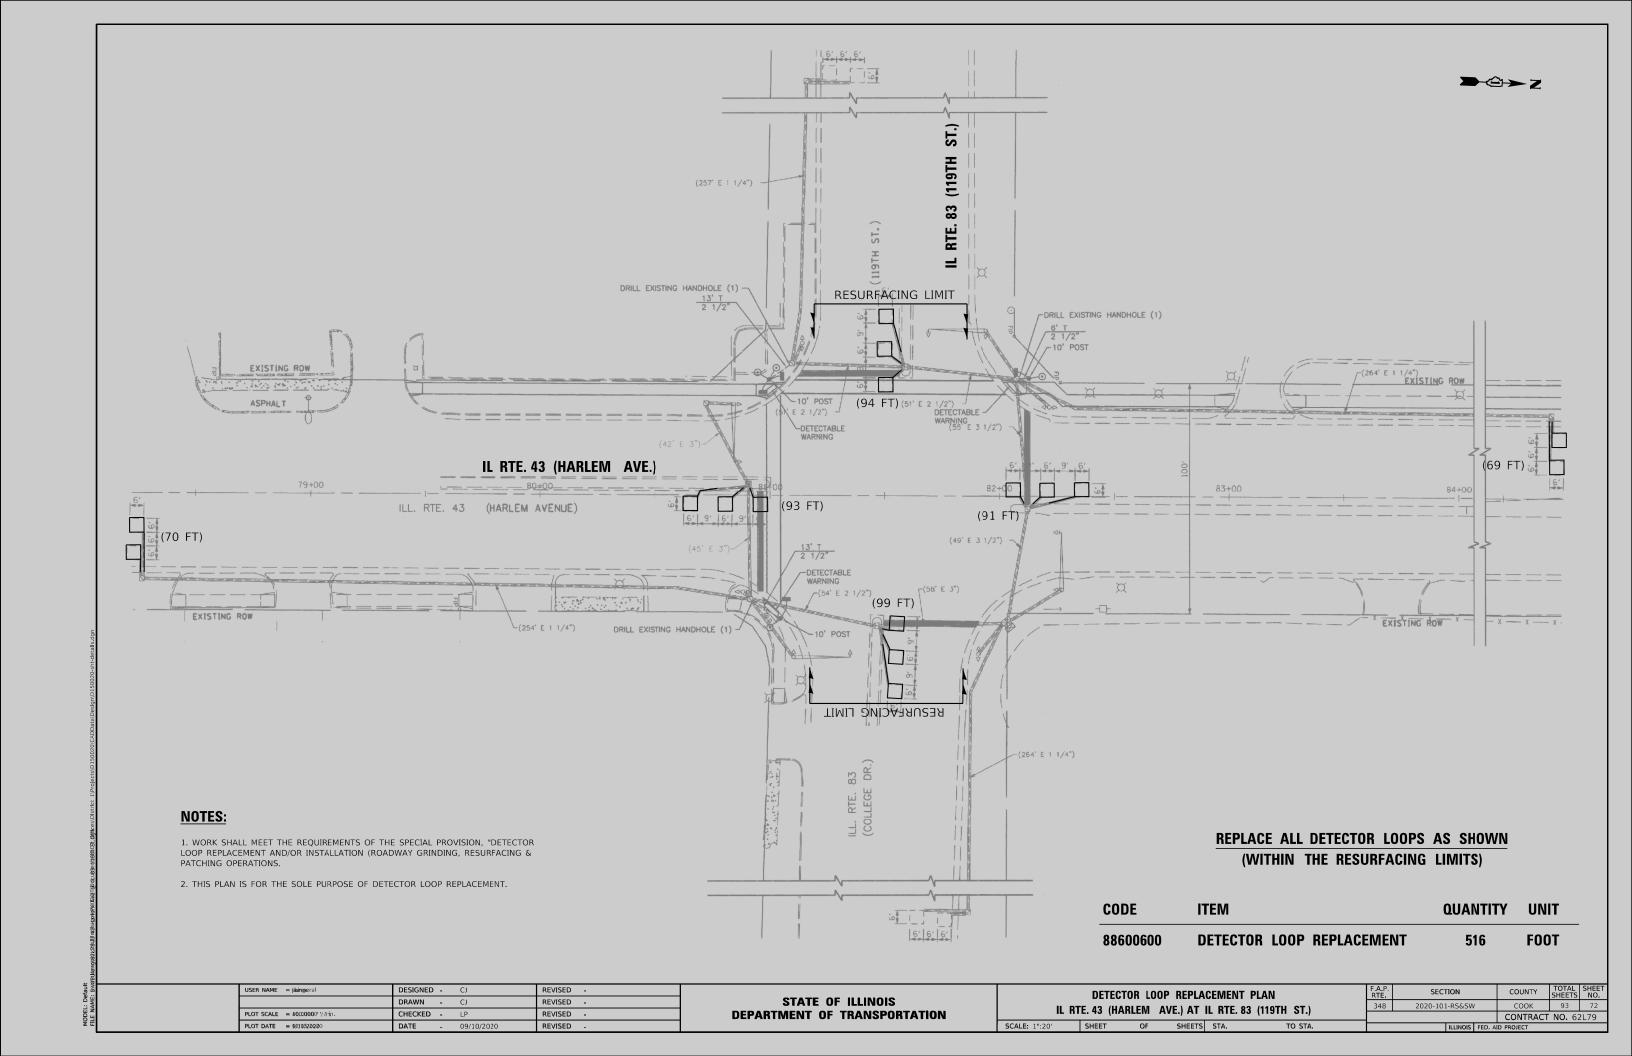


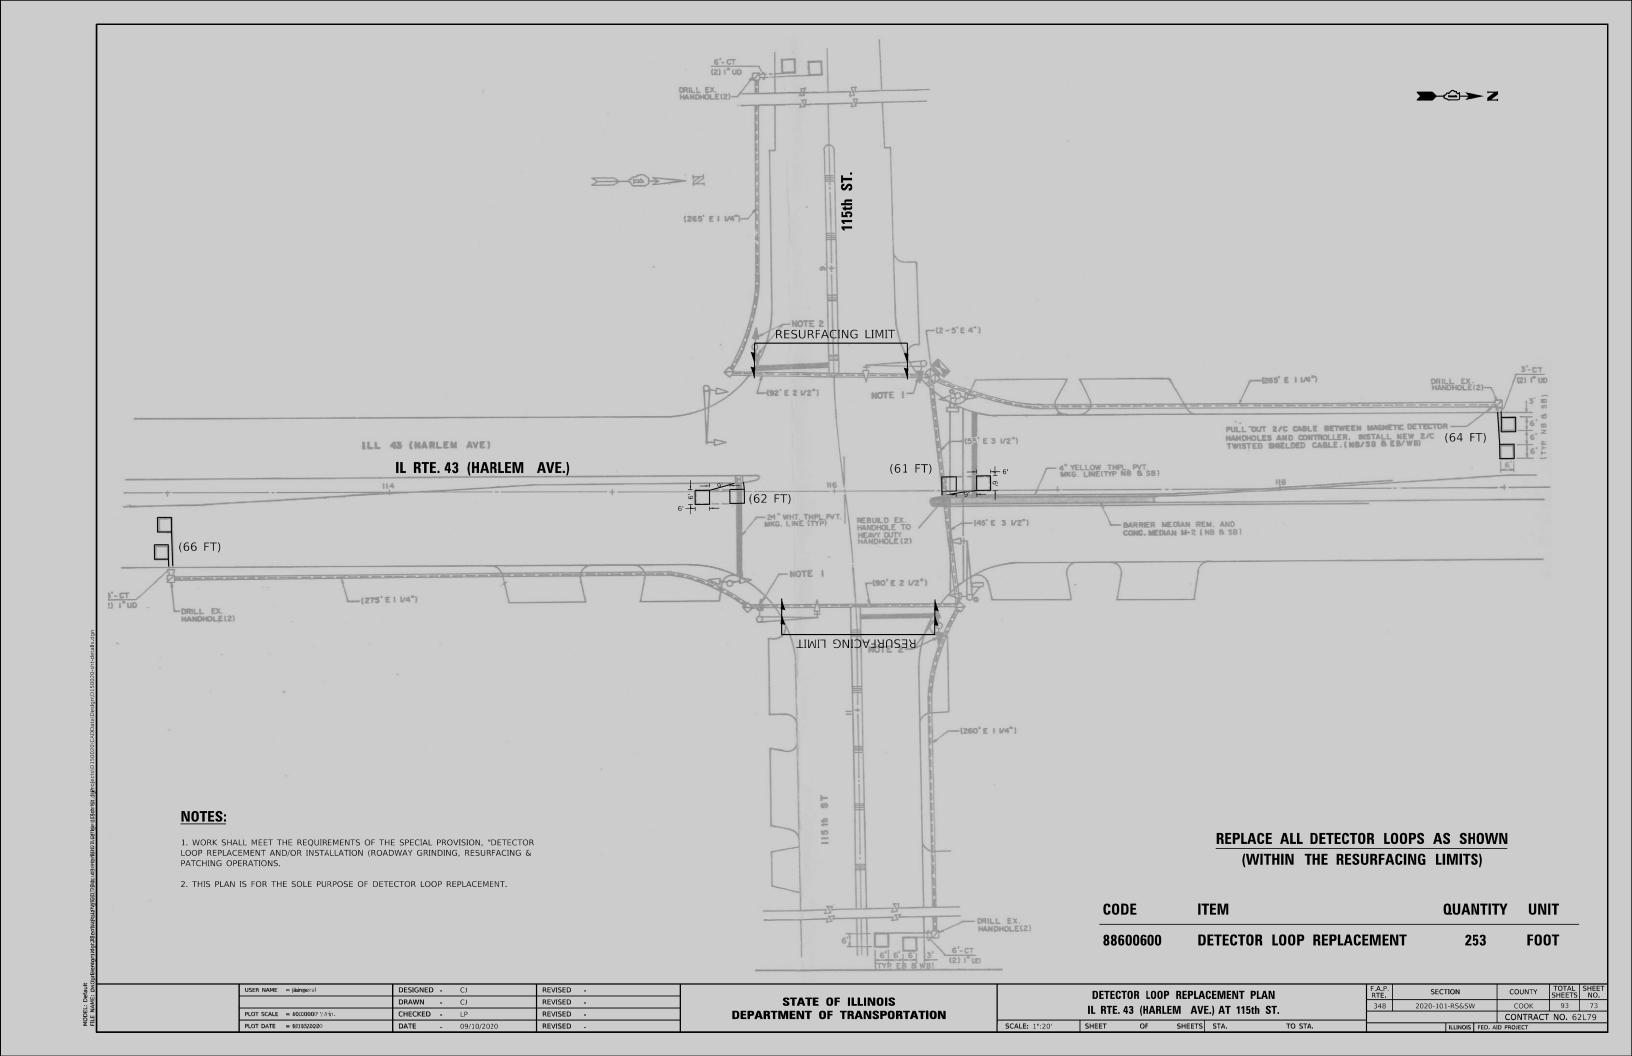

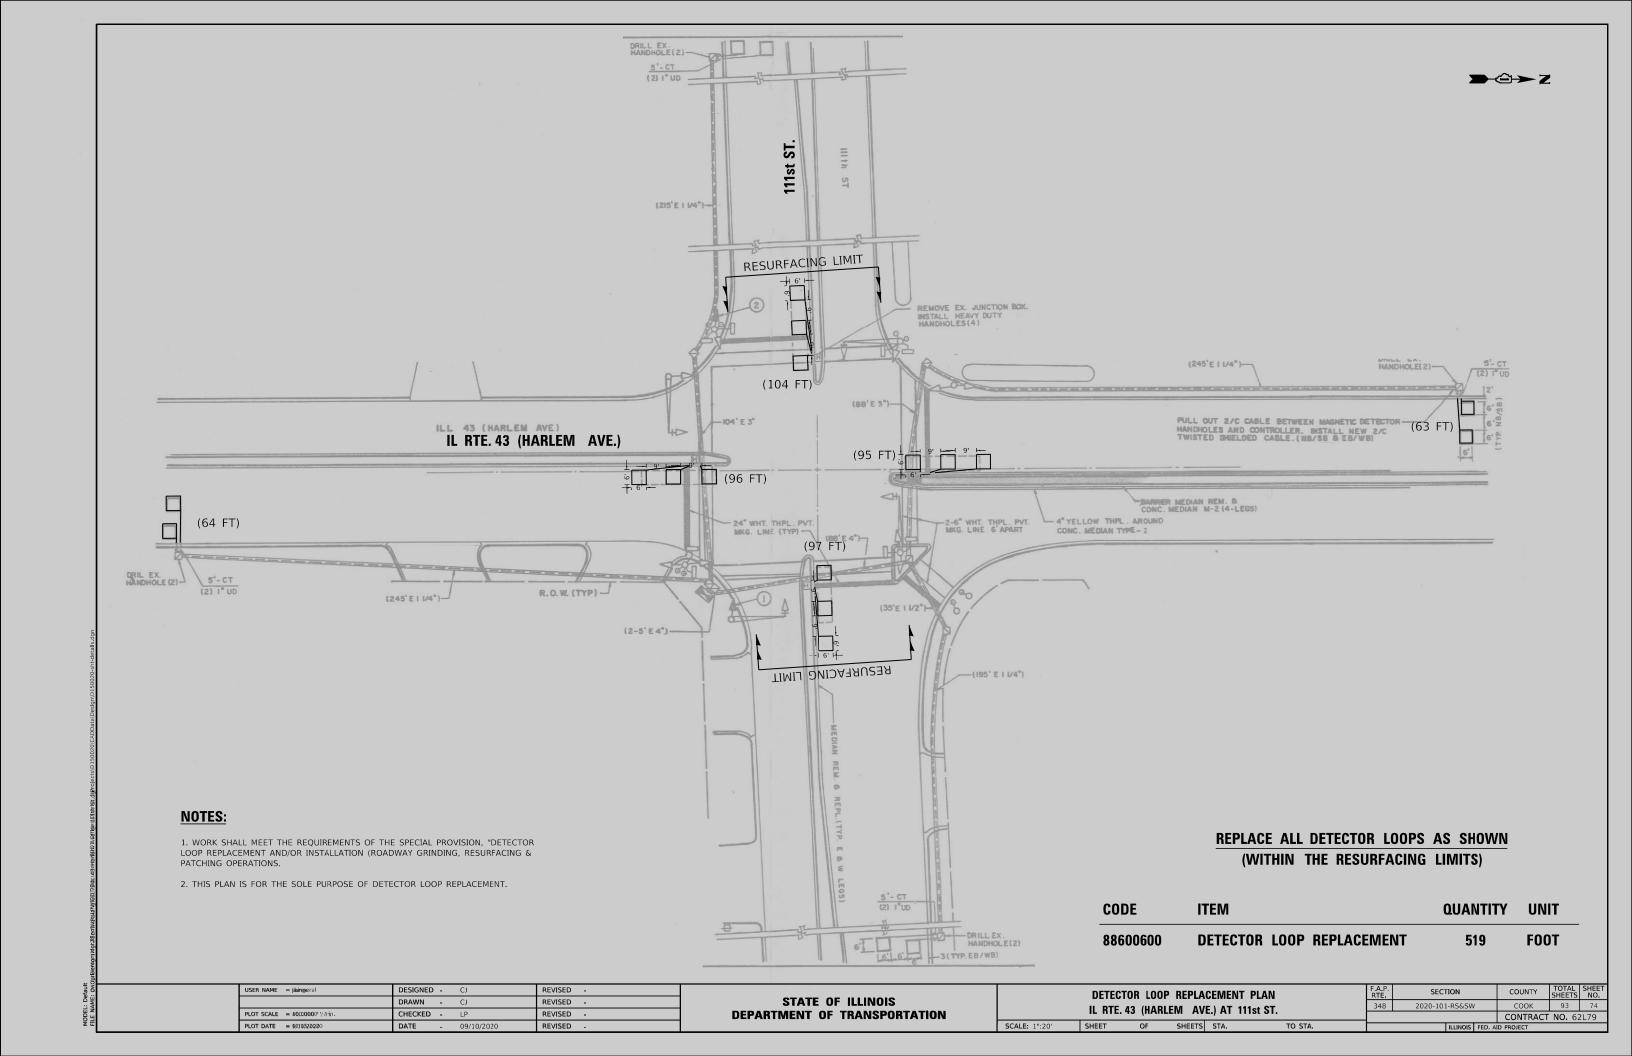

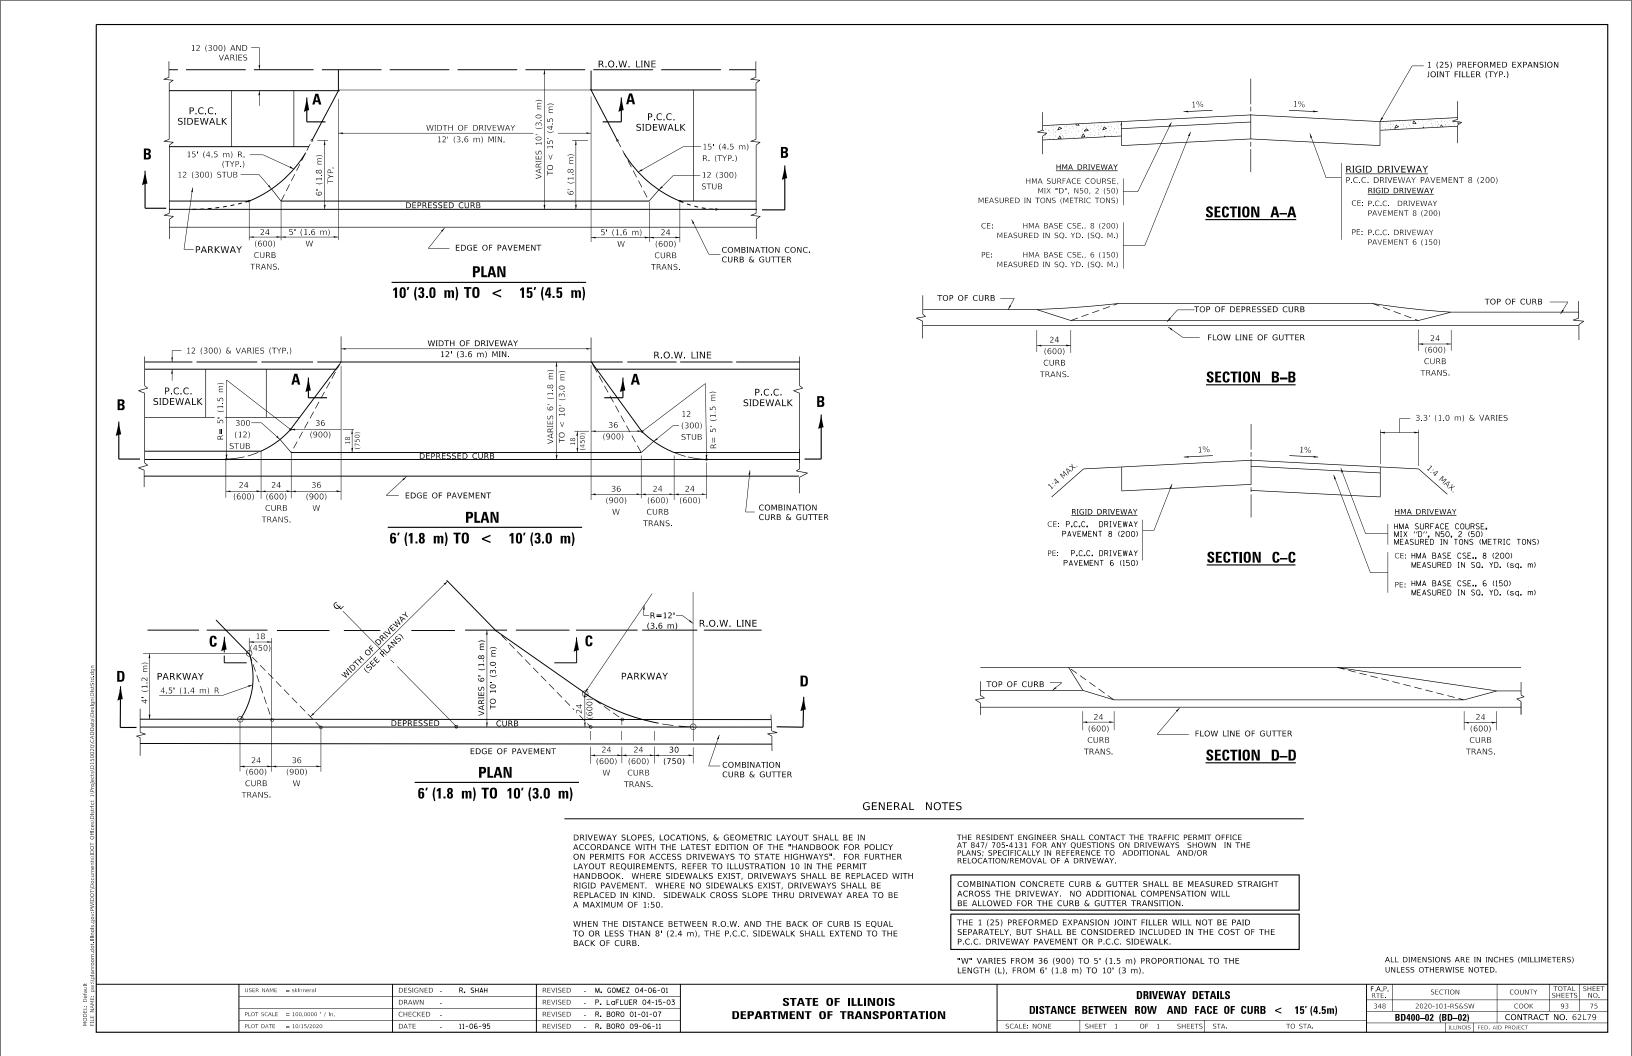

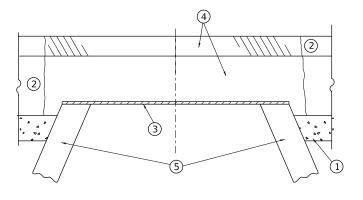

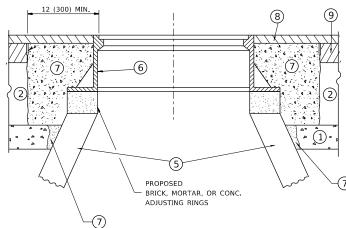

NOTES

EXISTING BROKEN FRAMES AND LIDS SHALL BE REMOVED AND DISPOSED OF BY THE CONTRACTOR AND SHALL BE REPLACED AS DIRECTED BY THE ENGINEER. REPLACEMENT FRAMES AND LIDS WILL BE PAID FOR IN ACCORDANCE WITH ARTICLE 109.04 OF THE STANDARD SPECIFICATIONS UNLESS A SEPARATE PAY ITEM HAS BEEN PROVIDED.

IF THE EXISTING LIDS ARE OPEN, THE FRAME WILL BE ADJUSTED TO THE ELEVATION OF THE MILLED PAVEMENT SURFACE PRIOR TO THE MILLING OPERATION. THE FRAME WILL NOT BE REMOVED AND COVERED BY THE METAL PLATE.

CITY OF CHICAGO CASTINGS ARE THE PROPERTY OF THE CITY AND THE CONTRACTOR SHALL NOTIFY THE CITY FOR REMOVAL AND DISPOSITION OF THE CASTINGS.

THE METAL PLATE USED TO COVER THE STRUCTURE SHALL REMAIN THE PROPERTY OF THE CONTRACTOR.

WHEN STRUCTURES ARE TO BE ADJUSTED OR RECONSTRUCTED, THE LOWERING AND RAISING OF THE FRAMES AND LIDS WILL NOT BE PAID FOR SEPARATELY BUT WILL BE INCLUDED IN THE COST OF THE CORRESPONDING PAY ITEM.

CONSTRUCTION PROCEDURES

STAGE 1 (BEFORE PAVEMENT MILLING)

- A) REMOVE A MINIMUM OF 12 (300) OF THE PAVEMENT FROM AROUND THE STRUCTURE.
- B) REMOVE THE EXISTING FRAME AND LID FROM THE STRUCTURE.
- C) COVER THE STRUCTURE OPENING WITH A 36 (900) DIAMETER METAL PLATE.
- D) BACKFILL WITH CRUSHED STONE AND A MINIMUM 1½ (40)
 THICK HMA SURFACE MIX APPROVED BY THE ENGINEER.

STAGE 2 (AFTER PAVEMENT MILLING)

- A) REMOVE THE HMA SURFACE MIX AND CRUSHED STONE.
- B) INSTALL THE FRAME AND LID; ADJUST THE FRAME TO ITS FINAL SURFACE ELEVATION.
- C) THE SURROUNDING SPACE SHALL BE FILLED WITH CLASS PP-1 *
 CONCRETE TO THE ELEVATION OF THE SURFACE OF THE EXISTING
 BASE COURSE OR THE BINDER COURSE.
- f * UNLESS OTHERWISE SPECIFIED IN THE PLANS.

THE PROCEDURE EXPLAINED ABOVE SHALL CONFORM TO THE APPLICABLE PORTIONS OF SECTIONS 353, 406, 602, AND 603 OF THE STANDARD SPECIFICATIONS EXCEPT THAT "THE CONTRACTOR SHALL ADJUST THE STRUCTURES TO THE FINISHED PAVEMENT ELEVATION NO MORE THAN 5 CALENDAR DAYS PRIOR TO PLACEMENT OF THE FINAL LIFT OF SURFACE UNLESS APPROVED BY THE FINGINERE "

LEGEND

- ① SUB-BASE GRANULAR MATERIAL
- 6 FRAME AND LID (SEE NOTES)
- 2 EXISTING PAVEMENT
- (7) CLASS PP-1 *CONCRETE
- 3 36 (900) DIAMETER METAL PLATE
- 8 PROPOSED HMA SURFACE COURSE
- PROPOSED CRUSHED STONE AND HMA SURFACE MIX
- (5) EXISTING STRUCTURE
- PROPOSED HMA BINDER COURSE

LOCATION OF STRUCTURES

THE CONTRACTOR WILL BE REQUIRED TO KEEP A RECORD OF THE LOCATIONS OF THE BURIED STRUCTURES ACCORDING TO THE STATION AND DISTANCE LEFT OR RIGHT OF THE CENTERLINE OF PAVEMENT. UPON COMPLETION OF THE WORK, THE CONTRACTOR WILL DELIVER THE RECORD TO THE ENGINEER.

BASIS OF PAYMENT

REMOVING FRAMES AND LIDS ON DRAINAGE AND UTILITY STRUCTURES IN THE PAVEMENT PRIOR TO MILLING, AND ADJUSTING TO FINAL GRADE PRIOR TO PLACING THE SURFACE COURSE, WILL BE PAID FOR AT THE CONTRACT UNIT PRICE EACH FOR "FRAMES AND LIDS TO BE ADJUSTED (SPECIAL)."

THIS WORK WILL NOT BE PAID FOR WHEN DRAINAGE AND UTILITY STRUCTURES ARE SPECIFIED FOR PAYMENT AS STRUCTURE RECONSTRUCTION.

NEW FRAMES AND LIDS, WHEN SPECIFIED, WILL BE PAID FOR SEPARATELY.


DETAILS FOR FRAMES AND LIDS ADJUSTMENT WITH MILLING

ALL DIMENSIONS ARE IN INCHES (MILLIMETERS) UNLESS OTHERWISE SHOWN

STATE OF ILLINOIS
DEPARTMENT OF TRANSPORTATION

FRAMES AND LIDS ADJUSTMENT WITH MILLING

SHEET 1 OF 1 SHEETS STA. TO STA.

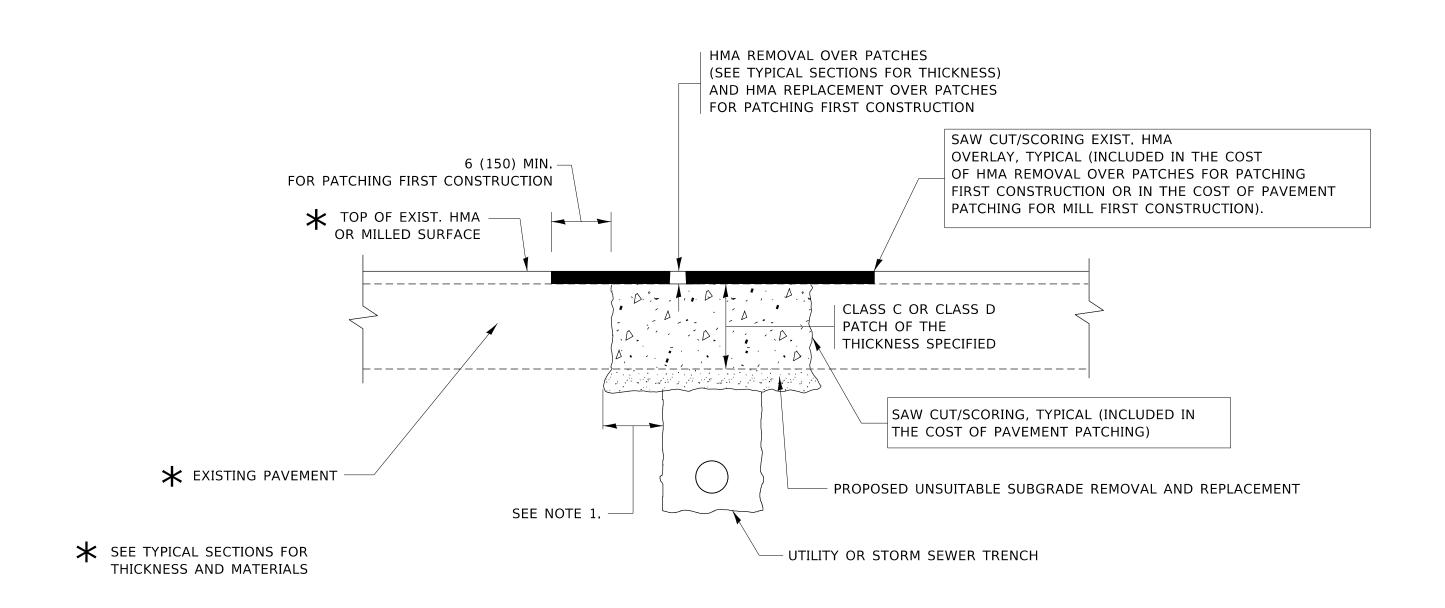

NOTES:

- 1. THE WIDTH OF THE FULL DEPTH PATCH OVER A TRENCH SHALL BE 12 (300) WIDER ON EACH SIDE OF THE TRENCH.
- 2. FOR METHOD OF MEASUREMENT AND BASIS OF PAYMENT, SEE RECURRING SPECIAL PROVISION "PATCHING WITH HOT-MIX ASPHALT OVERLAY REMOVAL".

SEQUENCE OF CONSTRUCTION (PATCHING FIRST)


- 1. REMOVE THE EXISTING HMA MATERIAL OVER THE AREA TO BE PATCHED.
- 2. REMOVE AND REPLACE WITH CLASS C OR D PATCH.
- 3. REPLACE HMA MATERIAL OVER THE AREA TO BE PATCHED.

SEQUENCE OF CONSTRUCTION (MILLING FIRST)

- 1. MILL HMA FIRST IF THERE IS AT LEAST $4\frac{1}{2}$ INCHES OR MORE OF HMA MATERIAL ON TOP OF THE EXISTING PAVEMENT OR IF THE PAVEMENT IS FULL DEPTH HMA. A MINIMUM OF 2 INCHES OF HMA MATERIAL SHALL BE IN PLACE AFTER MILLING.
- 2. REMOVE AND REPLACE WITH FULL DEPTH CLASS D PATCHES TO TOP OF MILLED SURFACE.

ALL DIMENSIONS ARE IN INCHES (MILLIMETERS) UNLESS OTHERWISE SHOWN.

USER NAME = SKINNERAL	DESIGNED - R. SHAH	REVISED - A. ABBAS 04-27-98	07475 05 114191010		PAVEMENT PATCHING FOR		RTE	SECTION	COUNTY
	DRAWN -	REVISED - R. BORO 01-01-07	STATE OF ILLINOIS		HMA SURFACED PAVEMENT		348	2020-101-RS&SW	соок
PLOT SCALE = 100.0000 / in.	CHECKED -	REVISED - R. BORO 09-04-07	DEPARTMENT OF TRANSPORTATION		HIVIA SUNFACED PAVEINIENT			BD400-04 (BD-22)	CONTRAC
PLOT DATE = 10/15/2020	DATE - 10-25-94	REVISED - K. ENG 10-27-08		SCALE: NONE SHEE	ET 1 OF 1 SHEETS STA.	TO STA.		ILLINOIS FEE	. AID PROJECT

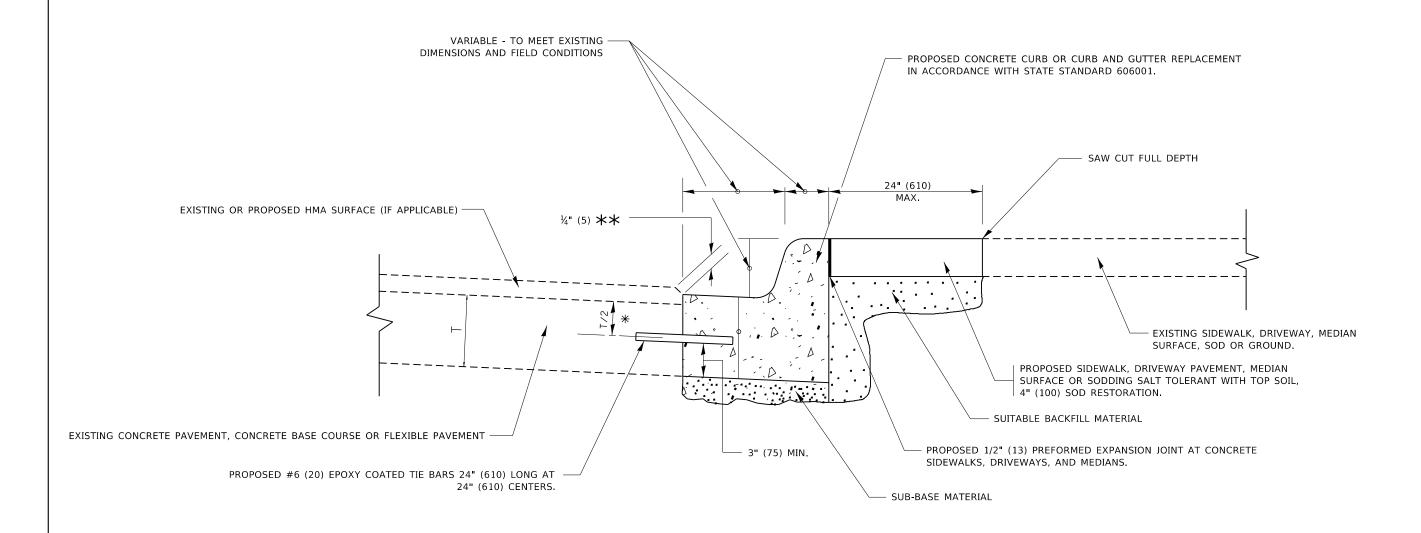

- 💥 3" (75) MINIMUM FROM TOP AND BOTTOM OF THE CONCRETE PAVEMENT OR BASE COURSE.
- $\star\star$ IF THE FINAL SURFACE OF THE PAVEMENT IS CONCRETE, THE GUTTER IS TO BE FLUSH WITH THE PAVEMENT.

CURB OR CURB AND GUTTER REMOVAL AND REPLACEMENT


ALL DIMENSIONS ARE IN INCHES (MILLIMETERS) UNLESS OTHERWISE SHOWN.

USER NAME = skinneral	DESIGNED -	A. HOUSEH	REVISED	-	A. ABBAS 03-21-97
	DRAWN -		REVISED	-	M. GOMEZ 01-22-01
PLOT SCALE = 100.0000 / in.	CHECKED -		REVISED	-	R. BORO 12-15-09
PLOT DATE = 10/15/2020	DATE -	03-11-94	REVISED	-	K. SMITH 07-11-19

STATE OF ILLINOIS
DEPARTMENT OF TRANSPORTATION


SCALE: NONE

CURB OR CURB AND GUTT	ER	F.A.P. RTE	SECTION	COUNTY TOTAL SHEETS		SHEET NO.
REMOVAL AND REPLACEME	NIT	348	2020-101-RS&SW	соок	93	78
HEINIOVAL AND HEI LAGEINE			BD600-06 (BD-24)	CONTRACT	NO. 62	2L79
1 OF 1 SHEETS STA.	OF 1 SHEETS STA. TO STA. ILLINOIS FED. A			ID PROJECT		

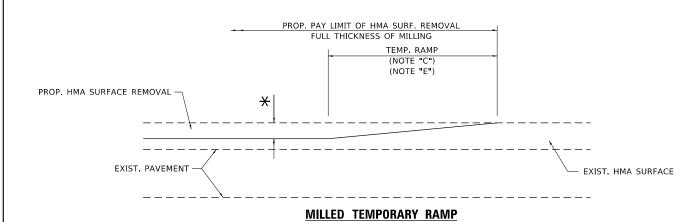

(FOR BUTT JOINT AND HMA TAPER SEE DETAIL BELOW)

OPTION 1

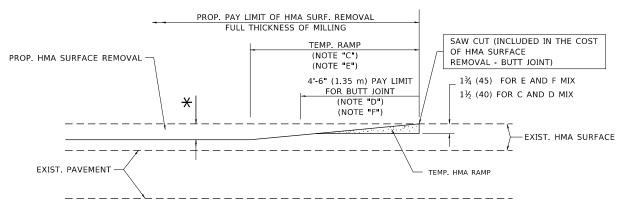


HMA CONSTRUCTED TEMPORARY RAMP

(FOR BUTT JOINT AND HMA TAPER SEE DETAIL BELOW)


OPTION 2


TYPICAL TEMPORARY RAMP

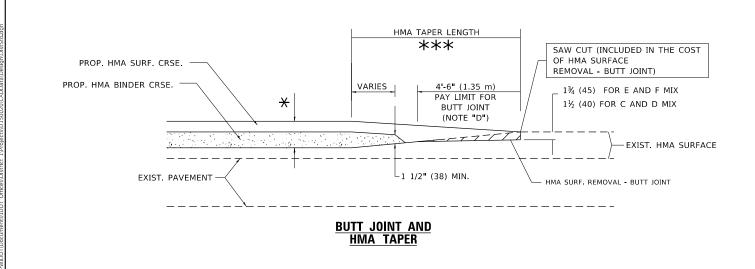

TYPICAL BUTT JOINT AND HMA TAPER FOR MILLING AND RESURFACING

STATE OF ILLINOIS DEPARTMENT OF TRANSPORTATION

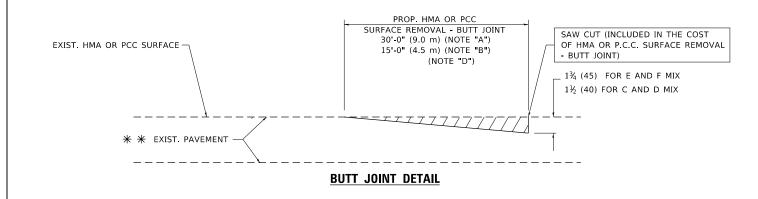

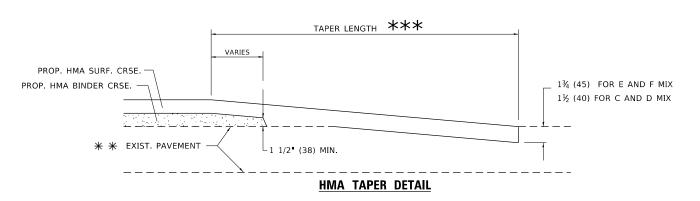

TYPICAL BUTT JOINT AND HMA TAPER FOR RESURFACING ONLY

** PC CONCRETE, HMA OR HMA RESURFACED PAVEMENT.

NOTES

- A. MAINLINE ROADWAYS AND MAJOR SIDE ROADS.
- B. MINOR SIDE ROADS.
- C. THE TEMP. RAMP SHALL BE CONSTRUCTED IMMEDIATELY UPON REMOVAL OF THE EXISTING HMA SURFACE.
- D. THE BUTT JOINT SHALL BE CONSTRUCTED IMMEDIATELY PRIOR TO PLACING THE PROPOSED HMA COURSES.
- E. TAPER THE TEMP. RAMP AT A RATE OF 3'-0" (900 mm) PER 1 INCH (25 mm) OF MILLING THICKNESS.
- F. INSTALLATION AND REMOVAL OF THE 4'-6" (1.35 m) TEMP. RAMP IS INCLUDED IN COST OF HMA SURFACE REMOVAL BUTT JOINT.

 ** SEE TYPICAL SECTIONS FOR MILLING THICKNESS.
- G. SEE ARTICLE 406.08 AND 406.14 OF THE STANDARD SPECIFICATIONS FOR "HMA AND/OR PCC SURFACE REMOVAL, BUTT JOINT".
- *** 20'-0" (6.1 m) PER 1 (25) RESURFACING (NOTE "A") 10'-0" (3.0 m) PER 1 (25) RESURFACING (NOTE "B")


BASIS OF PAYMENT

THE BUTT JOINT WILL BE PAID FOR AT THE CONTRACT UNIT PRICE PER SQUARE YARD (SQUARE METER) FOR "HOT-MIX ASPHALT SURFACE REMOVAL - BUTT JOINT" OR FOR "PORTLAND CEMENT CONCRETE SURFACE REMOVAL-BUTT JOINT".


SCALE: NONE

ALL DIMENSIONS ARE IN INCHES (MILLIMETERS) UNLESS OTHERWISE SHOWN.

STRAIGHT DETECTABLE WARNING UNITS

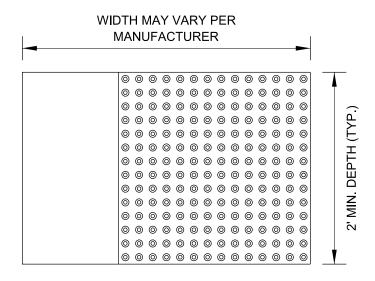

RADIAL DETECTABLE WARNING UNITS

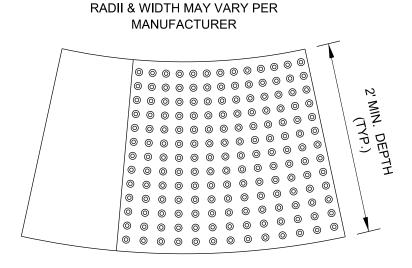


DETECTABLE WARNING UNIT SIZES


- VERIFY ALL DIMENSIONS WITH THE PRODUCT MANUFACTURER.
- IF USING RADIAL UNITS, VERIFY THAT THE CURB RADIUS MATCHES AVAILABLE UNIT RADII WITH THE PRODUCT MANUFACTURER.

GENERAL NOTE:

THE ROWS OF DOMES IN THE DETECTABLE WARNING MATERIAL MUST BE ALIGNED WITH THE PATH OF WHEELCHAIR TRAVEL WHICH IS REQUIRED TO BE PERPENDICULAR TO THE GRADE BREAK AT THE BOTTOM OF THE RAMP TO PERMIT TRACKING BETWEEN DOME ROWS. ON BLENDED TRANSITIONS OR FLUSH TRANSITIONS, WHERE RADIAL UNITS ARE SITUATED ABOUT THE CURB RADIUS, DOME ORIENTATION IS NOT SIGNIFICANT.

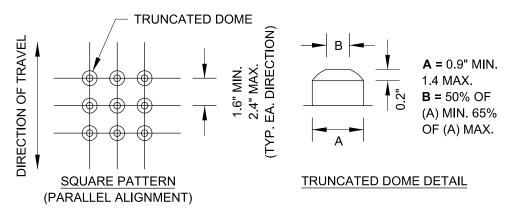


UNIT PATTERN & DOME DETAIL

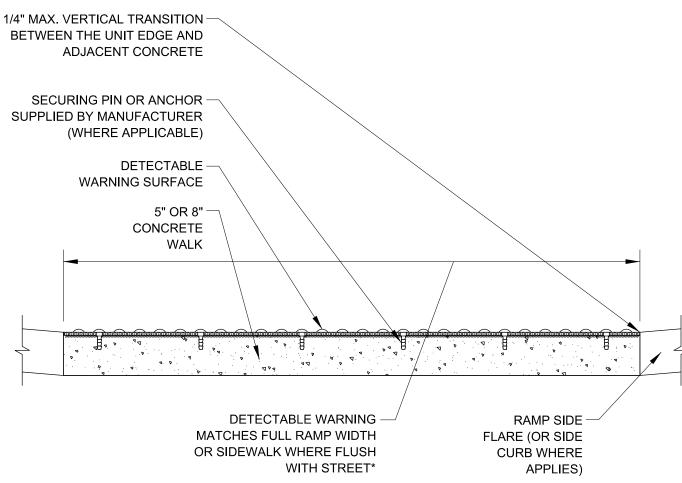

*A BORDER OF 2 INCHES OR LESS AROUND THE DETECTABLE WARNING SURFACE IS
ACCEPTABLE IF REQUIRED FOR PROPER INSTALLATION OF THE DETECTABLE WARNING SURFACE PRODUCT

DETECTABLE WARNING UNIT SECTION

USER NAME = skinneral	DESIGNED -	REVISED -	27.175 25 11.111212		VILLAGE OF ORLAND PARK		F.A.P. RTE	SECTION	COUNTY	TOTAL	SHEET NO.
	DRAWN -	REVISED -	STATE OF ILLINOIS DEPARTMENT OF TRANSPORTATION		DETECTABLE WARNINGS			2020-101-RS&SW	соок	93	80
PLOT SCALE = 100.0000 / in.	CHECKED -	REVISED -			DETECTABLE WARRINGS			BD 58	CONTRACT	NO. 62	2L79
PLOT DATE = 10/15/2020	DATE - 06-20-2017	REVISED -		SCALE: NONE	SHEET 1 OF 1 SHEETS STA.	TO STA.		ILLINOIS FED.	AID PROJECT		

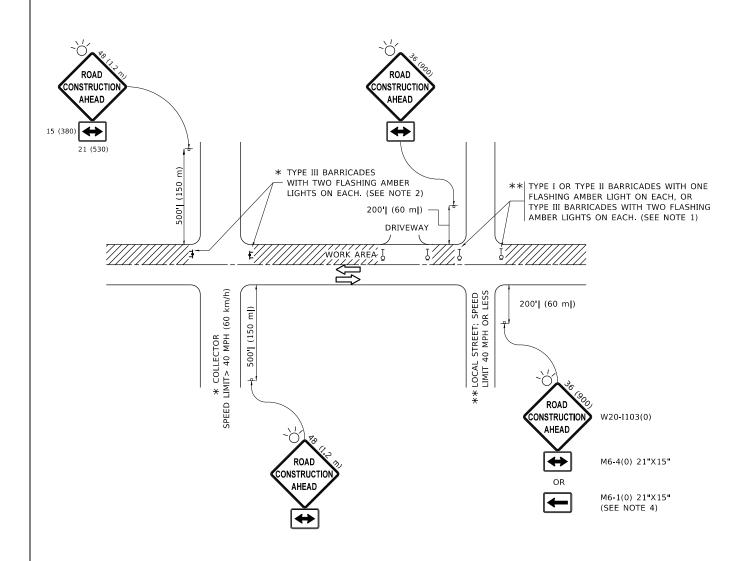

NOTES:

- 1. SIDE ROAD WITH A SPEED LIMIT OF 40 MPH (60 km/h) OR LESS AS SHOWN ON THE DRAWING AND AS DIRECTED BY THE ENGINEER:
- a) ONE "ROAD CONSTRUCTION AHEAD" SIGN 36 x 36 (900x900) WITH A FLASHER MOUNTED ON IT APPROXIMATELY 200' (60 m) IN ADVANCE OF THE MAIN ROUTE.
- b) THE CLOSED PORTION OF THE MAIN ROUTE SHALL BE PROTECTED BY BLOCKING WITH TYPE I, TYPE II OR TYPE III BARRICADES, 1/3 OF THE CROSS SECTION OF THE CLOSED PORTION.
- 2. SIDE ROAD WITH A SPEED LIMIT GREATER THAN 40 MPH (60 km/h) AS SHOWN ON THE DRAWING AND AS DIRECTED BY THE ENGINEER:
- a) ONE "ROAD CONSTRUCTION AHEAD" SIGN 48 x 48 (1.2 m x 1.2 m) WITH A FLASHER MOUNTED ON IT APPROXIMATELY 500' (150 m) IN ADVANCE OF THE MAIN ROUTE.
- THE CLOSED PORTION OF THE MAIN ROUTE SHALL BE PROTECTED BY
 b) BLOCKING WITH TYPE III BARRICADES, 1/2 OF THE CROSS SECTION
 OF THE CLOSED PORTION.
- 3. CONES MAY BE SUBSTITUTED FOR BARRICADES OR DRUMS AT HALF THE SPACING DURING DAY OPERATIONS. CONES SHALL BE A MINIMUM OF 28 (710) IN HEIGHT
- WHEN THE SIDE ROAD LIES BETWEEN THE BEGINNING OF THE MAINLINE
 4. SIGNING AND THE WORK ZONE, A SINGLE HEADED ARROW (M6-1) SHALL
 BE USED IN LIEU OF THE DOUBLE HEADED ARROW (M6-4).

- 5. WHEN WORK IS BEING PERFORMED ON A SIDE ROAD OR DRIVEWAY, FOLLOW THE APPLICABLE STANDARD(S). THE DIRECTIONAL ARROW (M6-1 OR M6-4) SHALL BE COVERED OR REMOVED WHEN NO LONGER CONSISTENT WITH THE TRAFFIC CONTROL SET-UP.
- 6. ADVANCE WARNING SIGNS ARE TO BE OMITTED ON DRIVEWAYS UNLESS OTHERWISE SPECIFIED IN THE PLANS OR BY THE ENGINEER
- 7. THE TRAFFIC CONTROL AND PROTECTION FOR SIDE ROADS, INTERSECTIONS, AND DRIVEWAYS SHALL BE INCLUDED IN THE COST OF SPECIFIED TRAFFIC CONTROL STANDARDS OR ITEMS.


All dimensions are in inches (millimeters) unless otherwise shown.


USER NAME = skinneral	DESIGNED - L.H.A.	REVISED - A. HOUSEH 10-15-96
	DRAWN -	REVISED - T. RAMMACHER 01-06-00
PLOT SCALE = 100.0000 ' / in.	CHECKED -	REVISED - A. SCHUETZE 07-01-13
PLOT DATE = 10/15/2020	DATE - 06-89	REVISED A SCHUETZE 09-15-16


STATE OF ILLINOIS
DEPARTMENT OF TRANSPORTATION

;		-					TION FOR DRIVEWAYS
SCALE: NONE	SHEET	1	OF	1	SHEETS	STA.	TO STA.


F.A.P. RTE.	SEC ⁻ 2020-10	COUNTY	TOTAL SHEETS	SHE NC		
540	TC-10	CONTRACT				
		ILLINOIS	FED. A	ID PROJECT		

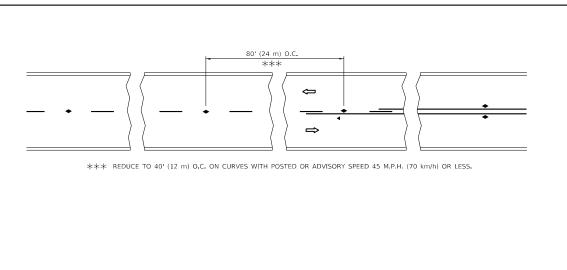


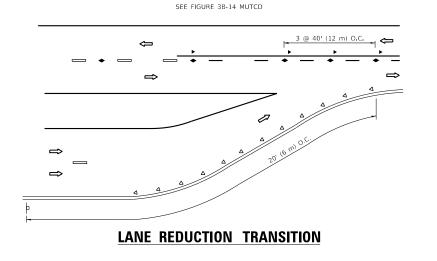

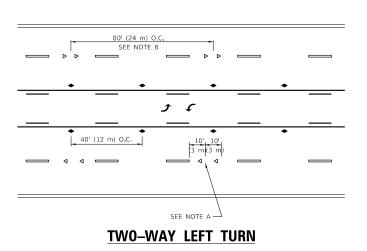


TW0-LANE/TW0-WAY

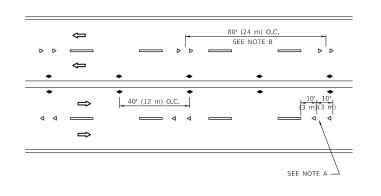


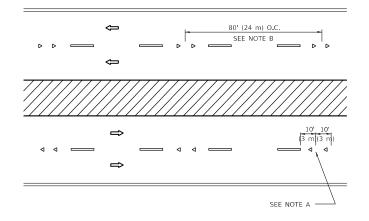

MULTI-LANE/UNDIVIDED



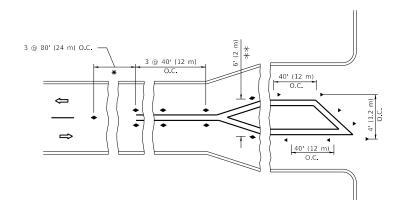

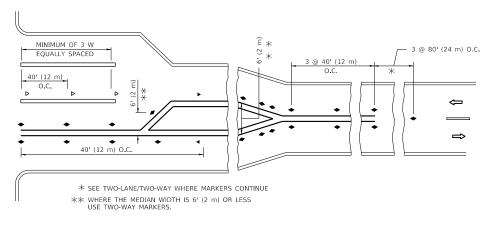

TURN LANES

GENERAL NOTES

- 1. MARKERS USED WITH DASHED LINES SHALL BE CENTERED IN THE GAP BETWEEN SEGMENTS.
- 2. MARKERS USED ADJACENT TO SOLID LINES SHALL BE OFFSET 2 TO 3 (50 TO 75) TOWARD TRAFFIC AS SHOWN.
- 3. MARKERS THROUGH TANGENTS LESS THAN 500' (150 m) IN LENGTH BETWEEN CURVES SHALL BE INSTALLED AT THE LESSER OF THE TWO CURVE SPACINGS.
- 4. MARKERS ARE TO BE USED ADJACENT TO BOTH SOLID WHITE LINES IN DUAL LEFT TURN LANES

LANE MARKER NOTES

- A. USE DOUBLE LANE LINE MARKERS SPACED AS SHOWN.
- B. REDUCE TO 40' (12 m) O.C. ON CURVES WHERE ADVISORY SPEEDS ARE 10 M.P.H (20 km/h) LOWER THAN POSTED SPEEDS.

- 1. DOUBLE LANE LINE MARKERS SHALL BE USED UNLESS SPECIFIED OTHERWISE.
- 2. EXCEPT AS SHOWN ON THE LANE REDUCTION TRANSITION AND FREEWAY EXIT
- INVOLVED.

All dimensions are in inches (millimeters) unless otherwise shown.

JSER NAME = skinneral DESIGNED -REVISED - T. RAMMACHER 03-12-99 REVISED -T. RAMMACHER 01-06-00 DRAWN LOT SCALE = 100.0000 ' / in. HECKED REVISED -C. JUCIUS 09-09-09 C. JUCIUS 07-01-13 PLOT DATE = 10/15/2020 DATE REVISED -

STATE OF ILLINOIS **DEPARTMENT OF TRANSPORTATION**

TYPICAL APPLICATIONS RAISED REFLECTIVE PAVEMENT MARKERS (SNOW-PLOW RESISTANT) SHEET 1 OF 1 SHEETS STA.

SECTION 2020-101-RS&SW COOK 93 82 TC-11 CONTRACT NO. 62L79

SYMBOLS

ONE-WAY AMBER MARKER

TWO-WAY AMBER MARKER


ONE-WAY CRYSTAL MARKER (W/O)


- YELLOW STRIPE

■ WHITE STRIPE

DESIGN NOTES

- RAMP DETAIL, MARKERS ARE NOT TO BE SPECIFIED ON RIGHT EDGE LINES.
- 3. THE EXACT MARKER LIMITS, SPACING, AND COLOR SHALL BE INCLUDED IN
- 4. MARKERS SHOULD NOT BE USED ALONGSIDE CURBS EXCEPT FOR EXTREMELY SHORT SECTIONS OF CURBS WHERE NOT MORE THAN TWO MARKERS WOULD BE

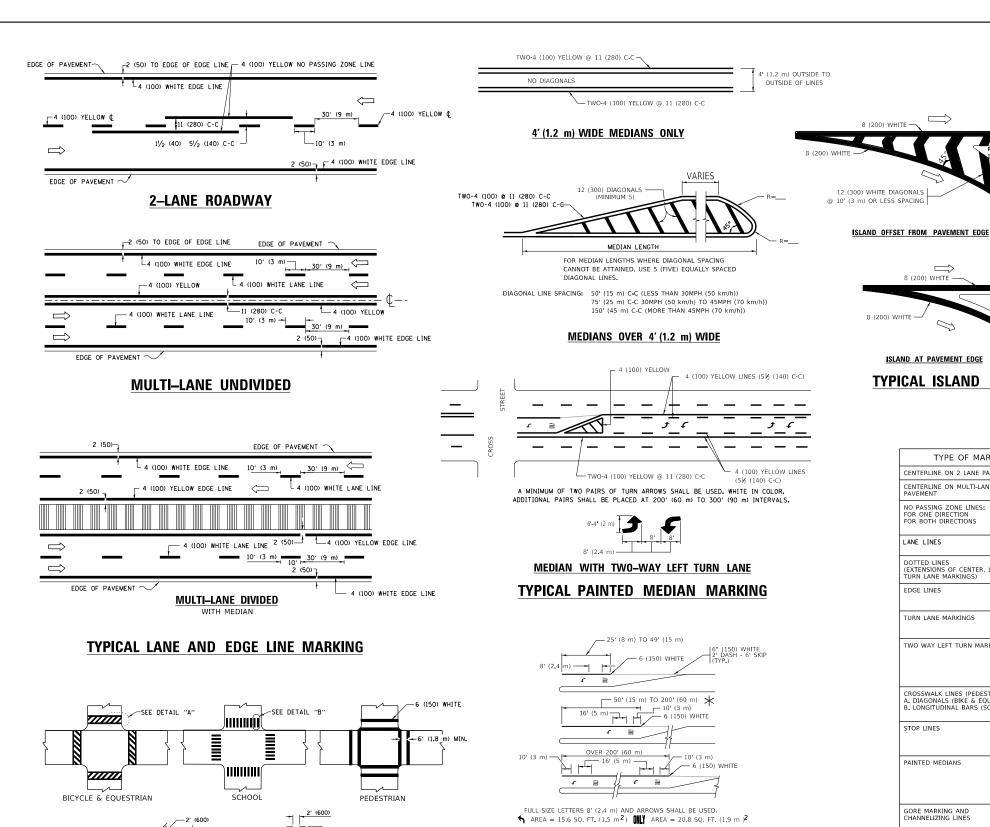

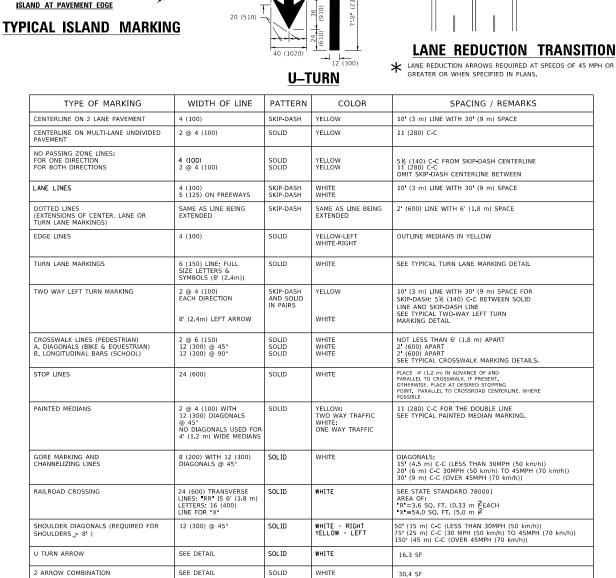

COMBINATION

LEFT AND U-TURN

5'-4" (1620)

32 R (810)

— 2 (50)

2 (50)

RAISED

ISLAND

FOR FURTHER DETAILS ON PAVEMENT MARKING REFER TO STANDARD SPECIFICATIONS FOR ROAD AND BRIDGE CONSTRUCTION AND STATE STANDARD 780001.

All dimensions are in inches (millimeters) unless otherwise shown.

D(FT)

665

750

SPEED LIMIT

45

50

55

-12 (300) WHITE

DETAIL "B"

6 (150) WHITE

TYPICAL CROSSWALK MARKING

* MARKINGS SHALL BE INSTALLED PARALLEL TO THE CENTERLINE OF

DETAIL "A"

THE ROAD WHICH IT CROSSES

STATE OF ILLINOIS DEPARTMENT OF TRANSPORTATION

TURN LANES IN EXCESS OF 400' (120 m) IN LENGTH MAY HAVE AN ADDITIONAL SET OF ARROW - "ONLY" INSTALLED MIDWAY BETWEEN THE OTHER TWO SETS OF

TYPICAL LEFT (OR RIGHT) TURN LANE

TYPICAL TURN LANE MARKING

ARROW - "ONLY".

			DIS	TRICT OF	NE		F.A.P. RTE	SECTION	COUNTY	TOTAL SHEETS	SHEET NO.
	TYPICAL PAVEMENT MARKINGS						348	2020-101-RS&SW	COOK	93	83
								TC-13	CONTRACT	NO. 62	2L79
SHEET 1 OF 2 SHEETS			SHEETS	STA.	TO STA.		TILLINOIS FED AL	D PROJECT			

TURN BAY ENTRANCE AT START OF LANE CLOSURE TAPER

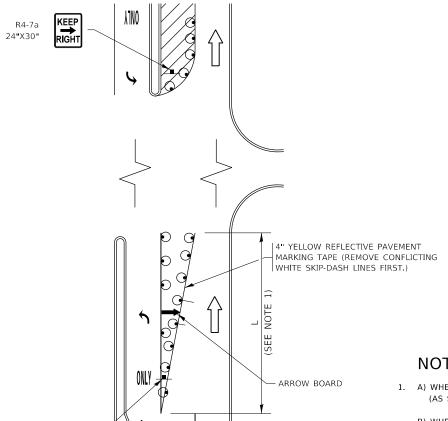


FIGURE 1

SEE DETAIL "A"

LEGEND WORK AREA LANE OPEN TO TRAFFIC ARROW BOARD TYPE I OR II BARRICADE OR DRUM WITH STEADY BURN LIGHT

TYPE I OR II CHECK BARRICADE WITH FLASHING LIGHT


DRUM WITH STEADY BURN LIGHT

SIGN ASSEMBLY

NOTES:

- 1. A) WHEN "L" IS ≤ THE STORAGE LENGTH OF THE TURN LANE (AS SHOWN IN FIG. 1), USE FIGURE 1.
 - B) WHEN "L" IS > THE STORAGE LENGTH OF THE TURN LANE OR THE TURN LANE IS WITHIN THE LANE CLOSURE, USE FIGURE 2.
- 2. CONES MAY BE SUBSTITUTED FOR BARRICADES OR DRUMS AT HALF THE SPACING DURING DAY OPERATIONS. CONES SHALL BE A MINIMUM OF 28 (710) IN HEIGHT.
- 3. LIGHTS WILL NOT BE REQUIRED ON BARRICADES OR DRUMS FOR DAY OPERATIONS. ALL LIGHTS SHALL BE MONODIRECTIONAL.
- 4. REFLECTIVE TEMPORARY PAVEMENT MARKINGS SHALL BE PLACED THROUGHOUT THE BARRICADED AREAS OF EACH TURN BAY AS SHOWN WHERE THE CLOSURE TIME IS GREATER THAN FOURTEEN (14) DAYS.
- 5. THIS APPLICATION ALSO APPLIES WHEN WORK IS BEING PERFORMED IN THE RIGHT LANE(S) AND THE RIGHT TURN BAY IS TO REMAIN OPEN. UNDER THIS CONDITION, "RIGHT TURN LANE" R3-I100R 24 x 24 (600 x 600) AND M6-2R 21 x 15 (530 x 380) SHALL BE USED.
- 6. THESE CONTROLS SHALL SUPPLEMENT MAINLINE TRAFFIC CONTROL FOR LANE CLOSURES.
- 7. THE SIGNS SHALL BE MOUNTED ABOVE THE BARRICADES/DRUMS ON SEPARATE SIGN SUPPORTS THAT MEET NCHRP 350 OR MASH PREOUIREMENTS.
- 8. TRAFFIC CONTROL AND PROTECTION AT TURN BAYS (TO REMAIN OPEN TO TRAFFIC) SHALL BE INCLUDED IN THE COST OF SPECIFIED TRAFFIC CONTROL STANDARDS OR ITEMS.

TURN BAY ENTRANCE WITHIN A LANE CLOSURE

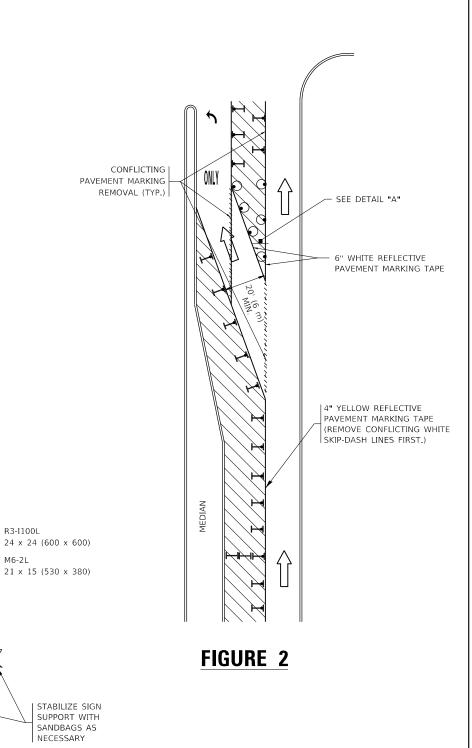

DETAIL A

TURN

All dimensions are in inches (millimeters) unless otherwise shown.


COOK 93 84

CONTRACT NO. 62L79

USER NAME = SKINNERAL	DESIGNED	- 1.	RAMMACHER	09-08-94	KEVISED	-	R. BURU (J9-14-U9
	DRAWN	-	A. HOUSEH	11-07-95	REVISED	- A.	SCHUETZE	07-01-13
PLOT SCALE = 100.0000 / in.	CHECKED	-	A. HOUSEH	10-12-96	REVISED	- A.	SCHUETZE	09-15-16
PLOT DATE = 10/15/2020	DATE	- T.	RAMMACHER	01-06-00	REVISED	-		


STATE OF ILLINOIS **DEPARTMENT OF TRANSPORTATION**

TRAF	FIC CONT	F.A.P. RTE	SECTION	T				
	/TO REMAIN OPEN TO TRAFFIC)							
	(TO REMAIN OPEN TO TRAFFIC)							
SCALE: NONE	SHEET 1	OF 1	SHEETS STA.	TO STA.		ILLINOIS FED.	AII	

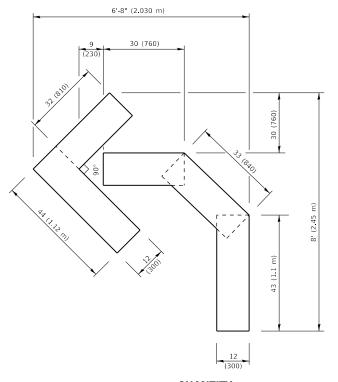


QUANTITY

4 (100) LINE = 45.5 ft. (13.9 m) 15.2 sq. ft. (1.41 sq. m)

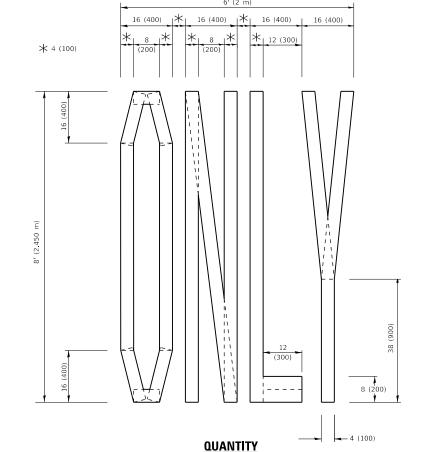

4 (100) LINE = 64.1 ft. (19.5 m) 21.4 sq. ft. (1.99 sq. m)

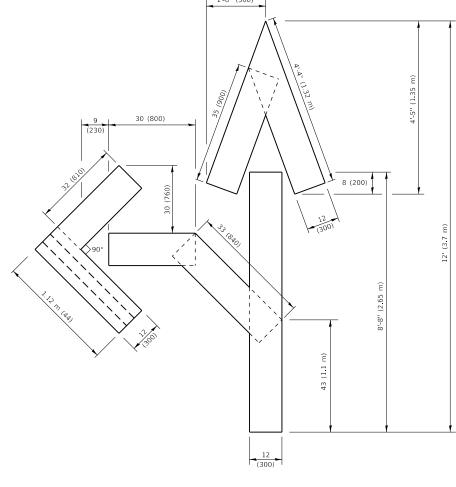


QUANTITY

4 (100) LINE = 82.5 ft. (25.1 m) 27.5 sq. ft. (2.53 sq. m)

NOTE:

ALL QUANTITIES OF PLACEMENT ARE REPRESENTED IN LINEAR FEET OF 4" LINES TO MATCH THE 4" TEMPORARY TAPE PAY ITEM AND REPRESENTS THE TOTAL QUANTITY OF 4" TAPE REQUIRED.

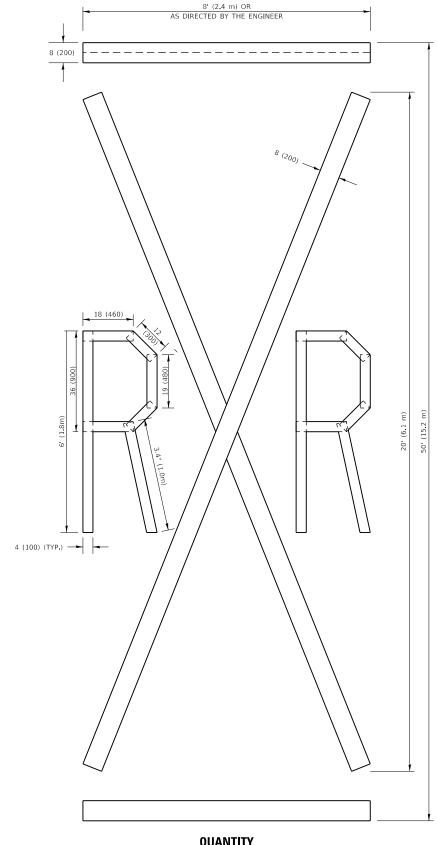

QUANTITY

4 (100) LINE = 225.9 ft. (68.9 m)75.3 sq. ft. (6.99 sq. m)


> All dimensions are in inches (millimeters) unless otherwise shown.

JSER NAME = skinneral DESIGNED -REVISED - T. RAMMACHER 03-02-98 DRAWN REVISED - E. GOMEZ 08-28-00 PLOT SCALE = 100.0000 ' / in. CHECKED -REVISED - E. GOMEZ 08-28-00 PLOT DATE = 10/15/2020 DATE REVISED - A. SCHUETZE 09-15-16 09-18-94

STATE OF ILLINOIS **DEPARTMENT OF TRANSPORTATION**

SHORT TERM PAVEMENT MARKING LETTERS AND SYMBOLS SCALE: NONE SHEET 1 OF 1 SHEETS STA.

SECTION 348 2020-101-RS&SW COOK 93 85 TC-16 CONTRACT NO. 62L79

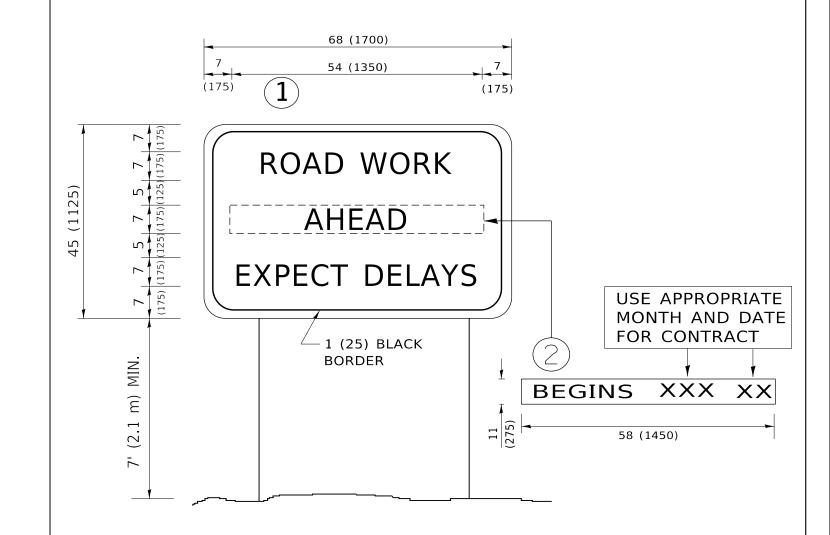

NOTES:

- 1. USE BLACK LETTERING ON ORANGE BACKGROUND.
- 2. ERECT SIGNS IN ADVANCE OF THE LOCATION FOR THE "ROAD CONSTRUCTION AHEAD" SIGN AT LOCATIONS AS DIRECTED BY THE ENGINEER.
- 3. ERECT SIGN 1 WITH INSTALLED PANEL 2 ONE WEEK PRIOR TO THE START OF CONSTRUCTION.
- 4. REMOVE PANEL 2 SOON AFTER THE START OF CONSTRUCTION.
- 5. SEE SPECIAL PROVISION FOR "TEMPORARY INFORMATION SIGNING" FOR ADDITIONAL INFORMATION.
- 6. ONE SIGN ASSEMBLY EQUALS 25.70 SQ. FT. (2.3 SQ. M.)

SCALE: NONE

7. SHALL BE PAID FOR AS TEMPORARY INFORMATION SIGNING.

ALL DIMENSIONS ARE IN INCHES (MILLIMETERS) UNLESS OTHERWISE SHOWN.


USER NAME = skinneral	DESIGNED -	REVISED	- R. MIRS 09-15-97
	DRAWN -	REVISED	- R. MIRS 12-11-97
PLOT SCALE = 100.0000 ' / in.	CHECKED -	REVISED	-T. RAMMACHER 02-02-99
PLOT DATE = 10/15/2020	DATE -	REVISED	- C. JUCIUS 01-31-07

			ART	ERIAL RO)AD		F.A.P. RTE	SECTION		COUNTY	TOTAL SHEETS	SHEE NO.
	INFORMATION SIGN						348	2020-101-RS&SW		СООК	93	86
								TC-22		CONTRACT	NO. 6	2L79
	SHEET	1	OF 1	SHEETS	STA.	TO STA.		ILLINOIS	FED. AI	ID PROJECT		

LOOPS NEXT TO SHOULDERS

PROVIDE A PAVEMENT REPLACEMENT NOTE WHICH SHOULD EQUAL 3' (900 mm) X WIDTH OF PAVED SHOULDER.

* = (600 mm)

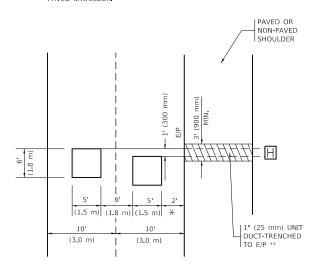

* * UNIT DUCT IS TO BE SHOWN ON PLAN SHEETS

BUT SHALL NOT BE INCLUDED IN THE PAY ITEMS.


SER NAME = skinneral

PLOT DATE = 10/15/2020

LEFT TURN LANES WITH MEDIANS VOLUME DENSITY ("FAR OUT" DETECTION) ON SAME APPROACH

(PROTECTED / PERMITTED LEFT TURN PHASING)

HANDHOLE LOCATION MAY VARY DEPENDING ON GEOMETRICS AND DESIGN OF TRAFFIC SIGNALS. HEAVY-DUTY HANDHOLES TO BE USED WHEN THE MEDIAN IS MOUNTABLE. REFER TO STANDARD 814001 TO ENSURE THAT HANDHOLE

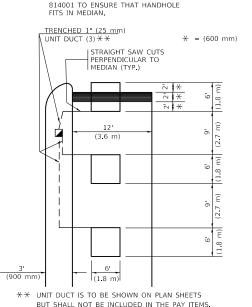


NOTE: DUAL LEFT TURNS NOT SHOWN REFER TO

PLAN SHEET FOR DETECTOR LOOP REPLACEMENT

LEFT TURN LANES WITHOUT MEDIANS

VOLUME DENSITY ("FAR OUT" DETECTION)
ON SAME APPROACH

(PROTECTED / PERMITTED LEFT TURN PHASING)

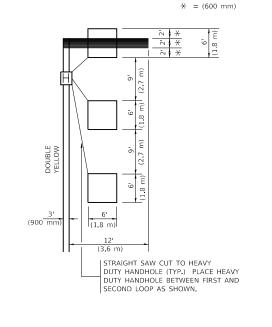


NOTE: DUAL LEFT TURNS NOT SHOWN REFER TO PLAN SHEET FOR DETECTOR LOOP REPLACEMENT

SCALE: NONE

ARTERIAL-VOLUME DENSITY ("FAR OUT" DETECTION) CROSS STREET-NON VOLUME DENSITY ("FAR OUT" DETECTION)

ARTERIAL-VOLUME DENSITY ("FAR OUT" DETECTION)
CROSS STREET-NON VOLUME DENSITY ("UPTIGHT" PRESENCE DETECTION)

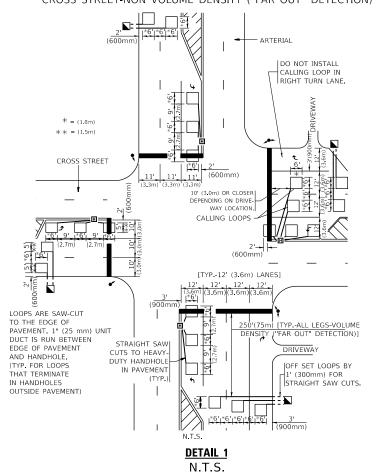

DESIGNED

HECKED

R.K.F.

DRAWN


DATE

REVISED

REVISED

REVISED

REVISED

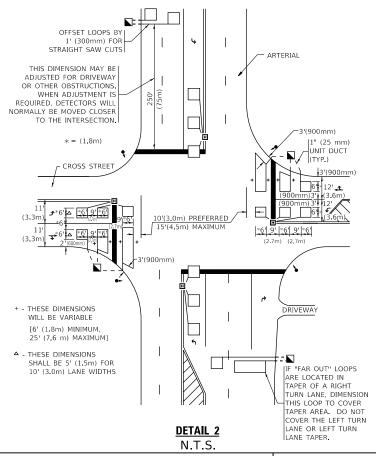

NOTE

VEHICLES LOOP DETECTORS

- * ALL LEAD IN CABLE SHALL BE TWO CONDUCTOR NO. 14 TWISTED, SHIFLDED.
- * EACH DETECTOR LOOP SHALL HAVE ITS OWN SAW CUT FROM THE LOOP TO THE EDGE OF PAVEMENT OR TO A HANDHOLE IN THE PAVEMENT
- * EACH DETECTOR LOOP SHALL HAVE ITS OWN ONE INCH (25 mm) UNIT DUCT BETWEEN THE EDGE OF PAVEMENT AND THE FIRST HANDHOLE OR JUNCTION BOX. EACH UNIT DUCT RUN SHALL BE SHOWN ON THE PLANS BY THE DESIGNER, BUT SHALL NOT BE PAID FOR SEPARATLY. THIS ITEM IS INCIDENTAL TO THE PAY ITEM FOR DETECTOR LOOPS.
- * ONE DIMENSION OF \underline{ALL} DETECTOR LOOPS SHALL BE SIX FEET (1.8 m)
- * EACH LANE OF NON-LOCKING, PRESENCE DETECTION AND EACH LANE OF A DOUBLE LEFT TURN LANE REQUIRES A SEPARATE INDUCTIVE LOOP DETECTOR AND LEAD IN CABLE.
- * WHEN NON-LOCKING, PRESENCE DETECTION IS USED, MORE THAN ONE LOOP PER LANE IS REQUIRED BEHIND THE STOP BAR (i.e. 1-1/2, 1-3/4, 2).
- * WHEN SYSTEM LOOPS ARE REQUIRED ON AN APPROACH OF AN INTERSECTION, THE LOOPS USED FOR VOLUME DENSITY AND INTERSECTION TIMING SHALL ALSO BE USED AS SYSTEM DETECTORS. EACH ONE OF THESE TYPE OF LOOPS REQUIRES A SEPARATE TWO CONDUCTOR NO. 14 TWISTED SHIELDED CABLE AND A SEPARATE INDUCTIVE LOOP DETECTOR WHEN NEW CONTROLLERS ARE UTILIZED. THE DESIGNER SHALL LABEL THESE TYPES OF LOOPS AS "INTERSECTION AND SAMPLING (SYSTEM) DETECTORS" ON THE SIGNAL LAYOUT, THE INTERCONNECT PLAN AND THE SYSTEM CABLE PLAN. WHEN AN EXISTING CONTROLLER IS UTILIZED FOR THIS TYPE OF DETECTION, THE PAY ITEM "INDUCTIVE LOOP DETECTOR WITH SYSTEM OUTPUT" SHOULD BE USED.

PLACEMENT OF DETECTORS

THE FOLLOWING FIGURES REPRESENT THE MOST COMMON DETECTOR LOOP LOCATIONS AND SIZES. ADJUSTMENTS WILL BE NECESSARY FOR SPECIFIC GEOMETRIC CONSIDERATIONS.

LOCATIONS AND DEMENSIONS OF DETECTOR LOOPS ARE REQUIRED ON ALL SIGNAL LAYOUT PLAN SHEETS.

"FAR OUT" DETECTION REFERS TO LOCKING, PRESENCE TYPE DETECTION LOCATED IN THRU LANES, RIGHT TURN LANES, AND RIGHT TURN LANE TAPER AREAS (IF APPLICABLE), USUALLY 250' (75 m) IN ADVANCE OF STOP BARS. "UPTIGHT" DETECTION REFERS TO NON-LOCKING PRESENCE TYPE DETECTION LOCATED IN ALL LANES AND 10'-15' (3.0 m-4.5 m) BEHIND THE CROSSING STREET'S EDGE OF PAVEMENT EXTENDED.

NOTE:

ALL DETAILS AND NOTES SHOWN ARE FROM THE I.D.O.T. DISTRICT 1 TRAFFIC SIGNAL DESIGN GUIDELINES DATED JANUARY 1995

THIS DRAWING HAS BEEN PREPARED TO ASSIST THE RESIDENT ENGINEER FOR ALL ROADWAY RESURFACING OR S.M.A.R.T. PROJECTS WHERE THE DIMENSIONS ARE NOT SHOWN ON THE PLANS AND THE FINAL LOCATIONS FOR CROSSWALKS OR STOP BARS ARE NOT DETERMINED.

STATE OF ILLINOIS DEPARTMENT OF TRANSPORTATION

DISTRICT 1 – DETECTOR LOOP INSTALLATION	F.A.P. RTE	SECTION	COUNTY	TOTAL SHEETS	SHEET NO.	
DETAILS FOR ROADWAY RESURFACING	348	2020-101-RS&SW	соок	93	87	
		TS-07 CONTRACT NO. 62L79				
SHEET 1 OF 1 SHEETS STA. TO STA.		ILLINOIS FED, AID PROJECT				

ADA DETAIL FOR SINGLE PERPENDICULAR CURB RAMPS W/ EXIST. 5% OR LESS RUN. SLOPE PD-01B PD-01C PD-01A MAX. = 5% (1:20) \ LOWER LANDING. ⇒ > PREF. 1.6% ⇒ > PREF. 1.6% » MAX. 2.0% » " " " " " SIDEWALK EXIST SIDEWALK MATCH EXIST \ & \ 2' TYP \ MAX. = 5% (1:20)\ \ MAX. =\ 5% (1:20) SIDEWALK EXIST SIDEWALK SIDEWALK EXIST SIDEWALK MATCH EXIST » » CONSTRUCTION NOTES: LEGEND EXIST. GRASS 1) ALL CROSS SLOPES ARE PREFERRED 1.6% (1:64), MAXIMUM 2% (1:50) EXCEPT WHEN TRANSITIONING TO EXISTING SIDEWALK PROPOSED SIDEWALK PROPOSED SIDE CURB * MATCH EXISTING SIDEWALK WIDTH DETECTABLE WARNINGS JSER NAME = skinneral DESIGNED -REVISED -PROJECT DETAIL FOR SINGLE PERPENDICULAR CURB RAMPS STATE OF ILLINOIS DRAWN REVISED -2020-101-RS&SW 348 COOK 93 88 CHECKED REVISED **DEPARTMENT OF TRANSPORTATION** CONTRACT NO. 62L79 OF SHEETS STA.

